

DEPARTMENT OF HAWAIIAN HOME LANDS
STATE OF HAWAII


CONSTRUCTION PLANS FOR:
VILLAGES OF LEIALI`I, PHASE 1B
LAHAINA, MAUI, HAWAII

TAX MAP KEY: (2) 4-5-21: 020


SUBDIVISION FILE NO. X.XXXX

DWS FILE NO. XX-XX

PROJECT LOCATION MAP

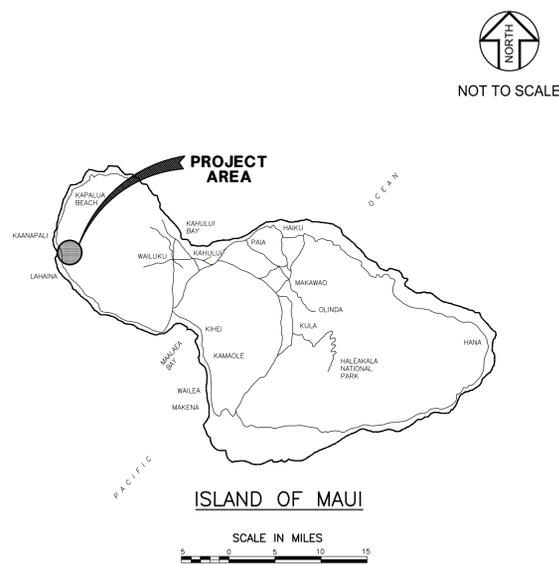

VICINITY MAP

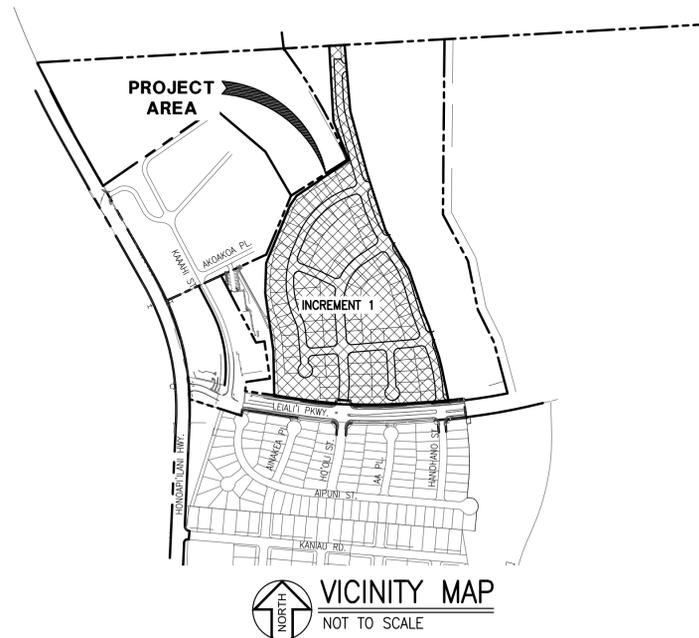

CONSULTANTS

CIVIL ENGINEER:
AUSTIN TSUTSUMI & ASSOCIATES, INC.

ELECTRICAL ENGINEER:
ECM, INC.

SOILS ENGINEER:
HAWAII GEOTECHNICAL ENGINEERS, LTD.

LANDSCAPE ARCHITECT:
HAWAII LAND DESIGN

TELEPHONE ELECTRICAL ENGINEER:
ECM, INC.

APPROVED

DIRECTOR, DEPARTMENT OF PUBLIC WORKS,
COUNTY OF MAUI DATE

DIRECTOR, DEPARTMENT OF WATER SUPPLY,
COUNTY OF MAUI (APPROVAL LIMITED TO
IMPROVEMENTS WHICH WILL BE DEDICATED
TO THE DEPARTMENT OF WATER SUPPLY) DATE

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ABBREVIATIONS

| | | | |
|-------------|-----------------------------|---------------|------------------------|
| Δ | DELTA | LAT. | LATERAL |
| ⊕ | AND | LEN | LENGTH |
| ⊙ | AT | LF | LINEAL FEET |
| A.C. OR A/C | ASPHALT CONCRETE | LP | LIGHT POLE |
| ADJ. | ADJUST | LP | LOW POINT |
| A.U.E | ACCESS AND UTILITY EASEMENT | LT | LEFT |
| AZ | AZIMUTH | MAX | MAXIMUM |
| B | BASELINE | MH | MANHOLE |
| BC | BOTTOM CURB | MON | MONUMENT |
| BEG | BEGIN | | |
| BLDG. | BUILDING | NO. | NUMBER |
| BLK. | BLOCK | NP | NON POTABLE |
| BOTT | BOTTOM | | |
| CATV | CABLE TELEVISION | O.C. | ON CENTER |
| C.B. | CATCH BASIN | O.D. | OUTSIDE DIAMETER |
| C | CENTERLINE | O/S | OFFSET |
| C.L. | CHAIN LINK | | |
| CLR. | CLEAR | PAVT | PAVEMENT |
| CLVRT. | CULVERT | PED | PEDESTRIAN |
| CONC | CONCRETE | PI | POINT OF INTERSECTION |
| CONT | CONTINUATION OR CONTINUOUS | PL | PLACE |
| C.O. | CLEAN OUT | R | PROPERTY LINE |
| | | R | RADIUS |
| ∅, D | DIAMETER | RD. | ROAD |
| DET. | DETAIL | RT | RIGHT |
| D.I. | DRAIN INLET | R.O.W. OR R/W | RIGHT-OF-WAY |
| D/L | DRAIN LINE | | |
| DMH | DRAIN MANHOLE | S | SLOPE |
| DU | DECISION UNITS | SDMH | STORM DRAIN MANHOLE |
| DWY. OR D/W | DRIVEWAY | SF | SQUARE FOOT |
| | | SHT | SHEET |
| EA | EACH | ST | STREET |
| ELEV. OR EL | ELEVATION | STA | STATION |
| EQ | EQUAL | STD | STANDARD |
| EXIST. | EXISTING | STRUCT | STRUCTURE |
| EOP | EDGE OF PAVEMENT | SVC. | SERVICE |
| EP | ELECTRIC POLE | S/W | SIDEWALK |
| | | T | TANGENT |
| FIN | FINISHED | TC | TOP CURB |
| FT | FEET | TEMP | TEMPORARY |
| G.D.I. | GRADED DROP INLET | THK | THICK |
| GRD. | GRADE | TRAV | TRAVERSE |
| HT. | HEIGHT | TRM | TURF REINFORCEMENT MAT |
| HORIZ | HORIZONTAL | TYP | TYPICAL |
| HP | HIGH POINT | | |
| | | W | WIDE |
| INTER. | INTERSECTION | W/ | WITH |
| INV | INVERT ELEVATION | | |

LEGEND

| NEW | EXISTING |
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THIS WORK WAS PREPARED BY ME OR UNDER MY SUPERVISION AND CONSTRUCTION OF THIS PROJECT WILL BE UNDER MY OBSERVATION AS DEFINED IN SECTION 16-115-2, HAWAII ADMINISTRATIVE RULES, DEPARTMENT OF COMMERCE AND CONSUMER AFFAIRS, STATE OF HAWAII, PROFESSIONAL ENGINEERS, ARCHITECTS, SURVEYORS AND LANDSCAPE ARCHITECTS.

LICENSE EXPIRES: APRIL 30, 2024

0 1 2
LINE IS 2 INCHES AT FULL SIZE
(IF NOT 2-INCHES : Scale Accordingly)

DWG. NO. **C-001**

SHEET 2 OF

| REVISION | DATE | BRIEF | MADE BY | APPROVED |
|------------------------------------------------------------------------------------------------------------------------------------------------------------------------------------------------------------------------|------|-------------|---------|------------|
| ATA AUSTIN, TSUTSUMI & ASSOCIATES, INC. ENGINEERS, SURVEYORS • HONOLULU, WAILUKU, HAWAII | | | | |
| DEPARTMENT OF HAWAIIAN HOME LANDS VILLAGES OF LEIALI'I, PHASE 1B TAX MAP KEY: (2) 4-5-21: 020 LAHAINA, MAUI, HAWAII INDEX OF DRAWINGS, ABBREVIATIONS, LEGENDS AND NOTES | | | | |
| DESIGNED BY | DATE | DRAWN BY | DATE | CHECKED BY |
| APPROVED BY | DATE | FIRM NUMBER | DATE | NO. |

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WASTEWATER NOTES

- ALL WASTEWATER LINES AND APPURTENANCES SHALL CONFORM TO STANDARD DETAILS FOR PUBLIC WORKS CONSTRUCTION, DATED SEPTEMBER 1984, OF THE DEPARTMENT OF PUBLIC WORKS, COUNTY OF MAUI.
- ALL SEWERLINE AND APPURTENANCES SHALL FOLLOW THE DESIGN STANDARDS OF THE WASTEWATER RECLAMATION DIVISION, CITY AND COUNTY OF HONOLULU, VOLUMES 1 & 2, DATED JULY 1993 AND JULY 1984 RESPECTIVELY, UNLESS OTHERWISE NOTED.
- ALL WASTEWATER LINES AND APPURTENANCES INSTALLATIONS SHALL CONFORM TO THE STANDARD SPECIFICATIONS FOR PUBLIC WORKS CONSTRUCTION DATED SEPTEMBER 1986. IF ANY CONFLICTS ARISE BETWEEN THE STANDARD DETAILS, DESIGN STANDARDS AND THE STANDARD SPECIFICATIONS, THE STRICTEST STANDARD SHALL APPLY, UNLESS APPROVED OTHERWISE.
- BEFORE CONSTRUCTION COMMENCES, THE CONTRACTOR SHALL SCHEDULE AND DOCUMENT A PRE CONSTRUCTION MEETING WITH ALL AGENCIES HAVING UTILITIES AFFECTED BY THE WORK.
- CONTRACTOR MUST HAVE A SITE SPECIFIC SPILL PREVENTION PLAN (SSSPP) APPROVED BY WWRD PRIOR TO SEWER LINE CONSTRUCTION AND/OR SEWER LATERAL CONNECTION TO EXISTING FACILITIES, OR ANY WORK WITHIN FIVE (5) FEET OF WASTEWATER SYSTEM IMPROVEMENTS.
- THE DEPARTMENT OF ENVIRONMENTAL MANAGEMENT, WASTEWATER RECLAMATION DIVISION, HAS THE RIGHT TO STOP CONSTRUCTION, SHOULD ANY WORK BE FOUND CONTRARY TO THE APPROVED PLANS AND SPECIFICATIONS, OR DETRIMENTAL TO THE PUBLIC INTEREST.
- ALL EXISTING WASTEWATER LINES, WHETHER OR NOT SHOWN ON THE PLANS, IF DAMAGED DURING CONSTRUCTION, SHALL BE REPAIRED BY THE CONTRACTOR AND THE CONTRACTOR SHALL PAY ALL EXPENSES.
- THE CONTRACTOR SHALL NOTIFY THE WASTEWATER RECLAMATION DIVISION FIVE (5) WORKING DAYS PRIOR TO CONNECTION TO ANY EXISTING WASTEWATER LINES WITHIN THE COUNTY OF MAUI.
- SHOULD THE CONTRACTOR EXCAVATE BEYOND THE TRENCH PAY WIDTH, AS SPECIFIED IN THE STANDARD DETAILS FOR PUBLIC WORKS CONSTRUCTION, DATED SEPTEMBER 1984, AND SUCH ACTION RESULTS IN A GREATER LOAD TO THE PIPE, THE CONTRACTOR SHALL PROVIDE, AT THE CONTRACTOR'S EXPENSE, A HIGHER CLASS OF BEDDING MATERIAL THAT WILL WITHSTAND THE ADDED LOAD.
- WASTEWATER LATERALS SHALL BE SIX (6) INCHES IN DIAMETER AT A 2% SLOPE, UNLESS APPROVED OTHERWISE.
- AN ADVANCE RISER CONNECTION SHALL BE INSTALLED AT EACH NEW WASTEWATER LATERAL.
- WHERE THE CLEARANCE BETWEEN A WASTEWATER LINE AND A NEW OR EXISTING UTILITY LINE IS LESS THAN EIGHTEEN (18) INCHES, THE WASTEWATER LINE SHALL BE PROTECTED WITH A REINFORCED CONCRETE JACKET IN ACCORDANCE WITH THE STANDARD DETAILS OF PUBLIC WORKS CONSTRUCTION, DATED SEPTEMBER 1984.
- WHEN THE WASTEWATER MAINS ARE OF A DIFFERENT MATERIAL THAN THE LATERALS, THE CONTRACTOR SHALL INSTALL APPROVED ADAPTERS.
- ALL BACKFILL FOR WASTEWATER TRENCHES SHALL BE COMPACTED IN ONE (1) FOOT LIFTS TO A MINIMUM OF 95% OF ITS MAXIMUM DENSITY.
- WHERE CONSTRUCTION IS TO BE DONE IN PHASES OR INCREMENTS, EACH PHASE OR INCREMENT SHALL BE APPROVED BY WASTEWATER RECLAMATION DIVISION BEFORE THE NEXT PHASE OR INCREMENT IS STARTED.
- ALL WASTEWATER MAINS SHALL PASS A MANDREL TEST AS A CONDITION OF ACCEPTANCE 30 DAYS AFTER COMPLETION AND BACKFILL. THE MANDREL DIAMETER SHALL BE 95% OR MORE OF THE INSIDE DIAMETER OF THE PIPE BEING TESTED.
- "AS BUILT" DRAWINGS SHALL BE SUBMITTED AS A CONDITION FOR THE FINAL ACCEPTANCE OF THE PROJECT.
- PRIOR TO INSPECTION BY CLOSED CIRCUIT TELEVISION (CCTV), ALL WASTEWATER LINES INSTALLED, INCLUDING LATERALS, SHALL BE FLUSHED WITH WATER AND ANY ACCUMULATED CONSTRUCTION DEBRIS AND OTHER FOREIGN MATERIALS SHALL BE REMOVED.
- ALL MAIN WASTEWATER LINES WHICH WILL BE DEDICATED TO THE COUNTY OF MAUI SHALL BE INSPECTED BY CCTV IN STRICT ACCORDANCE WITH DEPARTMENT OF PUBLIC WORKS CCTV POLICY, EFFECTIVE DATE JULY 15, 2001. FINAL ACCEPTANCE OF THE SYSTEM SHALL BE CONTINGENT UPON THE PASSING OF ALL REQUIREMENTS OF THIS POLICY. CCTV RESULTS SHOULD BE SUBMITTED ON DVD PER MEMO DATED OCTOBER 22, 2015. SHOULD ANY OF THE SEWER LATERALS FAIL TO PASS A VISUAL INSPECTION, THEN A CCTV OF ALL LATERALS WILL ALSO BE REQUIRED.
- ANY CONNECTION MADE UNDER THE WATER TABLE WILL REQUIRE CCTV AT HIGH TIDE TO DETERMINE WATER TIGHTNESS IN ACCORDANCE WITH DEPARTMENT OF PUBLIC WORKS CCTV POLICY, EFFECTIVE DATE JULY 15, 2001. FINAL ACCEPTANCE OF THE SYSTEM SHALL BE CONTINGENT UPON THE PASSING OF ALL REQUIREMENTS OF THIS POLICY.
- CONTRACTOR SHALL BE RESPONSIBLE FOR RECORDING THE GPS COORDINATES OF ALL BURIED AND CONCEALED WORK TO BE DEDICATED TO THE COUNTY, AND PROVIDE THE GPS DATA TO THE COUNTY PRIOR TO THE PROJECT'S FINAL ACCEPTANCE. AN ACCURATE GPS POINT EVERY (50) FEET ALONG THE MAIN LINE, AT UTILITY CROSSINGS, AND AT ANY INSTALLED APPURTENANCE (INCLUDING BUT NOT LIMITED TO MANHOLES, BENDS, CONCRETE JACKET, CLEANOUT, PIPE DEVIATIONS, CHANGE IN PIPE SIZE, CRITICAL JOINTS, ARV, ETC.). GPS DATA SHALL BE IN NAD 1983 STATE PLANE HAWAII ZONE 2 FIPS 5102 GRID, AND SHALL BE ACCURATE TO WITHIN ONE (1) FOOT. ACQUIRED GPS SURVEY DATA SHALL BE QUALITY CHECKED BY THE CONTRACTOR PRIOR TO SUBMISSION IN SHAPEFILE (.SHP) FORMAT, FOR COMPATIBILITY WITH MAINSTREAM GIS SOFTWARE SUCH AS ESRI ARCPMAP.

WATER NOTES

- THE CONTRACTOR SHALL NOTIFY THE DEPARTMENT OF WATER SUPPLY (DWS), IN WRITING, ONE (1) WEEK PRIOR TO COMMENCEMENT OF WORK.
- IF CONSTRUCTION OF WATER SYSTEM IMPROVEMENTS WILL AFFECT DWS CONSUMERS, CONTRACTOR SHALL NOTIFY CONSUMERS BY RADIO/NEWSPAPER TWO (2) DAYS BEFORE AND ON DAY OF CONNECTION. CONTRACTOR SHALL ALSO NOTIFY CONSUMERS HOUSE-TO-HOUSE ONE (1) DAY BEFORE CONNECTION WORK.
- ALL MATERIALS USED AND METHODS OF CONSTRUCTION OF WATER SYSTEM FACILITIES SHALL BE IN ACCORDANCE WITH THE LATEST REVISIONS OF DWS WATER SYSTEM STANDARDS. CONTRACTOR SHALL OBTAIN THE LATEST REVISIONS OF THE DWS STANDARD DETAILS BEFORE COMMENCING CONSTRUCTION.
- ALL WATER SYSTEM WORK SHALL BE PERFORMED BY CONTRACTORS POSSESSING VALID STATE OF HAWAII CONTRACTOR'S LICENSES, REGARDLESS OF THE VALUE OF THE WORK.
- CONTRACTOR SHALL FOLLOW ALL LOCAL, STATE, FEDERAL LAWS, RULES AND REGULATIONS REGARDING THE HANDLING, REMOVAL AND DISPOSAL OF ASBESTOS PIPE.
- CONTRACTOR SHALL PROTECT EXISTING WATERLINE DURING COURSE OF CONSTRUCTION AND SUPPORT EXPOSED WATERLINE TO PREVENT ANY MOVEMENT.
- THE EXACT DEPTH AND LOCATION OF EXISTING WATERLINES, SERVICE LATERALS AND OTHER UTILITIES ARE NOT KNOWN. IT SHALL BE THE CONTRACTOR'S RESPONSIBILITY TO LOCATE SAME PRIOR TO TRENCHING FOR THE NEW WATERLINE. THE COST OF LOWERING, RELOCATING OR ADJUSTING EXISTING WATERLINES, SERVICE LATERALS AND APPURTENANCES, WHETHER SHOWN OR NOT SHOWN ON THE CONSTRUCTION PLANS AT THE CONTRACTOR'S EXPENSE.
- PAVEMENT RESURFACING/RESTORATION:
 - CONTRACTOR SHALL VERIFY LOCATION OF EXISTING DWS VALVES AND MANHOLES, WHEN AFFECTED BY THE WORK, PRIOR TO START OF CONSTRUCTION.
 - ALL WATER VALVE AND WATER MANHOLE CONCRETE COLLARS WITHIN THE PROJECT LIMITS SHALL BE DEMOLISHED AND RECONSTRUCTED PER DWS STANDARD DETAIL V12 AND V23, RESPECTIVELY, AT THE CONTRACTOR'S EXPENSE.
 - THE VALVE BOX RISER AND COVER OF ALL WATER VALVES WITHIN THE PROJECT LIMITS SHALL BE REPLACED AT THE CONTRACTOR'S EXPENSE.
 - CONTRACTOR SHALL ADJUST DWS SLIDING VALVE BOX ASSEMBLY AND MANHOLE FRAME AND COVER TO FINISHED GRADE.
 - PRIOR TO PAVEMENT RESURFACING/RESTORATION WORK, THE CONTRACTOR SHALL SCHEDULE INSPECTION WITH DWS.
- ANY SLIDING VALVE BOX ASSEMBLY, MANHOLE COVER, OR CONCRETE COLLAR, WHETHER DISCOVERED DAMAGED OR NOT SPECIFIED ON THE PLANS TO BE ADJUSTED OR REPLACED, SHALL BE REPLACED AT THE CONTRACTOR'S EXPENSE.
- CONTRACTOR SHALL ADJUST TO FINISHED GRADES, ALL UTILITIES (i.e., WATER, SEWER, DRAIN, etc.) AFFECTED BY THE WORK WHETHER SHOWN OR NOT SHOWN ON THE CONSTRUCTION PLANS AT THE CONTRACTOR'S EXPENSE.
- CONTRACTOR SHALL RESTORE ALL ROAD IMPROVEMENTS DISTURBED OR DAMAGED DURING CONSTRUCTION IN ACCORDANCE WITH THE 2005 "HAWAII STANDARD SPECIFICATIONS FOR ROAD AND BRIDGE CONSTRUCTION" AS AMENDED, TO THE SATISFACTION OF THE DEPARTMENT OF PUBLIC WORKS AT THE CONTRACTOR'S EXPENSE. ROAD IMPROVEMENTS INCLUDE, BUT AT NOT LIMITED TO, PAVEMENT, PAVEMENT MARKERS, SHOULDER DRESSING, STRIPING, AND SPEED HUMPS.
- CONCRETE FOR REACTION BLOCKS AND ANCHOR BLOCKS SHALL BE DWS CLASS 2500.
- THE MAXIMUM DISTANCE BETWEEN VALVE NUT AND TOP OF MANHOLE COVER SHALL BE THREE (3) FEET.
- CONTRACTOR SHALL SUBMIT A MATERIALS LIST TO DWS FOR APPROVAL PRIOR TO CONSTRUCTION.
- CONNECTION TO DWS SYSTEM:
 - CONTRACTOR SHALL BE RESPONSIBLE FOR FURNISHING ALL NECESSARY FITTINGS AND OTHER MATERIALS AND EQUIPMENT REQUIRED FOR THE HOOK-UP. CONTRACTOR SHALL VERIFY THE EXACT LOCATION, DEPTH, TYPE, AND CONDITION OF THE EXISTING LINE BEFORE ORDERING MATERIALS FOR THE HOOK-UP. CONTRACTOR SHALL, HOWEVER, CHECK WITH DWS BEFORE EXCAVATING FOR VERIFICATION PURPOSES.
 - WHENEVER FEASIBLE, MECHANICAL JOINT FITTINGS SHALL BE USED FOR BURIED APPLICATIONS, AND FLANGED JOINT FITTINGS SHALL BE USED FOR EXPOSED APPLICATIONS.
 - DWS PERSONNEL MAY BE REQUIRED TO BE PRESENT OR ASSIST WITH CONNECTIONS TO THE EXISTING WATER SYSTEM. THE CONTRACTOR SHALL BE RESPONSIBLE FOR ALL COSTS INCURRED BY DWS FOR SAID WORK.
 - THE CONTRACTOR SHALL BE RESPONSIBLE FOR FURNISHING ALL MATERIAL, EQUIPMENT AND LABOR FOR TRENCH EXCAVATION, BACKFILLING, CLEANING AND CHLORINATION, PAVING, AND OTHER WORK NECESSARY TO COMPLETE THE HOOK-UP, AS DIRECTED BY AND TO THE SATISFACTION OF DWS.

WATER NOTES (CONT.)

- MINIMUM COVER OVER WATER MAIN, 6" DIAMETER OR LARGER, SHALL BE 3'-0". MINIMUM COVER FOR 4" DIAMETER SHALL BE 2'-6". MINIMUM COVER FOR DIAMETERS LESS THAN 4" SHALL BE 1'-6".
- CONTRACTOR SHALL ENSURE INSTALLATION OF WATERLINES, SERVICE LATERALS AND APPURTENANCES HAVE PROPER CLEARANCES FROM EXISTING TREES, WALLS, FENCES, ETC., IN ACCORDANCE WITH CURRENT DWS WATER SYSTEM STANDARDS.
- CONTRACTOR SHALL VERIFY AND MAINTAIN 18" MINIMUM CLEARANCE WITH WATERLINE OR SERVICE LATERAL CROSSING OVER EXISTING SEWERLINE OR SERVICE LATERAL. INSTALL REINFORCED CONCRETE JACKET AROUND SEWERLINE WHERE SEWER IS ABOVE WATERLINE OR LESS THAN 18" BELOW WATERLINE. THE LENGTH OF JACKET REQUIRED SHALL BE AS SPECIFIED IN TABLE 100-5 OF THE DWS STANDARDS. PROVIDE 6" MINIMUM CLEARANCE FROM OUTSIDE JACKET TO WATERLINE OR SERVICE LATERAL. STANDARD CONCRETE JACKET DETAILS FOR SEWERLINE AS SPECIFIED BY THE DEPARTMENT OF PUBLIC WORKS STANDARDS SHALL BE FOLLOWED.
- CONTRACTOR SHALL HAVE LICENSED SURVEYOR STAKE OUT WATERLINE BASELINE STATIONING, RIGHT-OF-WAY LIMITS, PROPERTY LINES, AND EASEMENT LINES TO ENSURE PROPER LOCATION OF WATER SYSTEM IMPROVEMENTS.
- BOLTS FOR EXPOSED FLANGED DUCTILE IRON PIPE JOINTS SHALL BE EITHER SILICON BRONZE BOLTS & NUTS OR 316 STAINLESS STEEL BOLTS WITH THE HEAVY-DUTY STAINLESS STEEL NUTS (ONLY) FURNISHED WITH TRIPAC 2000 BLUE COATING SYSTEM. ANTI-SEIZE SHALL NOT BE USED. T-BOLTS FOR DUCTILE IRON MECHANICAL JOINT (MJ) PIPE AND FITTING CONNECTIONS IN UNDERGROUND SITUATIONS SHALL BE ONE OF THE FOLLOWING SYSTEMS:
 - 316 STAINLESS STEEL T-BOLTS WITH HEAVY-DUTY STAINLESS STEEL NUTS (ONLY) FURNISHED WITH TRIPAC 2000 COATING SYSTEM. ANTI-SEIZE SHALL NOT BE USED.
 - COR-TEN T-BOLTS AND NUTS WITH HIGH GRADE ZINC SACRIFICIAL ANODES, EQUIVALENT TO "DURATRON" SACRIFICIAL "SAC-NUT" MODULES, INSTALLED ON THE NUTS FOR ALL STANDARD COR-TEN T-BOLTS.
 - COR-TEN T-BOLTS AND NUTS BOTH FACTORY COATED WITH TRIPAC 2000 BLUE COATING SYSTEM BY "TRIPAC FASTENERS".
 ALL HOT FORGED STAINLESS STEEL BOLTS ARE REQUIRED TO BE PASSIVATED PER ASTM A380. MANUFACTURER CERTIFICATES ARE REQUIRED FOR PROOF WITH EACH SHIPMENT.
- CONTRACTOR SHALL FURNISH AND INSTALL DUCTILE IRON NIPPLES FOR COMPLETE INSTALLATION OF THE WATERLINE, WHETHER SHOWN OR NOT SHOWN ON THE CONSTRUCTION PLANS, AT THE CONTRACTOR'S EXPENSE.
- CONTRACTOR SHALL FURNISH TEMPORARY CLEANOUTS WHEN NECESSARY TO TEST, FLUSH, AND CHLORINATE THE WATERLINE AT THE CONTRACTOR'S EXPENSE.
- CONTRACTOR SHALL REMOVE AND DISPOSE OF ALL PORTIONS OF ABANDONED WATERLINES THAT ARE EXPOSED OR WITHIN 12-INCHES BELOW THE GROUND SURFACE AT THE CONTRACTOR'S EXPENSE.
- ALL BURIED METALS, INCLUDING COPPER PIPES, SHALL BE WRAPPED WITH POLY-WRAP. FOR ALL BURIED INSTALLATIONS OF DUCTILE IRON PIPE AND FITTINGS, POLY-WRAP IS REQUIRED EXCEPT WITHIN CONCRETE JACKETS.
- LUBRICATE HYDRANT NOZZLE THREADS WITH NON-TOXIC GREASE.
- CONTRACTOR SHALL PAINT AND NUMBER THE FIRE HYDRANT(S). NUMBERING TO BE FURNISHED BY DWS.
- WATER MAINS AND APPURTENANCES SHALL BE SUBJECT TO HYDROSTATIC TESTING IN ACCORDANCE WITH THE LATEST REVISION OF AWWA C600, UNDER THE "HYDROSTATIC TESTING" SECTION, TO A PRESSURE OF AT LEAST 1.5 TIMES THE WORKING PRESSURE, UNLESS OTHERWISE STATED IN THE CONSTRUCTION DOCUMENTS OR LIMITED BY THE PRESSURE RATING OF EQUIPMENT. THE PRESSURE TEST AND LEAKAGE TEST SHALL BE PERFORMED AT 225 POUNDS PER SQUARE INCH PRESSURE.
- DEVELOPER SHALL SUBMIT A COST LIST ALONG WITH AN AFFIDAVIT FOR THE WATER SYSTEM PRIOR TO ACCEPTANCE.
- CONTRACTOR SHALL SUBMIT (1) SET OF RECORD DRAWINGS VIA A CONSULTANT PRIOR TO ACCEPTANCE OF THE WATER SYSTEM. AN ELECTRONIC IMAGE FILE IN PDF FORMAT AT FULL PAGE SIZE (24"x36") SHALL BE PROVIDED TO THE DWS FOR ALL PROJECTS.

CHLORINATION OF WATER SYSTEMS

- WATER MAINS AND APPURTENANCES SHALL BE DISINFECTED IN ACCORDANCE WITH AWWA C651. ALL PROCEDURES AND MATERIALS (LIQUID CHLORINE OR CALCIUM HYPOCHLORITE) USED FOR THE CHLORINATION OF THE PROJECT SHALL CONFORM TO AWWA REQUIREMENTS.
- PRIOR TO CHLORINATION, THE PROJECT PIPELINES SHALL BE THOROUGHLY CLEANED. CLEANING OF LINES 8" AND LARGER SHALL BE BY PIGGING USING FOAM PIGS. SMALLER LINES CAN BE FLUSHED IN ACCORDANCE WITH AWWA REQUIREMENTS IF ADEQUATE WATER SUPPLY IS PROVIDED. OTHERWISE BY PIGGING. THE CONTRACTOR SHALL SUBMIT HIS PLAN FOR PIPELINE CLEANING, INCLUDING FITTING REQUIREMENTS FOR PIGGING, FOR APPROVAL PRIOR TO PROCEEDING.
- THE INTERIOR SURFACE OF THE PROJECT SHALL BE EXPOSED TO THE CHLORINATING SOLUTION FOR A MINIMUM OF 24 HOURS AND THE CHLORINE RESIDUAL SHALL NOT BE LESS THAN 10 PPM AFTER SUCH TIME.
- SHOULD CALCIUM HYPOCHLORITE BE USED, NO SOLID AND/OR UNDISSOLVED PORTION OF THE COMPOUND SHALL BE INTRODUCED INTO ANY SECTION OF THE PROJECT TO BE CHLORINATED.
- AT THE END OF THE 24-HOUR DISINFECTION PERIOD, REPRESENTATIVE SAMPLES SHALL BE TAKEN AND ANALYZED TO ASSURE A CHLORINE RESIDUAL OF AT LEAST 10 PPM. MEASUREMENTS FOR CHLORINE RESIDUAL TESTS SHALL BE BY A TRAINED, QUALIFIED TESTER APPROVED BY THE DIRECTOR.
- SHOULD THE RESULTS INDICATE ADEQUATE CHLORINATION, THE PROJECT SHALL BE THOROUGHLY FLUSHED AND FILLED WITH POTABLE WATER FROM THE EXISTING POTABLE WATER SYSTEM AND AGAIN TESTED FOR CHLORINE RESIDUAL. THE FLUSHING SHALL BE CONSIDERED ADEQUATE IF THE TEST RESULTS INDICATE THAT THE WATER IN THE PROJECT HAS A COMPARABLE CHLORINE RESIDUAL AS THE WATER IN THE EXISTING SYSTEM.
- FOLLOWING THE ACCEPTABLE FLUSHING OF THE HIGH CONCENTRATION CHLORINE SOLUTION, TWO CONSECUTIVE SETS OF ACCEPTABLE SAMPLES SHALL BE TAKEN AT LEAST 24 HOURS APART FROM REPRESENTATIVE POINTS IN THE PROJECT AND SUBJECTED TO MICROBIOLOGICAL TESTS PERFORMED BY A CERTIFIED LABORATORY APPROVED BY THE DEPARTMENT OF HEALTH. AT LEAST ONE SET OF SAMPLES SHALL BE COLLECTED AND TESTED FROM EVERY 1,200 FEET OF THE NEW WATER MAIN, PLUS ONE SET FROM THE END OF THE LINE AND AT LEAST ONE SET FROM EACH BRANCH. POSITIVE RESULTS WILL NOT BE ACCEPTABLE AND THE ENTIRE CHLORINATION PROCESS WILL BE REPEATED.
- ANALYSIS FOR RESIDUAL CHLORINE SHALL BE MADE IN ACCORDANCE WITH "STANDARD METHODS FOR THE EXAMINATION OF WATER AND WASTEWATER", AMERICAN PUBLIC HEALTH ASSOCIATION, CURRENT EDITION.
- MICROBIOLOGICAL TESTS SHALL BE MADE IN ACCORDANCE WITH "STANDARD METHODS FOR THE EXAMINATION OF WATER AND WASTEWATER", AMERICAN PUBLIC HEALTH ASSOCIATION, CURRENT EDITION.
- THE DEVELOPER/CONTRACTOR SHALL BE RESPONSIBLE FOR ALL COSTS ASSOCIATED WITH ALL OF THE FOREGOING.

TEMPORARY EROSION CONTROL MEASURES

- TEMPORARY GROUND COVER SHALL BE APPLIED WITHIN A PERIOD OF 14 CALENDAR DAYS AFTER THE SITE HAS BEEN GRADED, OR BARED OF VEGETATION, OR IF FINAL GRADING OF THE SITE WILL BE SUSPENDED FOR MORE THAN 21 CALENDAR DAYS. ALL COST FOR MAINTAINING IRRIGATING AND REMOVING TEMPORARY EROSION CONTROL MEASURES WILL BE BORNE BY THE CONTRACTOR.
- THE CONTRACTOR MAY USE HYDRO-MULCH TO APPLY THE TEMPORARY GROUND COVER.
- TEMPORARY GROUND COVER SHALL CONSIST OF 2,000 LBS. PER ACRE WOOD CELLULOSE FIBER MULCH AND 65 LBS. PER ACRE TACKIFIER.

PERMANENT EROSION CONTROL MEASURES

- THE CONTRACTOR SHALL GRASS ALL EXPOSED AREAS THAT HAVE BEEN CONSTRUCTED TO FINAL GRADES WITHIN A PERIOD OF 14 CALENDAR. ALL COSTS FOR MAINTAINING AND WATERING PERMANENT EROSION CONTROL MEASURES WILL BE BORNE BY THE CONTRACTOR.
- THE CONTRACTOR MAY USE HYDRO-MULCH TO APPLY THE PERMANENT GROUND COVER.
- PERMANENT BERMUDA GROUND COVER SHALL CONSIST OF 75 LBS. PER ACRE BERMUDA GRASS, 50 LBS. PER ACRE RYE GRASS, 6,000 LBS. PER ACRE GYPSUM BASED GEOBINDER, 2,000 LBS. PER ACRE WOOD CELLULOSE FIBER MULCH, AND 400 LBS. PER ACRE 10-30-10 FERTILIZER.
- PERMANENT GROUND COVER ALONG NATURAL DRAINAGEWAYS SHALL CONSIST OF 100 LBS. PER ACRE BERMUDA GRASS, 50 LBS. PER ACRE RYE GRASS, 1,500 LBS. PER ACRE WOOD CELLULOSE FIBER MULCH, 400 LBS. PER ACRE 10-30-10 FERTILIZER, AND PERMANENT EROSION CONTROL/TURF REINFORCEMENT MATTING.

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ADRIENNE W. L.H. HOAG
LICENSED PROFESSIONAL ENGINEER
No. 6378
HAWAII, U.S.A.

THIS WORK WAS PREPARED BY ME OR UNDER MY SUPERVISION AND CONSTRUCTION OF THIS PROJECT WILL BE UNDER MY OBSERVATION AS DEFINED IN SECTION 16-115-2, HAWAII ADMINISTRATIVE RULES, DEPARTMENT OF COMMERCE AND CONSUMER AFFAIRS, STATE OF HAWAII. PROFESSIONAL ENGINEERS, ARCHITECTS, SURVEYORS AND LANDSCAPE ARCHITECTS.

LICENSE EXPIRES: APRIL 30, 2024

0 1 2
LINE IS 2 INCHES AT FULL SIZE
(IF NOT 2-INCHES : Scale Accordingly)


DWG. NO. **C-002**

SHEET 3 OF

| | | | | |
|--------------------------------------------------------------------------------------------------------------------------------------------------------------------------|---------------------|------------------------------|--------------------------------------|----------|
| REVISION | DATE | BRIEF | MADE BY | APPROVED |
| AUSTIN, TSUTSUMI & ASSOCIATES, INC. ENGINEERS, SURVEYORS • HONOLULU, WAILUKU, HAWAII | | | | |
| DEPARTMENT OF HAWAIIAN HOME LANDS VILLAGES OF LEIALI'I, PHASE 1B TAX MAP KEY: (2) 4-5-21: 020 LAHAINA, MAUI, HAWAII CONSTRUCTION NOTES | | | | |
| DESIGNED BY KM | DRAWN BY ATA | CHECKED BY AW | APPROVED BY _____ SUBMITTED BY _____ | |
| DATE _____ | | FIRM NUMBER _____ DATE _____ | | |

| | | | |
|------|--------|--------|-----|
| FILE | POCKET | FOLDER | NO. |
| | | | |

TRUE NORTH
SCALE: 1"=80'

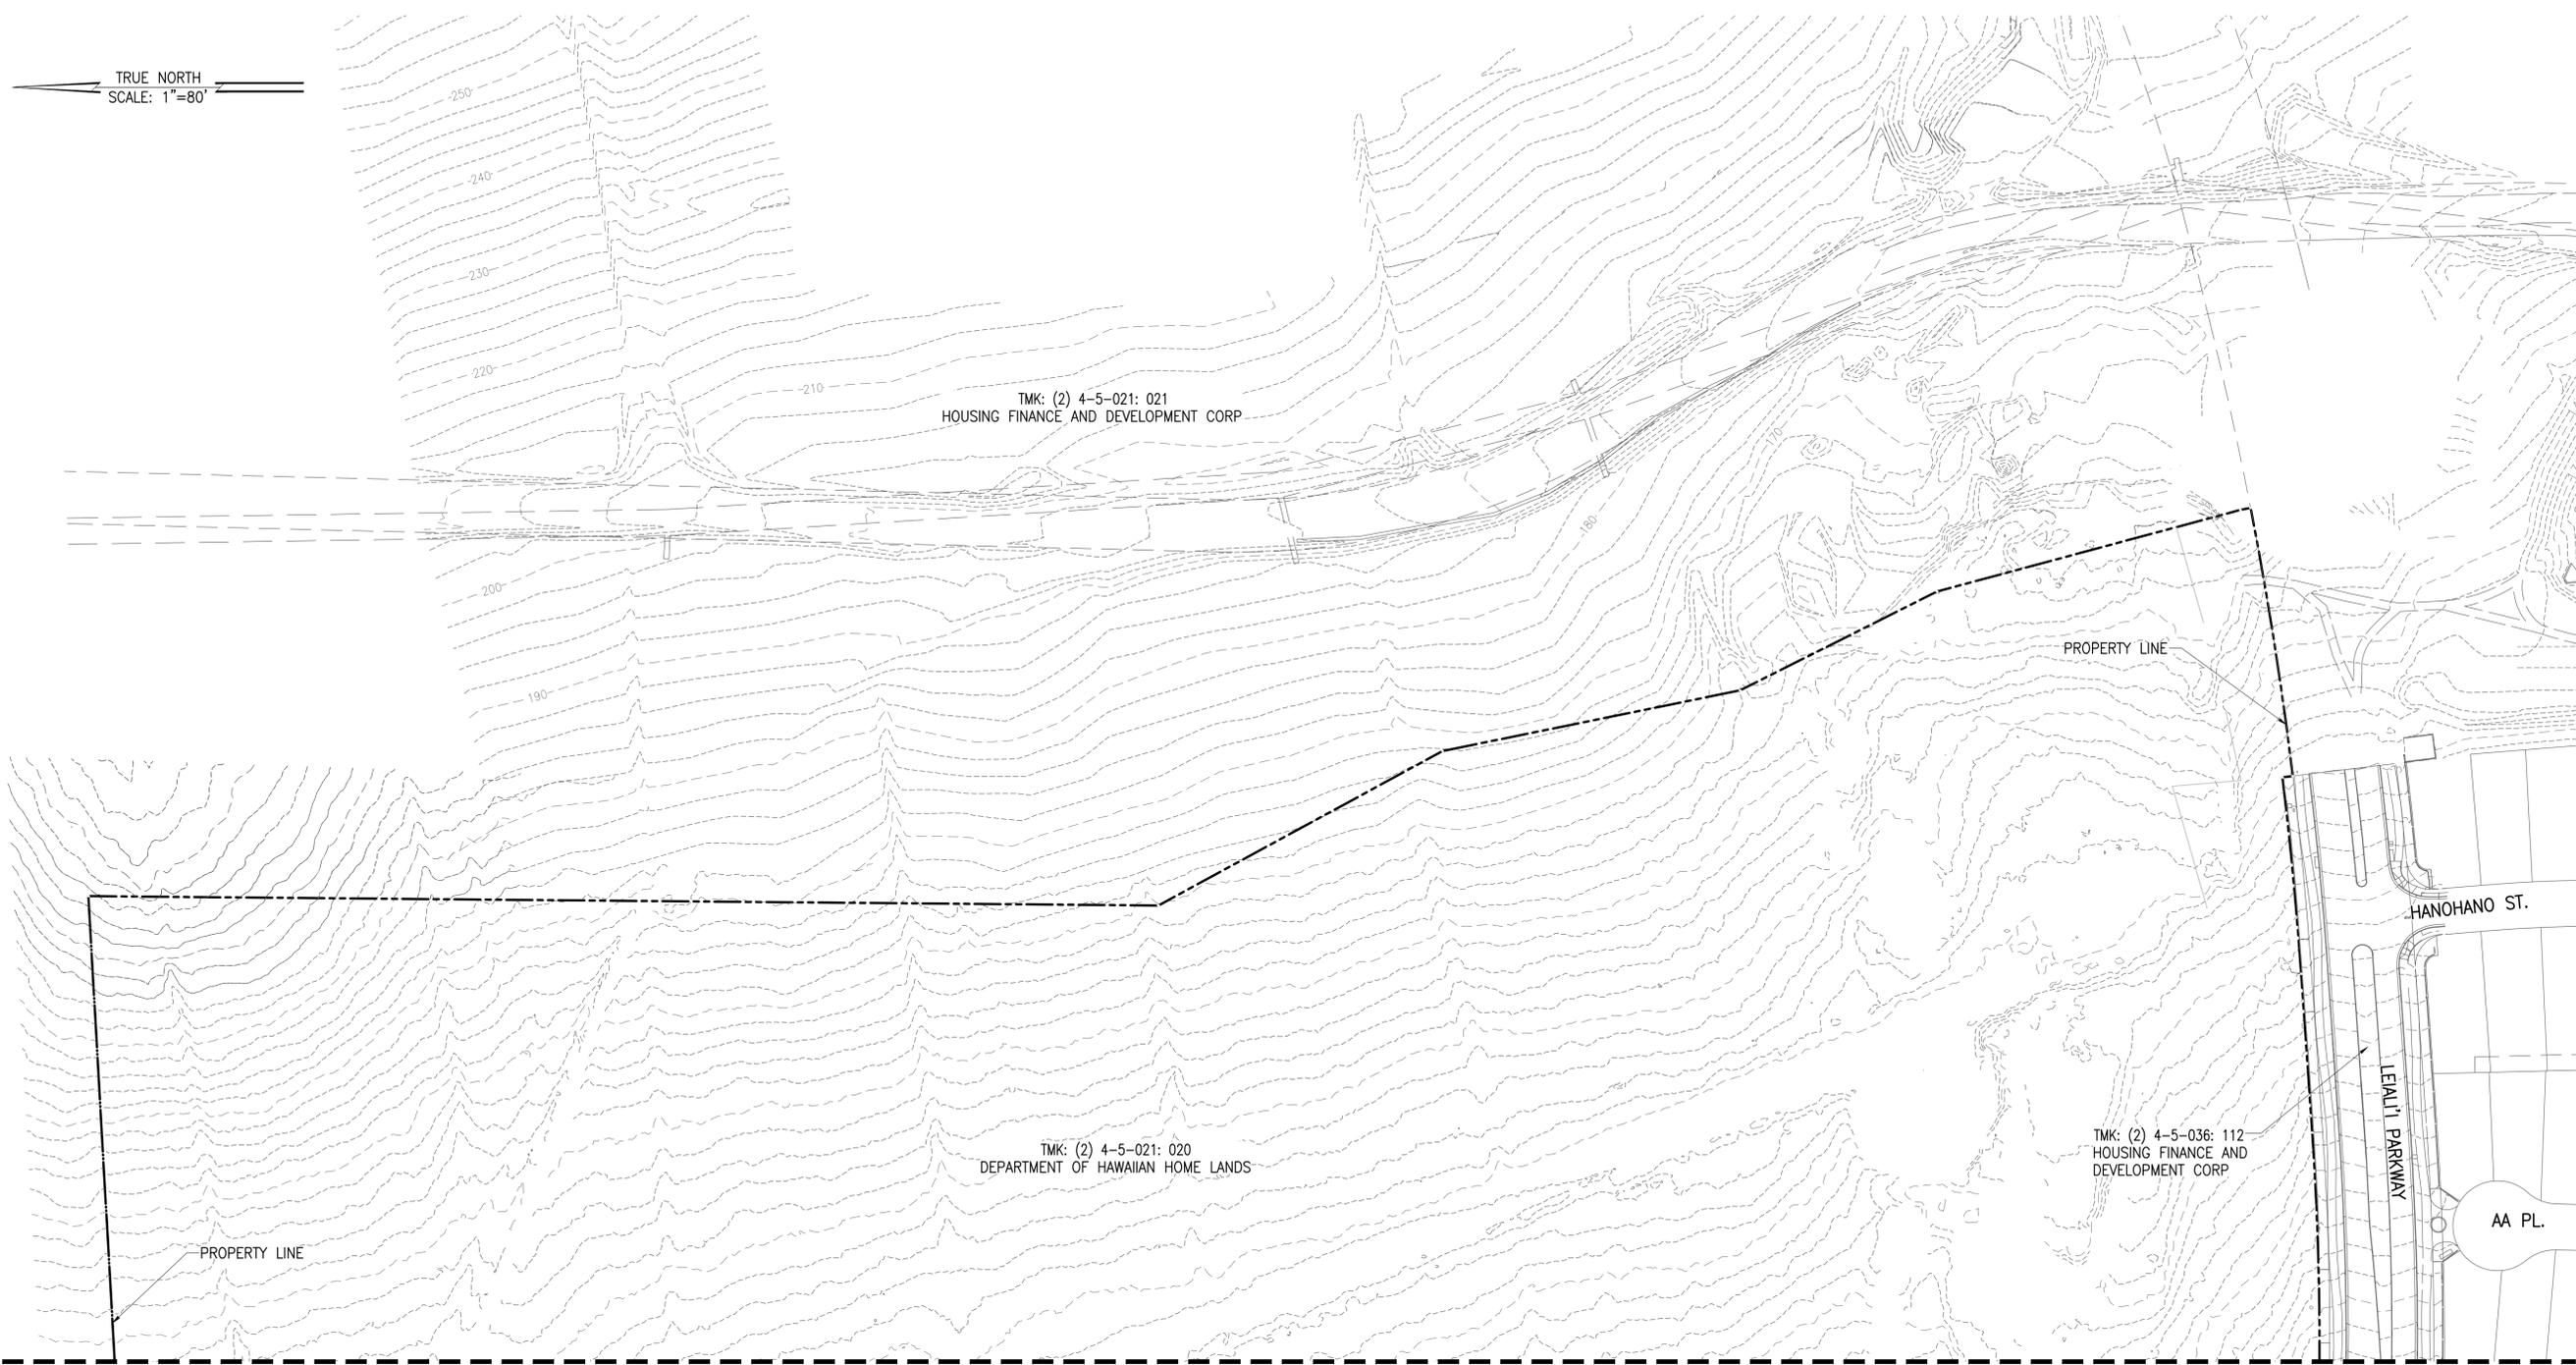

FOR CONTINUATION, SEE DWG. C-004
MATCH LINE

TOPOGRAPHIC AND BOUNDARY PLAN - 1
SCALE: 1"=80'



THIS WORK WAS PREPARED BY ME OR UNDER MY SUPERVISION AND CONSTRUCTION OF THIS PROJECT WILL BE UNDER MY OBSERVATION AS DEFINED IN SECTION 16-115-2, HAWAII ADMINISTRATIVE RULES, DEPARTMENT OF COMMERCE AND CONSUMER AFFAIRS, STATE OF HAWAII, PROFESSIONAL ENGINEERS, ARCHITECTS, SURVEYORS AND LANDSCAPE ARCHITECTS.

LICENSE EXPIRES: APRIL 30, 2024

LINE IS 2 INCHES AT FULL SIZE
(IF NOT 2-INCHES : SCALE ACCORDINGLY)

DWG. NO. **C-003**

SHEET 4 OF

| REVISION | DATE | BRIEF | MADE BY | APPROVED | |
|-----------------------------------------------------------------------------------------------------------------------------------------------------------------------------------------------------------------------------------------------------------------------------------------------------|--------------|----------|---------|------------|----|
| <p>ATA AUSTIN, TSUTSUMI & ASSOCIATES, INC. ENGINEERS, SURVEYORS • HONOLULU, WAILUKU, HAWAII</p> <p>DEPARTMENT OF HAWAIIAN HOME LANDS</p> <p>VILLAGES OF LEALI'I, PHASE 1B</p> <p>TAX MAP KEY: (2) 4-5-21: 020 LAHAINA, MAUI, HAWAII</p> <p>TOPOGRAPHIC AND BOUNDARY PLAN - 1</p> | | | | | |
| DESIGNED BY | KM | DRAWN BY | ATA | CHECKED BY | AW |
| APPROVED BY | SUBMITTED BY | | | | |
| DATE | FIRM NUMBER | DATE | | | |


A:\2018\18-522\topo\dwg\c-003_topo.dwg and boundary plan - 1.dwg

| FILE | POCKET | FOLDER | NO. |
|------|--------|--------|-----|
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TRUE NORTH
SCALE: 1"=80'

FOR CONTINUATION, SEE DWG. C-003

MATCH LINE

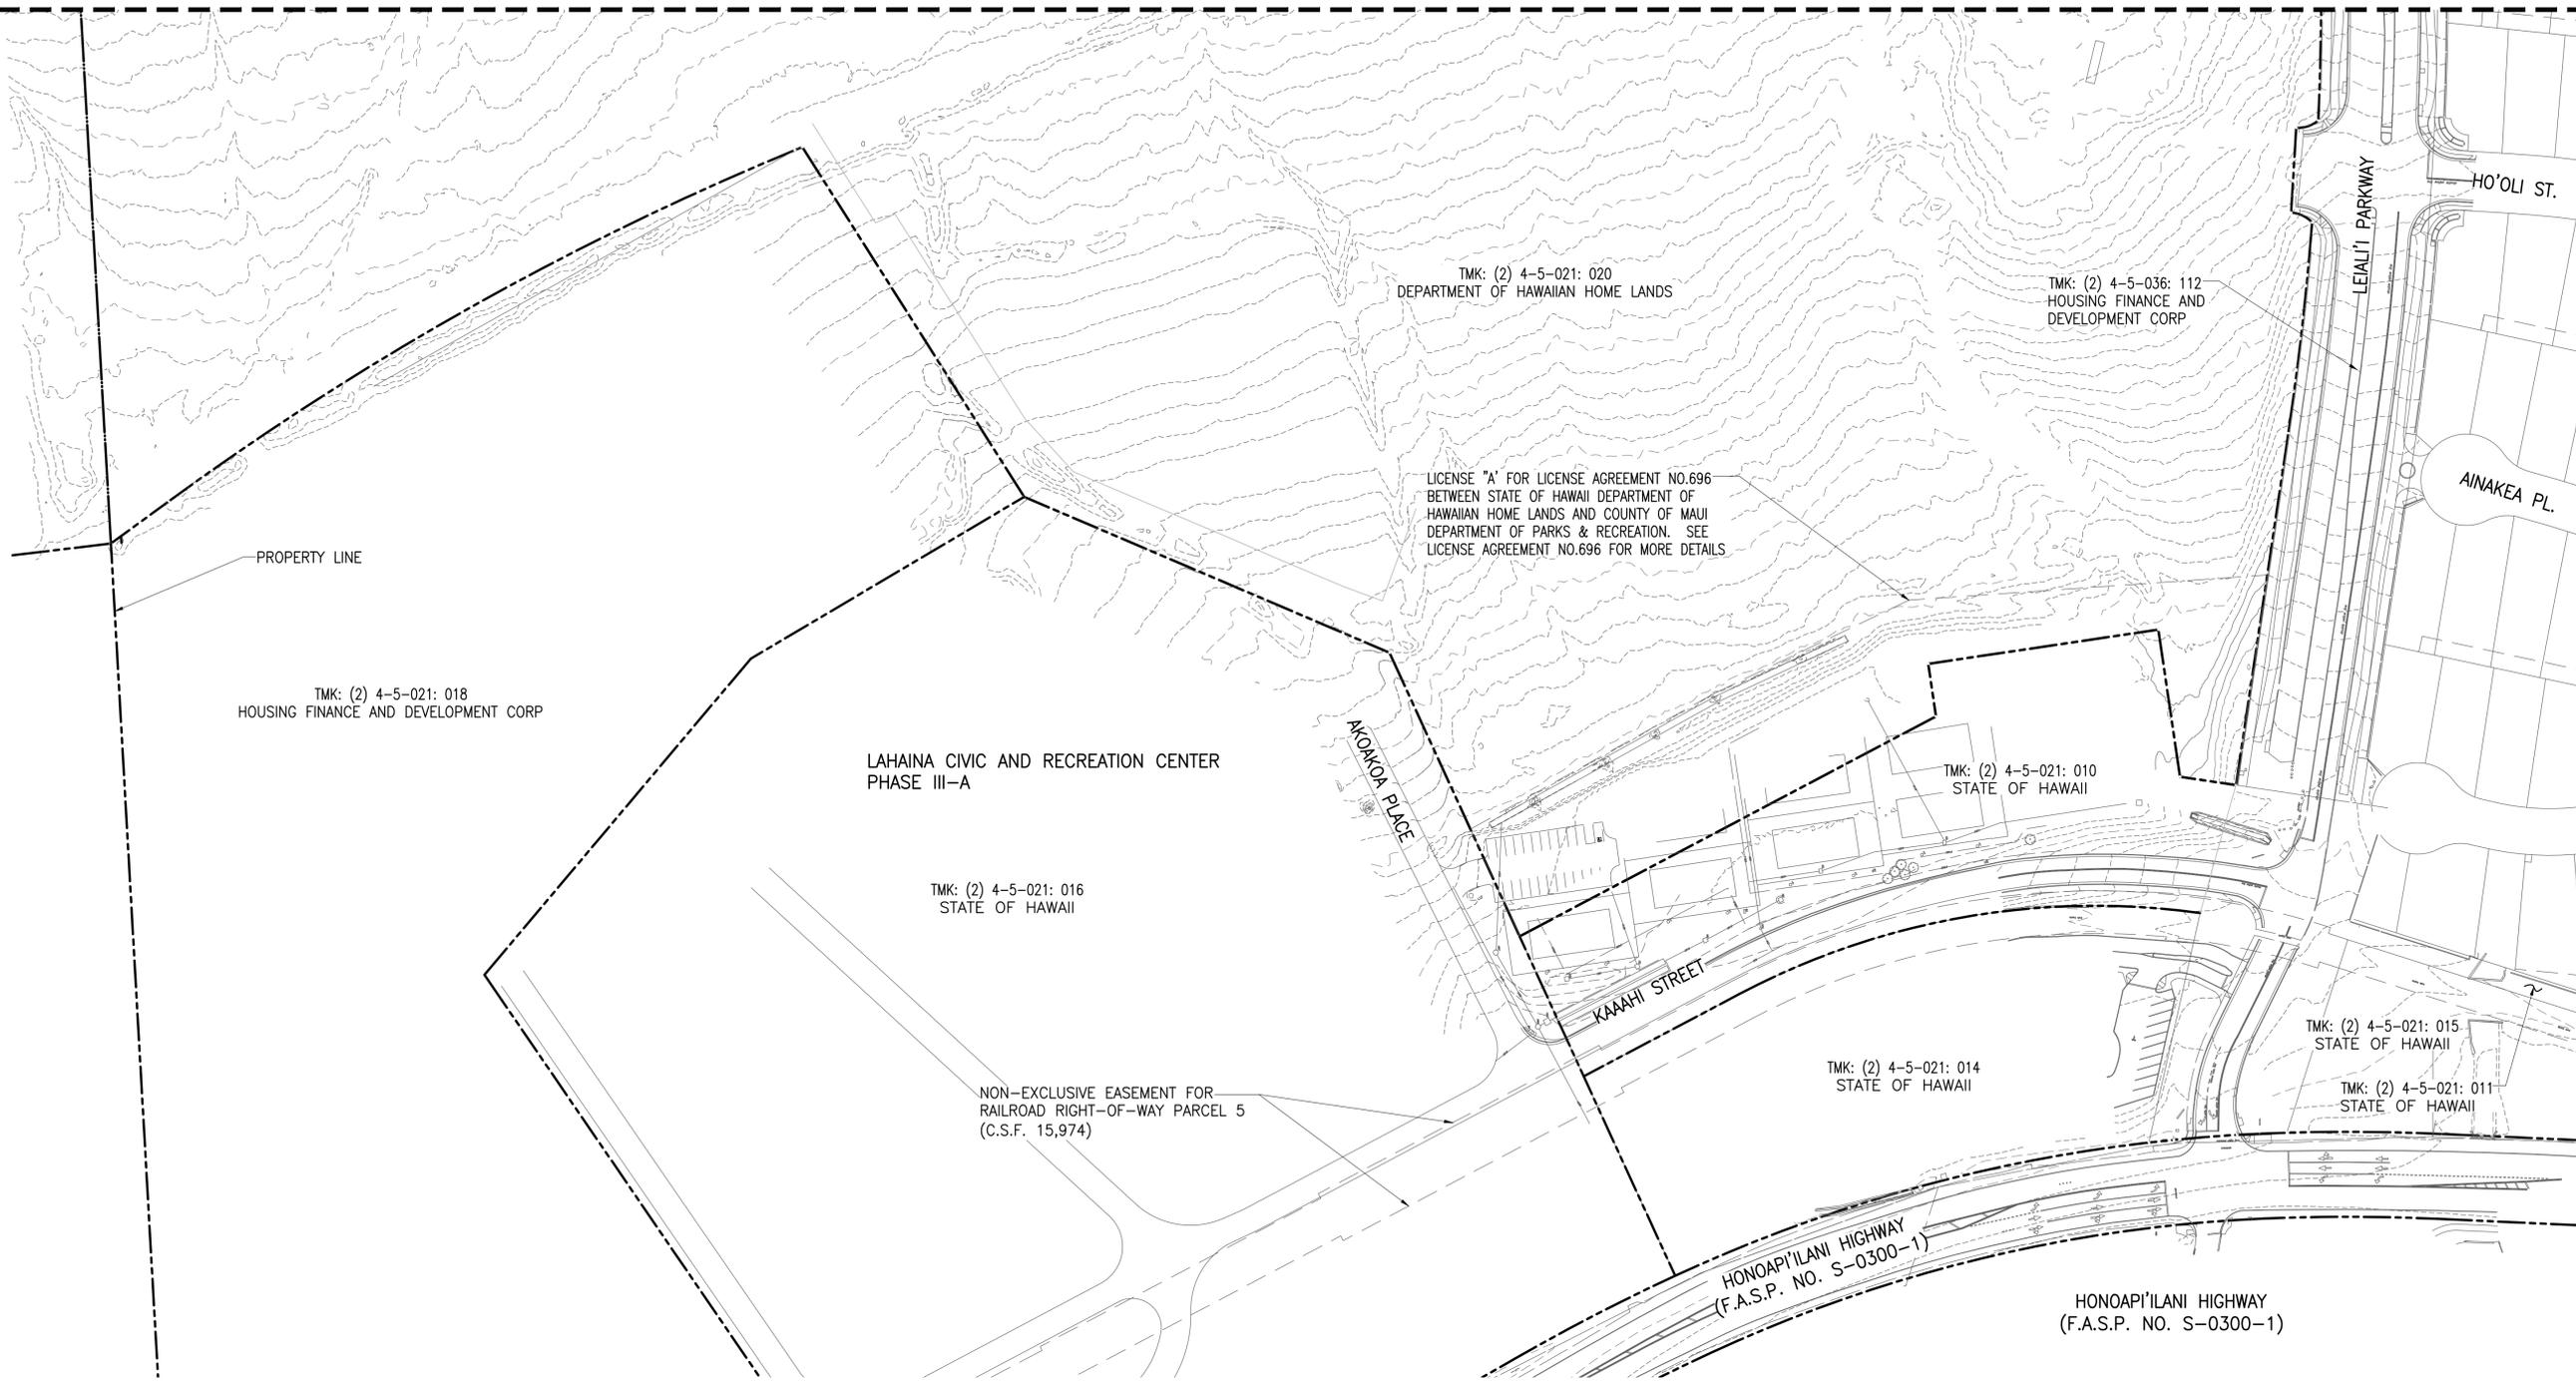

TOPOGRAPHIC AND BOUNDARY PLAN - 2

SCALE: 1"=80'



THIS WORK WAS PREPARED BY ME OR UNDER MY SUPERVISION AND CONSTRUCTION OF THIS PROJECT WILL BE UNDER MY OBSERVATION AS DEFINED IN SECTION 16-115-2, HAWAII ADMINISTRATIVE RULES, DEPARTMENT OF COMMERCE AND CONSUMER AFFAIRS, STATE OF HAWAII, PROFESSIONAL ENGINEERS, ARCHITECTS, SURVEYORS AND LANDSCAPE ARCHITECTS.

LICENSE EXPIRES: APRIL 30, 2024



LINE IS 2 INCHES AT FULL SIZE
(IF NOT 2-INCHES : SCALE ACCORDINGLY)

DWG. NO. **C-004**

SHEET 5 OF

| REVISION | DATE | BRIEF | MADE BY | APPROVED |
|--------------------------------------------------------------------------------------------------------------------------------------------------------------------------------|-----------|--------------|------------|------------|
| AUSTIN, TSUTSUMI & ASSOCIATES, INC. ENGINEERS, SURVEYORS • HONOLULU, WAILUKU, HAWAII | | | | |
| DEPARTMENT OF HAWAIIAN HOME LANDS VILLAGES OF LEALI'I, PHASE 1B TAX MAP KEY: (2) 4-5-21: 020 LAHAINA, MAUI, HAWAII TOPOGRAPHIC AND BOUNDARY PLAN - 2 | | | | |
| DESIGNED BY | KM | DRAWN BY | ATA | CHECKED BY |
| APPROVED BY | | SUBMITTED BY | | |
| DATE | | FIRM NUMBER | | DATE |

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| | | | |
|------|--------|--------|-----|
| FILE | POCKET | FOLDER | NO. |
|------|--------|--------|-----|

TRUE NORTH
SCALE: 1"=80'

REMOVE A.C.
PAVEMENT,
SIDEWALK, CURB
RAMPS, CURB
AND GUTTER AS
NOTED

TMK: (2) 4-5-021: 020
DEPARTMENT OF HAWAIIAN HOME LANDS

HANOHANO ST.
TMK: (2) 4-5-036: 112
HOUSING FINANCE AND
DEVELOPMENT CORP

SIHP 50-50-03-08888

AA PL.

REMOVE EXISTING
ROCK PILES
(TYP.)

EXIST. DIRT ROAD

TMK: (2) 4-5-021: 020
DEPARTMENT OF HAWAIIAN HOME LANDS

REMOVE A.C.
PAVEMENT,
SIDEWALK, CURB
RAMPS, CURB
AND GUTTER AS
NOTED

EXTENT OF DU-16 TO
BE REMOVED. REFER
TO "NOTES" BELOW

LEIALI' PARKWAY

HO'OLI ST.

AIPUNI ST.

REMOVE
EXIST.
ASPHALT
PAVEMENT

AINAKEA PL.

LAHAINA CIVIC AND RECREATION CENTER
PHASE III-A

TMK: (2) 4-5-021: 010
STATE OF HAWAII

AKOKOA PLACE

LEGEND

 REMOVE EXISTING ROCK PILES

NOTES:

1. PREPARE AN ARCHAEOLOGICAL MONITORING REPORT FOR SIHP 50-50-03-08888. AMP SHALL BE SUBMITTED TO STATE HISTORIC PRESERVATION.
2. REMOVE ALL ABANDONED VEHICLES, SHIPPING CONTAINERS, AND DISPOSE OF AT ACCEPTABLE LOCATION.
3. PRIOR TO GRUBBING, CONTRACTOR SHALL REMOVE 6" OF IMPACTED SOILS FROM SHALLOW INTERVAL OF DU 16; DISPOSE OF IT AT AN ACCEPTABLE LANDFILL; CONDUCT CONFIRMATION SAMPLING TO DEMONSTRATE THAT RRO NO LONGER REMAINS AT THIS LOCATION.

DEMOLITION PLAN

SCALE: 1"=80'



THIS WORK WAS PREPARED BY ME OR UNDER MY SUPERVISION AND CONSTRUCTION OF THIS PROJECT WILL BE UNDER MY OBSERVATION AS DEFINED IN SECTION 16-115-2, HAWAII ADMINISTRATIVE RULES, DEPARTMENT OF COMMERCE AND CONSUMER AFFAIRS, STATE OF HAWAII, PROFESSIONAL ENGINEERS, ARCHITECTS, SURVEYORS AND LANDSCAPE ARCHITECTS.

LICENSE EXPIRES: APRIL 30, 2024

0 1 2
LINE IS 2 INCHES AT FULL SIZE
(If NOT 2-inches : Scale Accordingly)

DWG. NO. **C-005**

SHEET 6 OF

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| REVISION | DATE | BRIEF | MADE BY | APPROVED |
| <p>ATA AUSTIN, TSUTSUMI & ASSOCIATES, INC. ENGINEERS, SURVEYORS • HONOLULU, WAILUKU, HAWAII</p> <p>DEPARTMENT OF HAWAIIAN HOME LANDS</p> <p>VILLAGES OF LEIALI'I, PHASE 1B</p> <p>TAX MAP KEY: (2) 4-5-21: 020 LAHAINA, MAUI, HAWAII</p> <p>DEMOLITION PLAN</p> | | | | |
| DESIGNED BY | DATE | DRAWN BY | DATE | CHECKED BY |
| APPROVED BY | DATE | SUBMITTED BY | DATE | |

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TRUE NORTH
SCALE: 1"=100'

BOUNDARY LINE


BOUNDARY LINE

INCREMENT 2
ACRES = 23.1

INCREMENT 1
ACRES = 23.0

LAHAINA CIVIC AND RECREATION CENTER
PHASE III-A

PROJECT PHASING PLAN
SCALE: 1"=100'

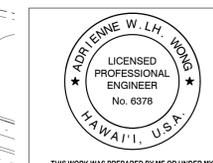

THIS WORK WAS PREPARED BY ME OR UNDER MY SUPERVISION AND CONSTRUCTION OF THIS PROJECT WILL BE UNDER MY OBSERVATION AS DEFINED IN SECTION 16-115-2, HAWAII ADMINISTRATIVE RULES, DEPARTMENT OF COMMERCE AND CONSUMER AFFAIRS, STATE OF HAWAII, PROFESSIONAL ENGINEERS, ARCHITECTS, SURVEYORS AND LANDSCAPE ARCHITECTS.

LICENSE EXPIRES: APRIL 30, 2024

0 1 2
LINE IS 2 INCHES AT FULL SIZE
(If NOT 2-inches : Scale Accordingly)

DWG. NO. **C-006**

SHEET 7 OF

| REVISION | DATE | BRIEF | MADE BY | APPROVED |
|-----------------------------------------------------------------------------------------------------------------------------------------------------------------------------------------------------------------------------------------------------------------------------------------|------|--------------|---------|-------------|
| <p>ATA AUSTIN, TSUTSUMI & ASSOCIATES, INC. ENGINEERS, SURVEYORS • HONOLULU, WAILUKU, HAWAII</p> <p>DEPARTMENT OF HAWAIIAN HOME LANDS</p> <p>VILLAGES OF LEIALI'I, PHASE 1B</p> <p>TAX MAP KEY: (2) 4-5-21: 020 LAHAINA, MAUI, HAWAII</p> <p>PROJECT PHASING PLAN</p> | | | | |
| DESIGNED BY | DATE | DRAWN BY | DATE | CHECKED BY |
| APPROVED BY | DATE | SUBMITTED BY | DATE | FIRM NUMBER |

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| FILE | POCKET | FOLDER | NO. |
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| | | | |

STANDARD PLANS SUMMARY

| STANDARD PLAN NO. | TITLE | DATE |
|-------------------|---------------------------------------------------------------------------|----------|
| B-01 • | NOTES & MISCELLANEOUS DETAILS | 05/31/07 |
| B-03 • | BACKFILL DETAILS AT EARTH RETAINING STRUCTURES | 05/31/07 |
| B-12 | PRESTRESSED CONCRETE PILES & COMPRESSION SPLICE CAN DETAILS | 05/31/07 |
| B-12A | PRESTRESSED CONCRETE PILES, PILE & COMPRESSION SPLICE CAN DETAILS & NOTES | 05/31/07 |
| B-12B | PILE INTERACTION DIAGRAM | 05/31/07 |
| B-13 | PRESTRESSED CONCRETE PILE BUILD-UP DETAILS | 05/31/07 |

| | | |
|--------|------------------------------------------------------|----------|
| D-01 | CATTLE GATE | 05/31/07 |
| D-02 | CHAIN LINK FENCE WITH TOPRAIL | 05/31/07 |
| D-03 | CHAIN LINK FENCE WITHOUT TOPRAIL | 05/31/07 |
| D-04 | WIRE FENCE WITH METAL POSTS | 05/31/07 |
| D-05 • | TYPICAL DETAILS OF CURBS AND/OR GUTTERS | 05/31/07 |
| D-06 • | TYPICAL DETAILS OF REINFORCED CONCRETE DROP DRIVEWAY | 05/31/07 |
| D-07 • | CENTERLINE AND REFERENCE SURVEY MONUMENTS | 05/31/07 |
| D-08 • | STREET SURVEY MONUMENT | 05/31/07 |
| D-15 • | CONCRETE SIDEWALK | 05/31/07 |
| D-16 | P.C.C BUS PAD | 05/31/07 |
| D-17 | P.C.C BUS PAD | 05/31/07 |
| D-18 | P.C.C PAVEMENT LAYOUT | 05/31/07 |
| D-19 | P.C.C PAVEMENT W/ PERMEABLE BASE JOINT DETAILS | 05/31/07 |
| D-20 | P.C.C PAVEMENT W/ PERMEABLE BASE JOINT DETAILS | 05/31/07 |
| D-21 | P.C.C LONGITUDINAL JOINT DETAILS | 05/31/07 |
| D-22 | P.C.C CONNECTION TO CURBS AND GUTTERS | 05/31/07 |
| D-23 • | JOINTS | 05/31/07 |

| | | |
|------|--------------------|----------|
| L-01 | TREE PLANTING | 08/16/06 |
| L-02 | TREE PLANTING | 08/16/06 |
| L-03 | TREE TRANSPLANTING | 08/16/06 |
| L-04 | PALM PLANTING | 08/16/06 |
| L-05 | SHRUB PLANING | 08/16/06 |
| L-06 | LANDSCAPE DETAILS | 08/16/06 |
| L-07 | LANDSCAPE DETAILS | 08/16/06 |
| L-08 | LANDSCAPE DETAILS | 08/16/06 |
| L-09 | LANDSCAPE DETAILS | 08/16/06 |
| L-10 | LANDSCAPE DETAILS | 08/16/06 |
| L-11 | PLANTING NOTES | 08/16/06 |
| L-12 | IRRIGATION DETAILS | 08/16/06 |
| L-13 | IRRIGATION DETAILS | 08/16/06 |
| L-14 | IRRIGATION DETAILS | 08/16/06 |
| L-15 | IRRIGATION DETAILS | 08/16/06 |
| L-16 | IRRIGATION DETAILS | 08/16/06 |
| L-17 | IRRIGATION DETAILS | 08/16/06 |
| L-18 | IRRIGATION DETAILS | 08/16/06 |
| L-19 | IRRIGATION DETAILS | 08/16/06 |
| L-20 | IRRIGATION DETAILS | 08/16/06 |
| L-21 | IRRIGATION DETAILS | 08/16/06 |
| L-22 | IRRIGATION DETAILS | 08/16/06 |
| L-23 | IRRIGATION DETAILS | 08/16/06 |
| L-24 | IRRIGATION NOTES | 08/16/06 |

| STANDARD PLAN NO. | TITLE | DATE |
|-------------------|-----------------------------------------------------|----------|
| H-01A | TYPE A CATCH BASIN | 05/31/07 |
| H-01B | TYPE B CATCH BASIN | 05/31/07 |
| H-01C | TYPE C CATCH BASIN | 05/31/07 |
| H-01D | TYPE D CATCH BASIN | 05/31/07 |
| H-01E | CATCH BASIN SECTIONS | 05/31/07 |
| H-02A | TYPE A1 CATCH BASIN | 05/31/07 |
| H-02B | TYPE B2 CATCH BASIN | 05/31/07 |
| H-02C | TYPE C1 CATCH BASIN | 05/31/07 |
| H-02D | TYPE D1 CATCH BASIN | 05/31/07 |
| H-02E | CATCH BASIN SECTION | 05/31/07 |
| H-03 | TYPE A, B AND C STORM DRAIN MANHOLE | 05/31/07 |
| H-04 | TYPE D STORM DRAIN MANHOLE | 05/31/07 |
| H-05 | TYPICAL REINFORCING DETAILS FOR DRAINAGE STRUCTURES | 05/31/07 |

| | | |
|------|------------------------------------------------------------------|----------|
| H-06 | TYPICAL REINFORCING DETAILS FOR DRAINAGE STRUCTURES | 05/31/07 |
| H-07 | CATCH BASIN AND MANHOLE CASTING | 05/31/07 |
| H-08 | TYPE 1A-9 AND 1A-9P GRATED DROP INLET | 05/31/07 |
| H-09 | TYPE 2A-9 AND 2A-9P GRATED DROP INLET | 05/31/07 |
| H-10 | TYPE A-9 OR A-9P STEEL FRAMES | 05/31/07 |
| H-11 | TYPE A-9 OR A-9P STEEL GRATES | 05/31/07 |
| H-12 | TYPE 61614P AND 1211214P GRATED DROP INLET | 05/31/07 |
| H-13 | TYPE 61616P AND 1211216P GRATED DROP INLET | 05/31/07 |
| H-14 | TYPE 61214P GRATED DROP INLET | 05/31/07 |
| H-15 | TYPE 1211214, 1211214P, 1211216, 1211216P STEEL FRAME AND GRATES | 05/31/07 |
| H-16 | TYPE 61614, 61614P, 61616, 61616P STEEL FRAME AND GRATES | 05/31/07 |
| H-17 | TYPE 61214 STEEL FRAMES AND GRATES | 05/31/07 |
| H-18 | TYPE 61214P STEEL GRATES | 05/31/07 |
| H-19 | TYPE 61614B STEEL FRAME AND GRATES | 05/31/07 |
| H-20 | CEMENT RUBBLE MASONRY STRUCTURES | 05/31/07 |
| H-21 | CONCRETE AND CEMENT RUBBLE MASONRY STRUCTURES | 05/31/07 |
| H-22 | INLET/OUTLET STRUCTURE | 05/31/07 |
| H-23 | INLET/OUTLET STRUCTURE | 05/31/07 |
| H-24 | FLARED END SECTION FOR CULVERTS | 05/31/07 |
| H-25 | FLARED END SECTION FOR CULVERTS | 05/31/07 |
| H-26 | CONCRETE SPILLWAY INLET | 05/31/07 |
| H-27 | CAP COUPLING DETAILS STANDARD JOINT | 05/31/07 |
| H-28 | REINFORCED CONCRETE COLLAR & JACKET | 05/31/07 |
| H-29 | UNDERDRAIN CLEANOUT STEEL FRAME AND COVER | 05/31/07 |
| H-30 | UNDERDRAIN CONNECTION TO DRAINAGE STRUCTURE | 05/31/07 |

| | | |
|----------|-----------------------------------------------|----------|
| TE-01 • | SIGN HEIGHT AND LOCATION | 07/11/08 |
| TE-01A • | SIGN INSTALLATION | 07/11/08 |
| TE-02A • | GALVANIZED FLANGED CHANNEL SIGN POST MOUNTING | 05/31/07 |
| TE-02B • | GALVANIZED FLANGED CHANNEL SIGN POST MOUNTING | 05/31/07 |
| TE-02C • | GALVANIZED FLANGED CHANNEL SIGN POST MOUNTING | 05/31/07 |
| TE-03A • | GALVANIZED SQUARE TUBE SIGN POST MOUNTING | 05/31/07 |
| TE-03B • | GALVANIZED SQUARE TUBE SIGN POST MOUNTING | 05/31/07 |
| TE-04 • | REGULATORY SIGNS | 07/11/08 |
| TE-05 • | WARNING SIGNS | 07/11/08 |
| TE-06 • | MISCELLANEOUS SIGNS | 07/11/08 |
| TE-07 • | CONSTRUCTION SIGNS | 07/11/08 |
| TE-08 • | MISCELLANEOUS INTERSECTION SIGNS | 07/11/08 |

| STANDARD PLAN NO. | TITLE | DATE |
|-------------------|----------------------------------------------------------|----------|
| TE-09 • | BIKE ROUTE SIGN & SUPPLEMENTARY PLATES | 07/11/08 |
| TE-10 | INTERSTATE ROUTE MARKER | 07/11/08 |
| TE-11 | STATE ROUTE MARKER AND AUXILIARY MARKERS | 07/11/08 |
| TE-12 | STATE ROUTE MARKER AND BORDER DETAIL FOR GUIDE SIGNS | 07/11/08 |
| TE-12A | ROUTE SIGN ASSEMBLIES | 07/11/08 |
| TE-13 • | STREET NAME SIGN ON MAST ARM | 04/29/16 |
| TE-14 • | MISCELLANEOUS REFLECTOR MARKERS | 07/11/08 |
| TE-15 | OBJECT MARKERS | 07/11/08 |
| TE-16 | MILE POSTS | 07/11/08 |
| TE-17A | CANTILEVER OVERHEAD SIGN ELEVATION & DETAILS | 05/31/07 |
| TE-17B | CANTILEVER SIGN FRAME DETAIL AND SECTION | 05/31/07 |
| TE-17C | CANTILEVER SIGN FRAME DETAIL | 05/31/07 |
| TE-17D | CANTILEVER SIGN FRAME SECTION | 05/31/07 |
| TE-17E | CANTILEVER SIGN FRAME DETAILS | 05/31/07 |
| TE-18A | TWO POST OVERHEAD SIGN FRAME ELEVATIONS | 05/31/07 |
| TE-18B | TWO POST SIGN FRAMING PLAN SECTION | 05/31/07 |
| TE-18C | TWO POST SIGN FRAMING SECTIONS AND DETAILS | 05/31/07 |
| TE-18D | TWO POST SIGN FRAME DETAILS | 05/31/07 |
| TE-18E | TWO POST SIGN FRAME DETAILS | 05/31/07 |
| TE-19A | OVERHEAD SIGN FRAMING SCHEDULE | 05/31/07 |
| TE-19B | SIGN POST DRILLED SHAFT FOUNDATION | 05/31/07 |
| TE-19C | SPREAD FOOTING | 05/31/07 |
| TE-19D | SIGN FRAME FOUNDATION SCHEDULE | 05/31/07 |
| TE-19D.1 | SIGN FRAME FOUNDATION SCHEDULE | 05/31/07 |
| TE-19D.2 | SIGN FRAME FOUNDATION SCHEDULE | 05/31/07 |
| TE-19D.3 | SIGN FRAME FOUNDATION SCHEDULE | 05/31/07 |
| TE-19D.4 | SIGN FRAME FOUNDATION SCHEDULE | 05/31/07 |
| TE-19D.5 | SIGN FRAME FOUNDATION SCHEDULE | 05/31/07 |
| TE-19E | ANCHORAGE DETAILS | 05/31/07 |
| TE-19F | ANCHORAGE DETAILS | 05/31/07 |
| TE-19G | MISCELLANEOUS SIGN FRAME DETAILS | 05/31/07 |
| TE-19H | LUMINAIRE WALKWAY SUPPORT | 05/31/07 |
| TE-19J | FIXED MESSAGE LUMINAIRE SUPPORT | 05/31/07 |
| TE-19K | MISCELLANEOUS SIGN DETAILS | 05/31/07 |
| TE-19L | MISCELLANEOUS SIGN DETAILS | 05/31/07 |
| TE-19M | MISCELLANEOUS SIGN FRAME DETAILS | 05/31/07 |
| TE-20 | SUPPORTS FOR GROUND MOUNTED GUIDE SIGN | 05/31/07 |
| TE-20A | SUPPORTS FOR GROUND MOUNTED GUIDE SIGN | 05/31/07 |
| TE-20B | SUPPORTS FOR GROUND MOUNTED GUIDE SIGN | 05/31/07 |
| TE-20C | SUPPORTS FOR GROUND MOUNTED GUIDE SIGN | 05/31/07 |
| TE-21A | SIGN BREAKAWAY MOUNTS | 05/31/07 |
| TE-21B | SIGN BREAKAWAY MOUNTS | 05/31/07 |
| TE-22 | LAMINATED ALUMINUM SIGN PANELS (OVERHEAD) | 05/31/07 |
| TE-23 | LAMINATED ALUMINUM SIGN PANELS (GROUND MOUNTED) | 07/11/08 |
| TE-24 | SOLID ALUMINUM EXTRUDED SIGN PANEL AND ACCESSORY DETAILS | 05/31/07 |
| TE-25 | GUIDE SIGNS LUMINAIRE MOUNTINGS | 05/31/07 |
| TE-26 • | RAISED PAVEMENT MARKERS AND STRIPING | 07/11/08 |
| TE-27 • | RAISED PAVEMENT MARKERS AND STRIPING | 07/11/08 |
| TE-28 | ENTRANCE AND EXIT PAVEMENT MARKINGS | 07/11/08 |
| TE-28A | ENTRANCE AND EXIT PAVEMENT MARKINGS | 07/11/08 |
| TE-28A • | MISCELLANEOUS PAVEMENT MARKINGS | 07/11/08 |
| TE-29 • | PAVEMENT ARROWS AND SYMBOLS | 07/11/08 |
| TE-30 • | PAVEMENT ALPHABETS, NUMBERS AND SYMBOLS | 07/11/08 |

| STANDARD PLAN NO. | TITLE | DATE |
|-------------------|---------------------------------------------------|----------|
| TE-31 • | PAVEMENT ALPHABETS, NUMBERS & SYMBOLS | 07/11/08 |
| TE-32 • | TYPE I & II TRAFFIC SIGNAL SYSTEM MISC. DETAILS | 05/31/07 |
| TE-33 • | TYPE II TRAFFIC SIGNAL SYSTEM | 08/16/06 |
| TE-33A.1 • | TYPE II TRAFFIC SIGNAL STANDARD | 05/31/07 |
| TE-33A.2 • | TYPE II TRAFFIC SIGNAL STANDARD | 05/31/07 |
| TE-34 • | LOOP DETECTOR DETAILS | 07/11/08 |
| TE-35 • | LOOP DETECTORS & DUCT DETAILS | 07/11/08 |
| TE-36 • | TRAFFIC SIGNAL DETAILS | 07/11/08 |
| TE-37 • | PULLBOX AND COVER DETAILS | 07/11/08 |
| TE-37A • | TYPE "A" TRAFFIC PULLBOX | 05/31/07 |
| TE-37B • | TYPE "A" TRAFFIC PULLBOX REINFORCING | 05/31/07 |
| TE-37C • | TYPE "B" TRAFFIC PULLBOX | 05/31/07 |
| TE-37D • | TYPE "B" TRAFFIC PULLBOX REINFORCING | 05/31/07 |
| TE-37E • | TYPE "B" TRAFFIC PULLBOX FOUNDATION | 05/31/07 |
| TE-37F • | TYPE "C" TRAFFIC PULLBOX | 05/31/07 |
| TE-37G • | TYPE "C" TRAFFIC PULLBOX REINFORCING | 05/31/07 |
| TE-37H • | TYPE "C" TRAFFIC PULLBOX FOUNDATION | 05/31/07 |
| TE-37J • | TRAFFIC PULLBOX COVER AND DETAILS | 05/31/07 |
| TE-38 | TYPE III TRAFFIC SIGNAL STANDARD | 05/31/07 |
| TE-38A.1 | TYPE III TRAFFIC SIGNAL STANDARD | 05/31/07 |
| TE-38A.2 | TYPE III TRAFFIC SIGNAL STANDARD | 05/31/07 |
| TE-39 | METAL GUARDRAIL CONNECTION TO CONCRETE BARRIER | 07/11/08 |
| TE-40 | CONCRETE BARRIER TRANSITION | 05/31/07 |
| TE-40A | CONCRETE BARRIER TRANSITION SECTIONS | 05/31/07 |
| TE-41 | GUARDRAIL TYPE 4 (RIGID BARRIER) | 05/31/07 |
| TE-42 • | PORTABLE CONCRETE BARRIER | 05/31/07 |
| TE-43 • | PORTABLE CONCRETE BARRIER | 05/31/07 |
| TE-44 • | GUARDRAIL TYPE 4 MISCELLANEOUS DETAILS | 07/11/08 |
| TE-45 • | BARRICADES | 07/11/08 |
| TE-46 | DELINEATION & PAVEMENT MARKINGS AT NARROW BRIDGES | 07/11/08 |
| TE-47 • | HIGHWAY LIGHT STANDARD | 05/31/07 |

NOTE:

STANDARD PLANS APPLICABLE TO THIS PROJECT ARE INDICATED BY A "•" NEXT TO THE STANDARD PLAN NO. (FOR EXAMPLE: D-07 •)



THIS WORK WAS PREPARED BY ME OR UNDER MY SUPERVISION AND CONSTRUCTION OF THIS PROJECT WILL BE UNDER MY OBSERVATION AS DEFINED IN SECTION 16-115-2, HAWAII ADMINISTRATIVE RULES, DEPARTMENT OF COMMERCE AND CONSUMER AFFAIRS, STATE OF HAWAII, PROFESSIONAL ENGINEERS, ARCHITECTS, SURVEYORS AND LANDSCAPE ARCHITECTS.

LICENSE EXPIRES: APRIL 30, 2024
 0 1 2
 LINE IS 2 INCHES AT FULL SIZE
 (IF NOT 2-INCHES: Scale Accordingly)
 DWG. NO. **C-007**
 SHEET 8 OF

| REVISION | DATE | BRIEF | MADE BY | APPROVED |
|------------------------------------------------------------------------------------------------------------------------------------------------------------------------|--------------|---------------|--------------|----------------|
| ATA AUSTIN, TSUTSUMI & ASSOCIATES, INC. ENGINEERS, SURVEYORS • HONOLULU, WAILUKU, HAWAII | | | | |
| DEPARTMENT OF HAWAIIAN HOME LANDS VILLAGES OF LEIALI'I, PHASE 1B TAX MAP KEY: (2) 4-5-21: 020 LAHAINA, MAUI, HAWAII STATE HIGHWAY STANDARD PLAN SUMMARY | | | | |
| DESIGNED BY: KM | | DRAWN BY: ATA | | CHECKED BY: AW |
| APPROVED BY: | | SUBMITTED BY: | | |
| DATE: | FIRM NUMBER: | DATE: | FIRM NUMBER: | DATE: |


DATE: SEPTEMBER 2023

| FILE | POCKET | FOLDER | NO. |
|------|--------|--------|-----|
| | | | |

TRUE NORTH
SCALE: 1"=80'


INCREMENT 2

INCREMENT 1

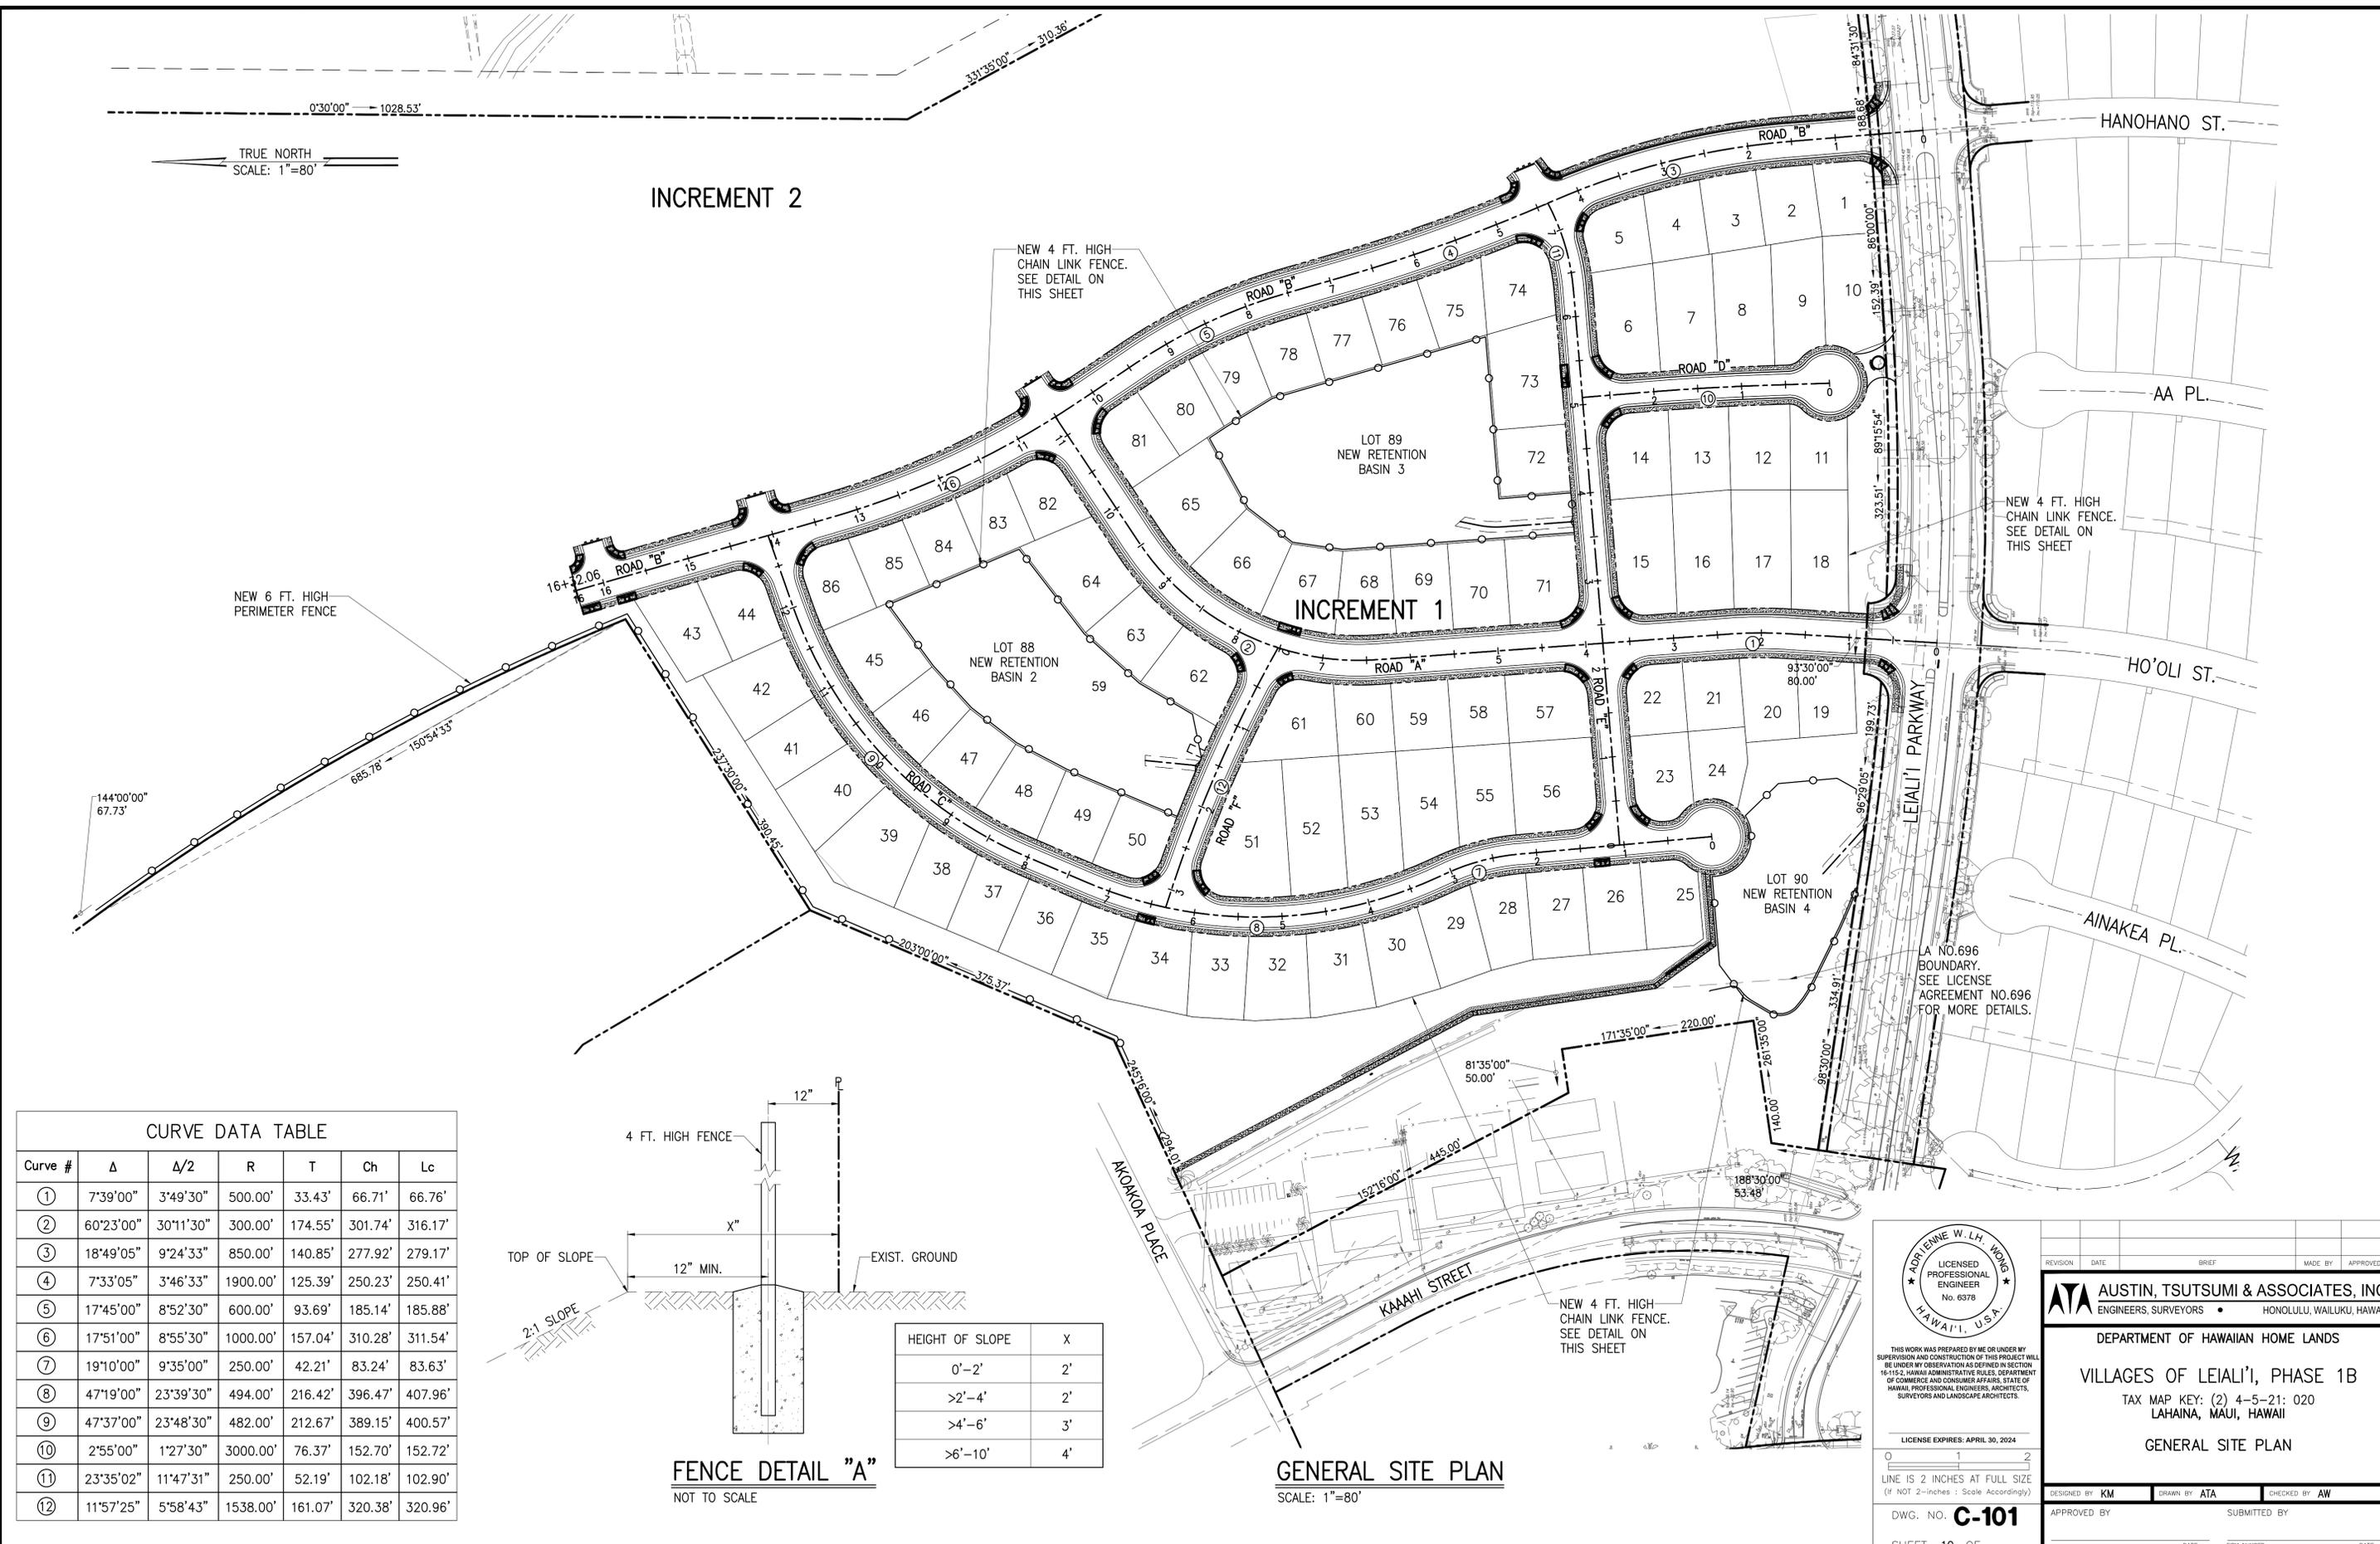

CURVE DATA TABLE

| Curve # | Δ | Δ/2 | R | T | Ch | Lc |
|---------|-----------|-----------|----------|---------|---------|---------|
| ① | 7°39'00" | 3°49'30" | 500.00' | 33.43' | 66.71' | 66.76' |
| ② | 60°23'00" | 30°11'30" | 300.00' | 174.55' | 301.74' | 316.17' |
| ③ | 18°49'05" | 9°24'33" | 850.00' | 140.85' | 277.92' | 279.17' |
| ④ | 7°33'05" | 3°46'33" | 1900.00' | 125.39' | 250.23' | 250.41' |
| ⑤ | 17°45'00" | 8°52'30" | 600.00' | 93.69' | 185.14' | 185.88' |
| ⑥ | 17°51'00" | 8°55'30" | 1000.00' | 157.04' | 310.28' | 311.54' |
| ⑦ | 19°10'00" | 9°35'00" | 250.00' | 42.21' | 83.24' | 83.63' |
| ⑧ | 47°19'00" | 23°39'30" | 494.00' | 216.42' | 396.47' | 407.96' |
| ⑨ | 47°37'00" | 23°48'30" | 482.00' | 212.67' | 389.15' | 400.57' |
| ⑩ | 2°55'00" | 1°27'30" | 3000.00' | 76.37' | 152.70' | 152.72' |
| ⑪ | 23°35'02" | 11°47'31" | 250.00' | 52.19' | 102.18' | 102.90' |
| ⑫ | 11°57'25" | 5°58'43" | 1538.00' | 161.07' | 320.38' | 320.96' |

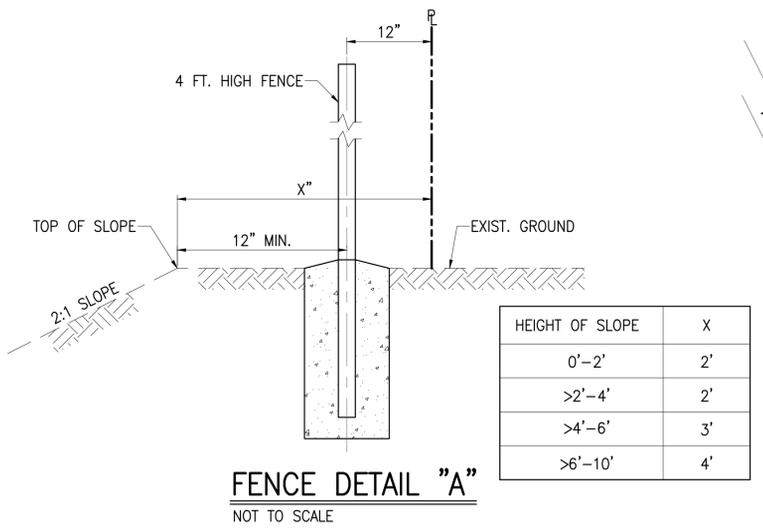

GENERAL SITE PLAN
SCALE: 1"=80'



THIS WORK WAS PREPARED BY ME OR UNDER MY SUPERVISION AND CONSTRUCTION OF THIS PROJECT WILL BE UNDER MY OBSERVATION AS DEFINED IN SECTION 16-115-2, HAWAII ADMINISTRATIVE RULES, DEPARTMENT OF COMMERCE AND CONSUMER AFFAIRS, STATE OF HAWAII. PROFESSIONAL ENGINEER, ARCHITECTS, SURVEYORS AND LANDSCAPE ARCHITECTS.


LICENSE EXPIRES: APRIL 30, 2024

LINE IS 2 INCHES AT FULL SIZE
(IF NOT 2-INCHES : SCALE ACCORDINGLY)

DWG. NO. **C-101**

SHEET 10 OF

| REVISION | DATE | BRIEF | MADE BY | APPROVED |
|-----------------------------------------------------------------------------------------------------------------------------------------------------------------|------|--------------|---------|------------|
| AUSTIN, TSUTSUMI & ASSOCIATES, INC. ENGINEERS, SURVEYORS • HONOLULU, WAILUKU, HAWAII | | | | |
| DEPARTMENT OF HAWAIIAN HOME LANDS VILLAGES OF LEIALI'I, PHASE 1B TAX MAP KEY: (2) 4-5-21: 020 LAHAINA, MAUI, HAWAII GENERAL SITE PLAN | | | | |
| DESIGNED BY | DATE | DRAWN BY | DATE | CHECKED BY |
| APPROVED BY | DATE | SUBMITTED BY | DATE | |

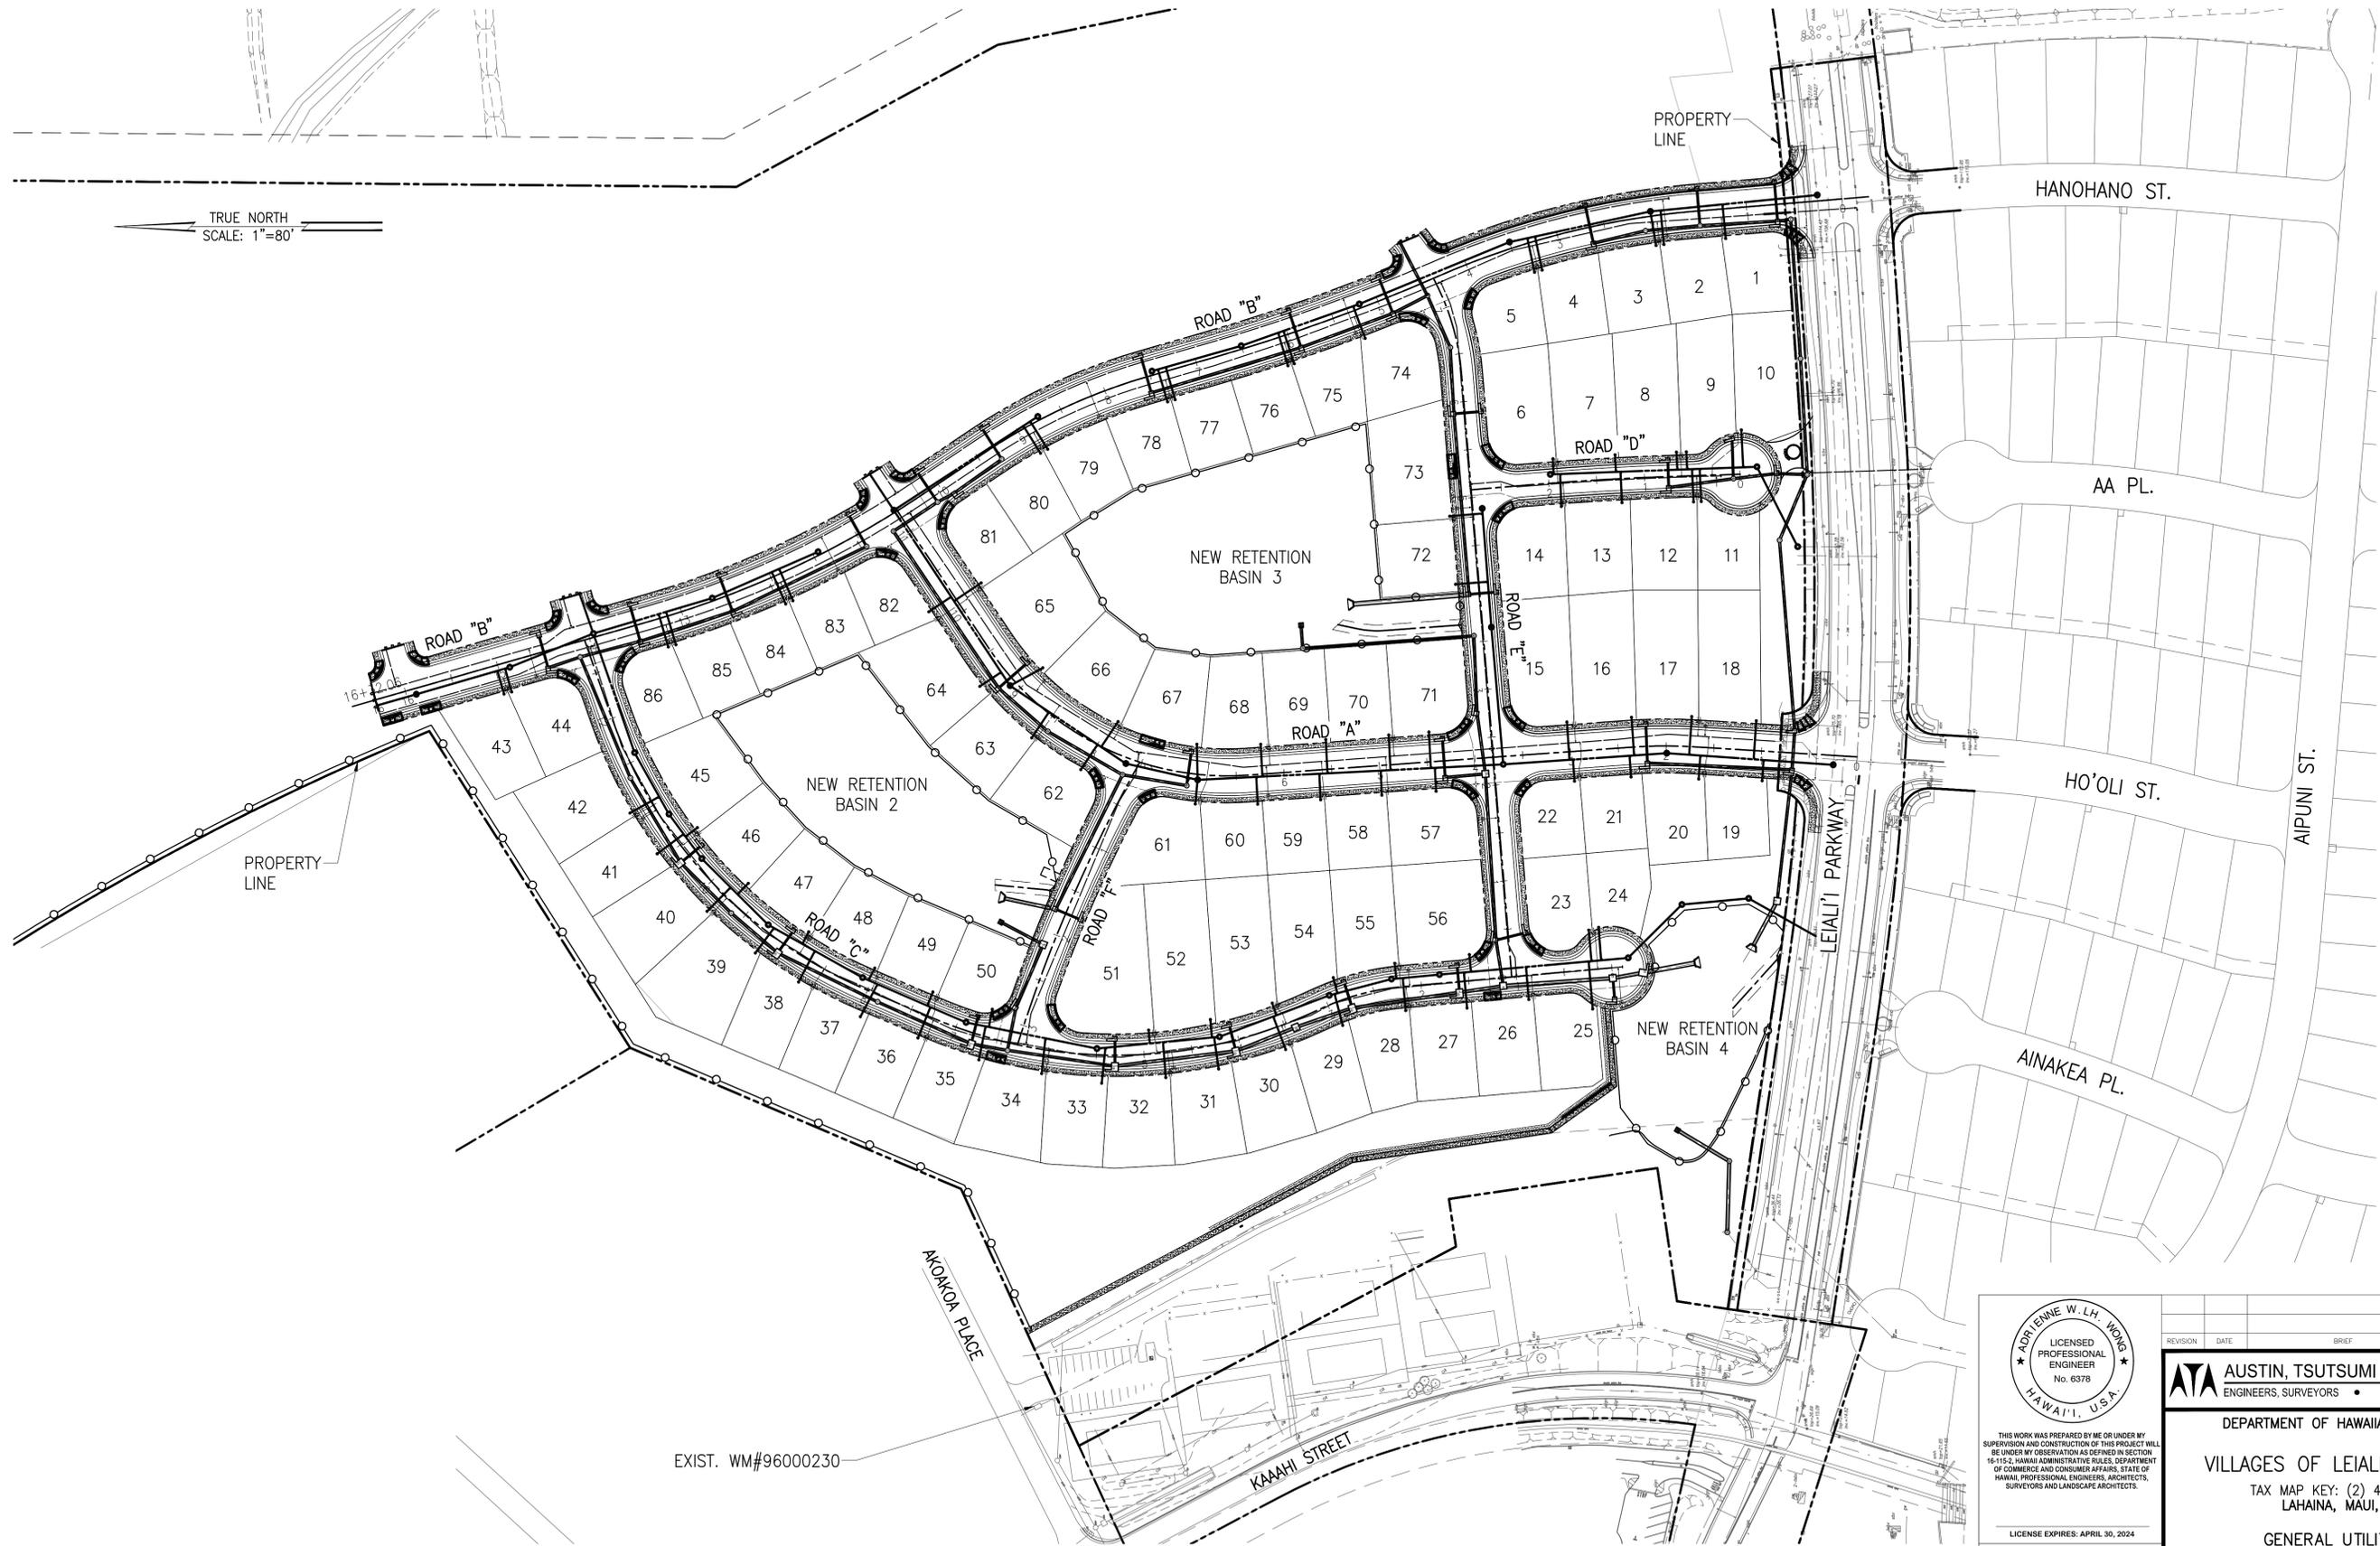

GENERAL UTILITY PLAN
SCALE: 1"=80'




THIS WORK WAS PREPARED BY ME OR UNDER MY SUPERVISION AND CONSTRUCTION OF THIS PROJECT WILL BE UNDER MY OBSERVATION AS DEFINED IN SECTION 16-115-2, HAWAII ADMINISTRATIVE RULES, DEPARTMENT OF COMMERCE AND CONSUMER AFFAIRS, STATE OF HAWAII. PROFESSIONAL ENGINEERS, ARCHITECTS, SURVEYORS AND LANDSCAPE ARCHITECTS.

LICENSE EXPIRES: APRIL 30, 2024
 0 1 2
 LINE IS 2 INCHES AT FULL SIZE
 (IF NOT 2-INCHES : Scale Accordingly)
 DWG. NO. **C-102**
 SHEET 11 OF

| REVISION | DATE | BRIEF | MADE BY | APPROVED |
|---------------------------------------------------------------------------------------------------------------------------------------------------------------------------------------------------------------------------------------------------------------------------------------------------------------|------|--------------|---------|------------|
| <p>ATA AUSTIN, TSUTSUMI & ASSOCIATES, INC. ENGINEERS, SURVEYORS • HONOLULU, WAILUKU, HAWAII</p> <p>DEPARTMENT OF HAWAIIAN HOME LANDS</p> <p>VILLAGES OF LEIALI'I, PHASE 1B</p> <p>TAX MAP KEY: (2) 4-5-21: 020 LAHAINA, MAUI, HAWAII</p> <p>GENERAL UTILITY PLAN</p> | | | | |
| DESIGNED BY | KM | DRAWN BY | ATA | CHECKED BY |
| APPROVED BY | | SUBMITTED BY | | |
| DATE | | FIRM NUMBER | | DATE |

TRUE NORTH
SCALE: 1"=80'

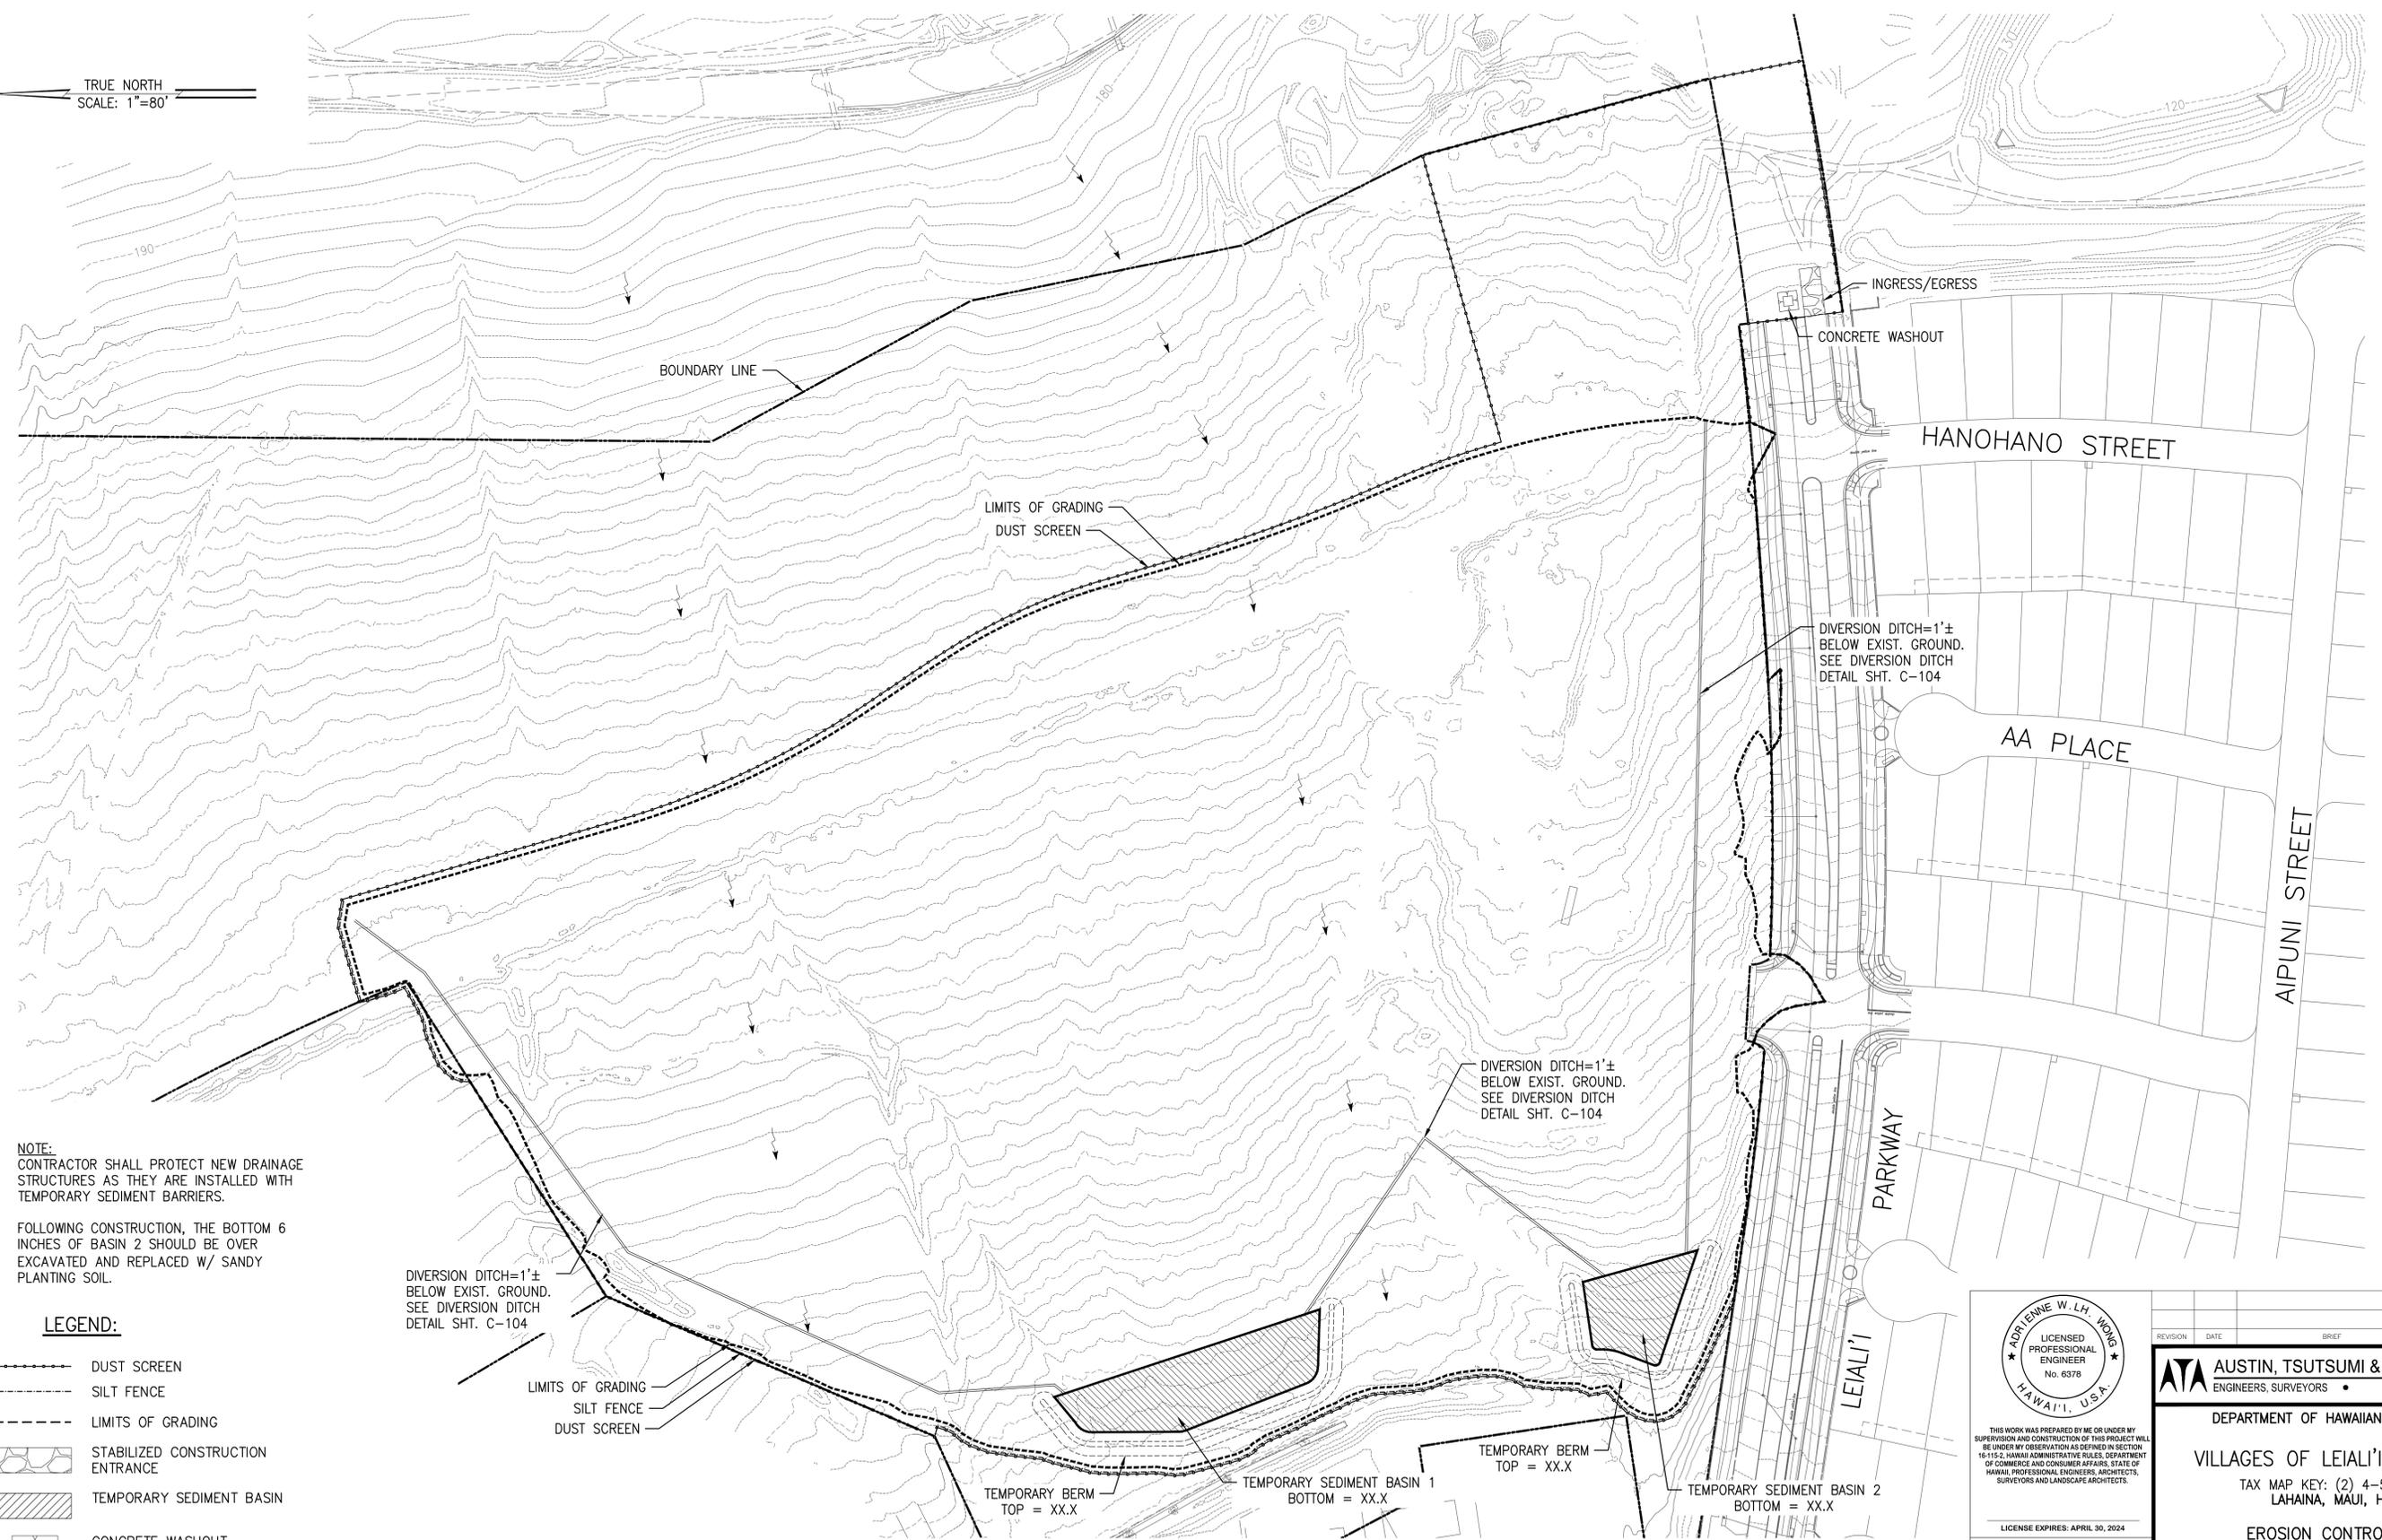

NOTE:
CONTRACTOR SHALL PROTECT NEW DRAINAGE STRUCTURES AS THEY ARE INSTALLED WITH TEMPORARY SEDIMENT BARRIERS.

FOLLOWING CONSTRUCTION, THE BOTTOM 6 INCHES OF BASIN 2 SHOULD BE OVER EXCAVATED AND REPLACED W/ SANDY PLANTING SOIL.

LEGEND:

- DUST SCREEN
- SILT FENCE
- LIMITS OF GRADING
- STABILIZED CONSTRUCTION ENTRANCE
- TEMPORARY SEDIMENT BASIN
- CONCRETE WASHOUT

DIVERSION DITCH=1'±
BELOW EXIST. GROUND.
SEE DIVERSION DITCH
DETAIL SHT. C-104

LIMITS OF GRADING
SILT FENCE
DUST SCREEN

TEMPORARY BERM
TOP = XX.X

TEMPORARY SEDIMENT BASIN 1
BOTTOM = XX.X

TEMPORARY BERM
TOP = XX.X

TEMPORARY SEDIMENT BASIN 2
BOTTOM = XX.X

EROSION CONTROL PLAN
SCALE: 1"=80'



THIS WORK WAS PREPARED BY ME OR UNDER MY SUPERVISION AND CONSTRUCTION OF THIS PROJECT WILL BE UNDER MY OBSERVATION AS DEFINED IN SECTION 16-115-2, HAWAII ADMINISTRATIVE RULES, DEPARTMENT OF COMMERCE AND CONSUMER AFFAIRS, STATE OF HAWAII, PROFESSIONAL ENGINEERS, ARCHITECTS, SURVEYORS AND LANDSCAPE ARCHITECTS.

LICENSE EXPIRES: APRIL 30, 2024

LINE IS 2 INCHES AT FULL SIZE
(If NOT 2-inches : Scale Accordingly)

DWG. NO. **C-103**

SHEET 12 OF

| REVISION | DATE | BRIEF | MADE BY | APPROVED |
|--------------------------------------------------------------------------------------------------------------------------------------------------------------------|------|--------------|---------|------------|
| ATA AUSTIN, TSUTSUMI & ASSOCIATES, INC. ENGINEERS, SURVEYORS • HONOLULU, WAILUKU, HAWAII | | | | |
| DEPARTMENT OF HAWAIIAN HOME LANDS VILLAGES OF LEIALII', PHASE 1B TAX MAP KEY: (2) 4-5-21: 020 LAHAINA, MAUI, HAWAII EROSION CONTROL PLAN | | | | |
| DESIGNED BY | KM | DRAWN BY | ATA | CHECKED BY |
| APPROVED BY | | SUBMITTED BY | | |
| DATE | | FIRM NUMBER | | DATE |

DATE: SEPTEMBER 2023

| FILE | POCKET | FOLDER | NO. |
|------|--------|--------|-----|
| | | | |

TRUE NORTH
SCALE: 1"=80'


PROPERTY LINE

HANOHANO STREET

AA PL.

LIMITS OF GRADING

BASIN 3
TOP=98.00
BOT=88.00

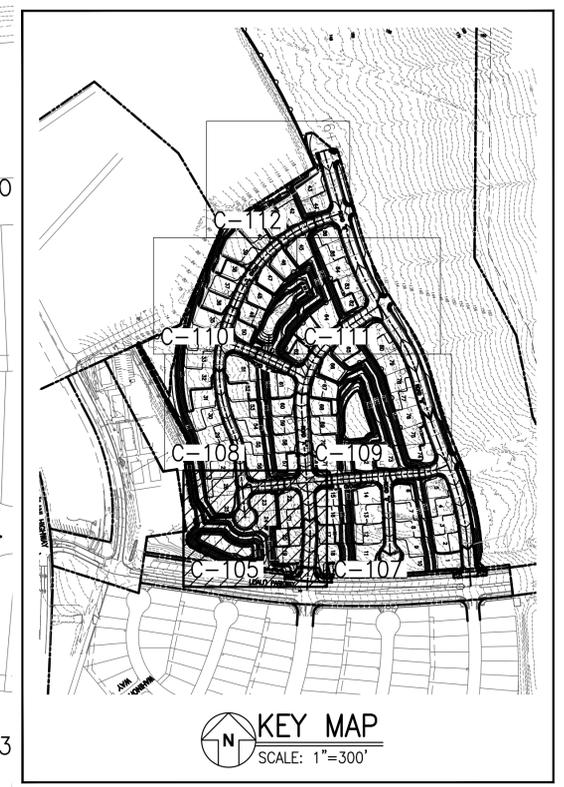

KEY MAP
SCALE: 1"=300'

BASIN 1
TOP=128.00
BOT=122.00

BASIN 2
TOP=92.00
BOT=84.00

BASIN 4
TOP=56.00
BOT=44.00

- LEGEND:**
- PAD HINGE
 - PROPERTY LINE
 - 10 — MAJOR CONTOUR (10-FOOT INTERVAL)
 - 14 — MINOR CONTOUR (2-FOOT INTERVAL)
 - 16 — EXISTING CONTOUR
 - LIMITS OF GRADING

- NOTES:**
- QUANTITIES SHOWN ARE FOR PERMIT PURPOSES AND ESTIMATES ONLY AND SHALL NOT BE USED FOR BIDDING PURPOSES. THE CONTRACTOR IS RESPONSIBLE TO DETERMINE THE EXACT QUANTITIES FOR BIDDING PURPOSES.
 - THE CONTRACTOR SHALL BE RESPONSIBLE TO COMPLETE THE GRADING WORK TO THE GRADES AND DIMENSIONS SHOWN ON THE PLANS. IF IMPORTED MATERIALS ARE REQUIRED TO OBTAIN FINISHED GRADES, THE CONTRACTOR IS REQUIRED TO IMPORT SUITABLE MATERIALS AS SPECIFIED AT THE CONTRACTORS EXPENSE. IF EXCAVATED MATERIALS ARE IN EXCESS, THE CONTRACTOR SHALL BE REQUIRED TO DISPOSE OF THE MATERIALS AWAY FROM THE PROJECT AREA AT THE CONTRACTORS EXPENSE.
 - CONTINGENT UPON THE MATERIAL BEING APPROVED BY THE PROJECT GEOTECHNICAL ENGINEER, IMPORTED BORROW MATERIAL MAY BE OBTAINED FROM THE INCREMENT 2 PARCEL.

ESTIMATED ON-SITE EARTHWORK SUMMARY:

| | |
|------------------------------------------|----------------------|
| AREA OF CLEARING, GRUBBING, AND GRADING: | 25.7 ACRES |
| EXCAVATION VOLUME: | 89,900 CU. YD. |
| EMBANKMENT VOLUME: | 38,700 CU. YD. |
| NET VOLUME: | 52,200 CU. YD. (CUT) |

GENERAL GRADING AND DRAINAGE PLAN
SCALE: 1"=80'



THIS WORK WAS PREPARED BY ME OR UNDER MY SUPERVISION AND CONSTRUCTION OF THIS PROJECT WILL BE UNDER MY OBSERVATION AS DEFINED IN SECTION 16-115-2, HAWAII ADMINISTRATIVE RULES, DEPARTMENT OF COMMERCE AND CONSUMER AFFAIRS, STATE OF HAWAII, PROFESSIONAL ENGINEERS, ARCHITECTS, SURVEYORS AND LANDSCAPE ARCHITECTS.

LICENSE EXPIRES: APRIL 30, 2024

0 1 2
LINE IS 2 INCHES AT FULL SIZE
(IF NOT 2-INCHES : Scale Accordingly)


DWG. NO. **C-105**

SHEET 14 OF

| | | | | |
|---------------------------------------------------------------------------------------------------------------------------------------------------------------------------------------------------------------------------------------------------------------------------------------------------|------|--------------|---------|------------|
| REVISION | DATE | BRIEF | MADE BY | APPROVED |
| <p>ATA AUSTIN, TSUTSUMI & ASSOCIATES, INC. ENGINEERS, SURVEYORS • HONOLULU, WAILUKU, HAWAII</p> <p>DEPARTMENT OF HAWAIIAN HOME LANDS</p> <p>VILLAGES OF LEIALI'I, PHASE 1B TAX MAP KEY: (2) 4-5-21: 020 LAHAINA, MAUI, HAWAII</p> <p>GENERAL GRADING AND DRAINAGE PLAN</p> | | | | |
| DESIGNED BY | KM | DRAWN BY | ATA | CHECKED BY |
| APPROVED BY | | SUBMITTED BY | AW | |
| DATE | | FIRM NUMBER | | DATE |

ATA AUSTIN, TSUTSUMI & ASSOCIATES, INC. 105, GREENE, GRADING AND DRAINAGE PLAN


| | | | |
|------|--------|--------|-----|
| FILE | POCKET | FOLDER | NO. |
| | | | |

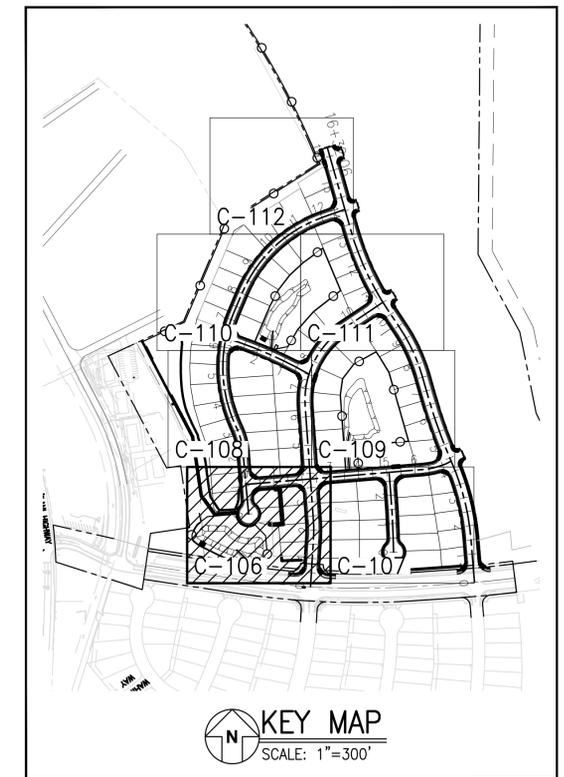

MATCH LINE
FOR CONTINUATION, SEE DWG. C-107

- LEGEND:**
- PAD HINGE
 - PROPERTY LINE
 - 10 — MAJOR CONTOUR (10-FOOT INTERVAL)
 - 14 — MINOR CONTOUR (2-FOOT INTERVAL)
 - 16 --- EXISTING CONTOUR
 - LIMITS OF GRADING

GRADING AND DRAINAGE PLAN - 1
SCALE: 1"=20'

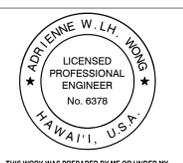

THIS WORK WAS PREPARED BY ME OR UNDER MY SUPERVISION AND CONSTRUCTION OF THIS PROJECT WILL BE UNDER MY OBSERVATION AS DEFINED IN SECTION 16-115-2, HAWAII ADMINISTRATIVE RULES, DEPARTMENT OF COMMERCE AND CONSUMER AFFAIRS, STATE OF HAWAII, PROFESSIONAL ENGINEERS, ARCHITECTS, SURVEYORS AND LANDSCAPE ARCHITECTS.

LICENSE EXPIRES: APRIL 30, 2024


0 1 2
LINE IS 2 INCHES AT FULL SIZE
(IF NOT 2-INCHES : SCALE ACCORDINGLY)

DWG. NO. **C-106**

SHEET 15 OF

| REVISION | DATE | BRIEF | MADE BY | APPROVED |
|--------------------------------------------------------------------------------------------------------------------------------------------------------------------------------------------------------------------------------------------------------------------------------------------------|------|--------------|---------|------------|
| <p>ATA AUSTIN, TSUTSUMI & ASSOCIATES, INC. ENGINEERS, SURVEYORS • HONOLULU, WAILUKU, HAWAII</p> <p>DEPARTMENT OF HAWAIIAN HOME LANDS</p> <p>VILLAGES OF LEIALI'I, PHASE 1B</p> <p>TAX MAP KEY: (2) 4-5-21: 020 LAHAINA, MAUI, HAWAII</p> <p>GRADING AND DRAINAGE PLAN - 1</p> | | | | |
| DESIGNED BY | KM | DRAWN BY | ATA | CHECKED BY |
| APPROVED BY | | SUBMITTED BY | AW | |
| DATE | | FIRM NUMBER | | DATE |

ATA\18-522\DWG\C-106 GRADING AND DRAINAGE PLAN.dwg

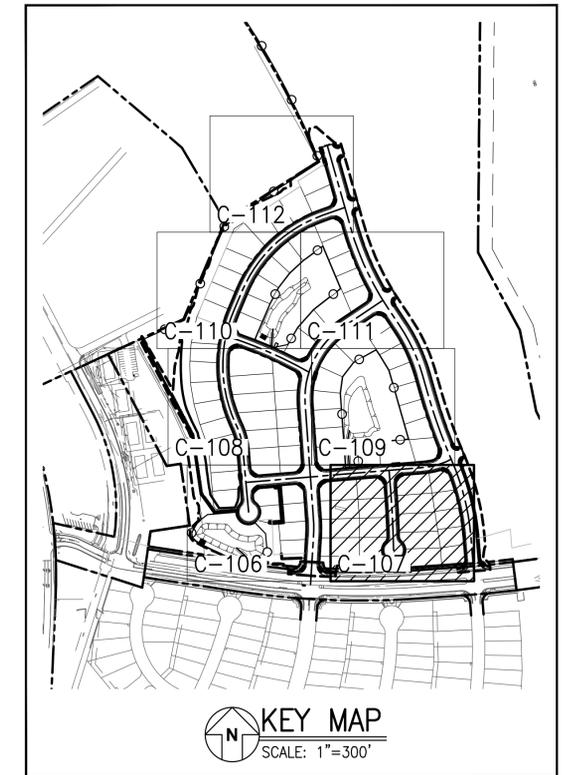

LEGEND:

- PAD HINGE
- PROPERTY LINE
- 10 — MAJOR CONTOUR (10-FOOT INTERVAL)
- 14 — MINOR CONTOUR (2-FOOT INTERVAL)
- 16 --- EXISTING CONTOUR
- LIMITS OF GRADING

GRADING AND DRAINAGE PLAN - 2

SCALE: 1"=20'



THIS WORK WAS PREPARED BY ME OR UNDER MY SUPERVISION AND CONSTRUCTION OF THIS PROJECT WILL BE UNDER MY OBSERVATION AS DEFINED IN SECTION 16-115-2, HAWAII ADMINISTRATIVE RULES, DEPARTMENT OF COMMERCE AND CONSUMER AFFAIRS, STATE OF HAWAII, PROFESSIONAL ENGINEERS, ARCHITECTS, SURVEYORS AND LANDSCAPE ARCHITECTS.

LICENSE EXPIRES: APRIL 30, 2024

0 1 2
LINE IS 2 INCHES AT FULL SIZE
(IF NOT 2-INCHES : SCALE ACCORDINGLY)


DWG. NO. **C-107**

SHEET 16 OF

| REVISION | DATE | BRIEF | MADE BY | APPROVED |
|-----------------------------------------------------------------------------------------------------------------------------------------------------------------------------|------|--------------|---------|------------|
| ATA AUSTIN, TSUTSUMI & ASSOCIATES, INC. ENGINEERS, SURVEYORS • HONOLULU, WAILUKU, HAWAII | | | | |
| DEPARTMENT OF HAWAIIAN HOME LANDS VILLAGES OF LEIALI'I, PHASE 1B TAX MAP KEY: (2) 4-5-21: 020 LAHAINA, MAUI, HAWAII GRADING AND DRAINAGE PLAN - 2 | | | | |
| DESIGNED BY | KM | DRAWN BY | ATA | CHECKED BY |
| APPROVED BY | | SUBMITTED BY | AW | |
| DATE | | FIRM NUMBER | | DATE |



TRUE NORTH
SCALE: 1"=20'

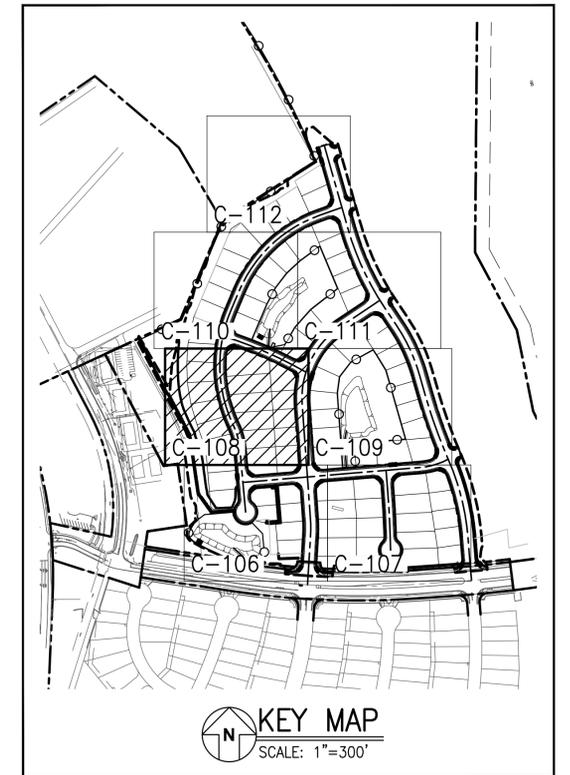

MATCH LINE
FOR CONTINUATION, SEE DWG. C-109

- LEGEND:**
- PAD HINGE
 - PROPERTY LINE
 - 10 — MAJOR CONTOUR (10-FOOT INTERVAL)
 - 14 — MINOR CONTOUR (2-FOOT INTERVAL)
 - 16 --- EXISTING CONTOUR
 - LIMITS OF GRADING

GRADING AND DRAINAGE PLAN - 3
SCALE: 1"=20'


ADRIENNE W. L.H. HOOG
LICENSED PROFESSIONAL ENGINEER
No. 6378
HAWAII, U.S.A.

THIS WORK WAS PREPARED BY ME OR UNDER MY SUPERVISION AND CONSTRUCTION OF THIS PROJECT WILL BE UNDER MY OBSERVATION AS DEFINED IN SECTION 16-115-2, HAWAII ADMINISTRATIVE RULES, DEPARTMENT OF COMMERCE AND CONSUMER AFFAIRS, STATE OF HAWAII, PROFESSIONAL ENGINEERS, ARCHITECTS, SURVEYORS AND LANDSCAPE ARCHITECTS.

LICENSE EXPIRES: APRIL 30, 2024


0 1 2
LINE IS 2 INCHES AT FULL SIZE
(IF NOT 2-INCHES : Scale Accordingly)

| REVISION | DATE | BRIEF | MADE BY | APPROVED |
|------------------------------------------------------------------------------------------------------------------------------------------------------------------------------------------------------------------------------------------------------------------------------------------------------------------------------------------------------------------------------------------------------------------------------------------------------------------------------------------------------------------------------|------|--------------------------------------------|---------|-----------------------|
| <p style="font-weight: bold; font-size: 12px;">ATA AUSTIN, TSUTSUMI & ASSOCIATES, INC.</p> <p style="font-size: 8px;">ENGINEERS, SURVEYORS • HONOLULU, WAILUKU, HAWAII</p> <p style="font-weight: bold; font-size: 10px;">DEPARTMENT OF HAWAIIAN HOME LANDS</p> <p style="font-weight: bold; font-size: 12px;">VILLAGES OF LEIALI'I, PHASE 1B</p> <p style="font-size: 8px;">TAX MAP KEY: (2) 4-5-21: 020 LAHAINA, MAUI, HAWAII</p> <p style="font-weight: bold; font-size: 10px;">GRADING AND DRAINAGE PLAN - 3</p> | | | | |
| DESIGNED BY: KM | | DRAWN BY: ATA | | CHECKED BY: AW |
| DWG. NO. C-108 | | APPROVED BY: _____ SUBMITTED BY: _____ | | |
| SHEET 17 OF | | DATE: _____ FIRM NUMBER: _____ DATE: _____ | | |

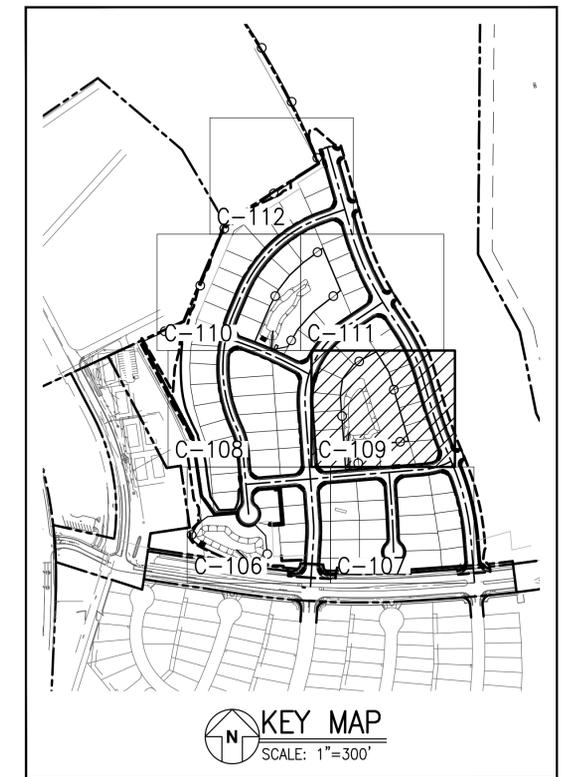

- LEGEND:**
- PAD HINGE
 - PROPERTY LINE
 - 10 — MAJOR CONTOUR (10-FOOT INTERVAL)
 - 14 — MINOR CONTOUR (2-FOOT INTERVAL)
 - 16 --- EXISTING CONTOUR
 - LIMITS OF GRADING

GRADING AND DRAINAGE PLAN - 4
SCALE: 1"=20'


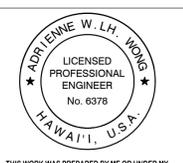


THIS WORK WAS PREPARED BY ME OR UNDER MY SUPERVISION AND CONSTRUCTION OF THIS PROJECT WILL BE UNDER MY OBSERVATION AS DEFINED IN SECTION 16-115-2, HAWAII ADMINISTRATIVE RULES, DEPARTMENT OF COMMERCE AND CONSUMER AFFAIRS, STATE OF HAWAII, PROFESSIONAL ENGINEERS, ARCHITECTS, SURVEYORS AND LANDSCAPE ARCHITECTS.

LICENSE EXPIRES: APRIL 30, 2024
 0 1 2
 LINE IS 2 INCHES AT FULL SIZE
 (IF NOT 2-INCHES : Scale Accordingly)
 DWG. NO. **C-109**
 SHEET 18 OF

| REVISION | DATE | BRIEF | MADE BY | APPROVED |
|---------------------------------------------------------------------------------------------------------------------------------------------------------------------------------------------------------------------------------------------------------------------------------------|------|--------------|---------|------------|
| ATA AUSTIN, TSUTSUMI & ASSOCIATES, INC. ENGINEERS, SURVEYORS • HONOLULU, WAILUKU, HAWAII DEPARTMENT OF HAWAIIAN HOME LANDS VILLAGES OF LEIALI'I, PHASE 1B TAX MAP KEY: (2) 4-5-21: 020 LAHAINA, MAUI, HAWAII GRADING AND DRAINAGE PLAN - 4 | | | | |
| DESIGNED BY | KM | DRAWN BY | ATA | CHECKED BY |
| APPROVED BY | | SUBMITTED BY | AW | |
| DATE | | FIRM NUMBER | | DATE |

ATA\18-522\DWG\C-109 GRADING AND DRAINAGE PLAN.dwg

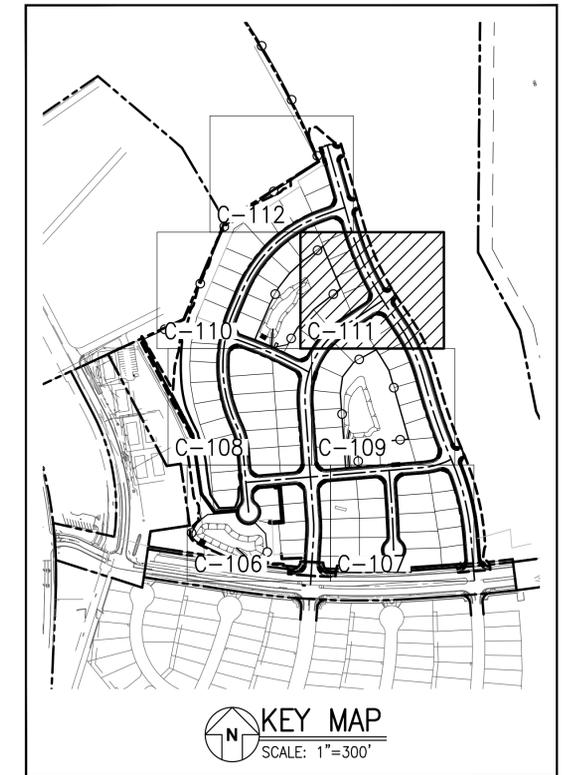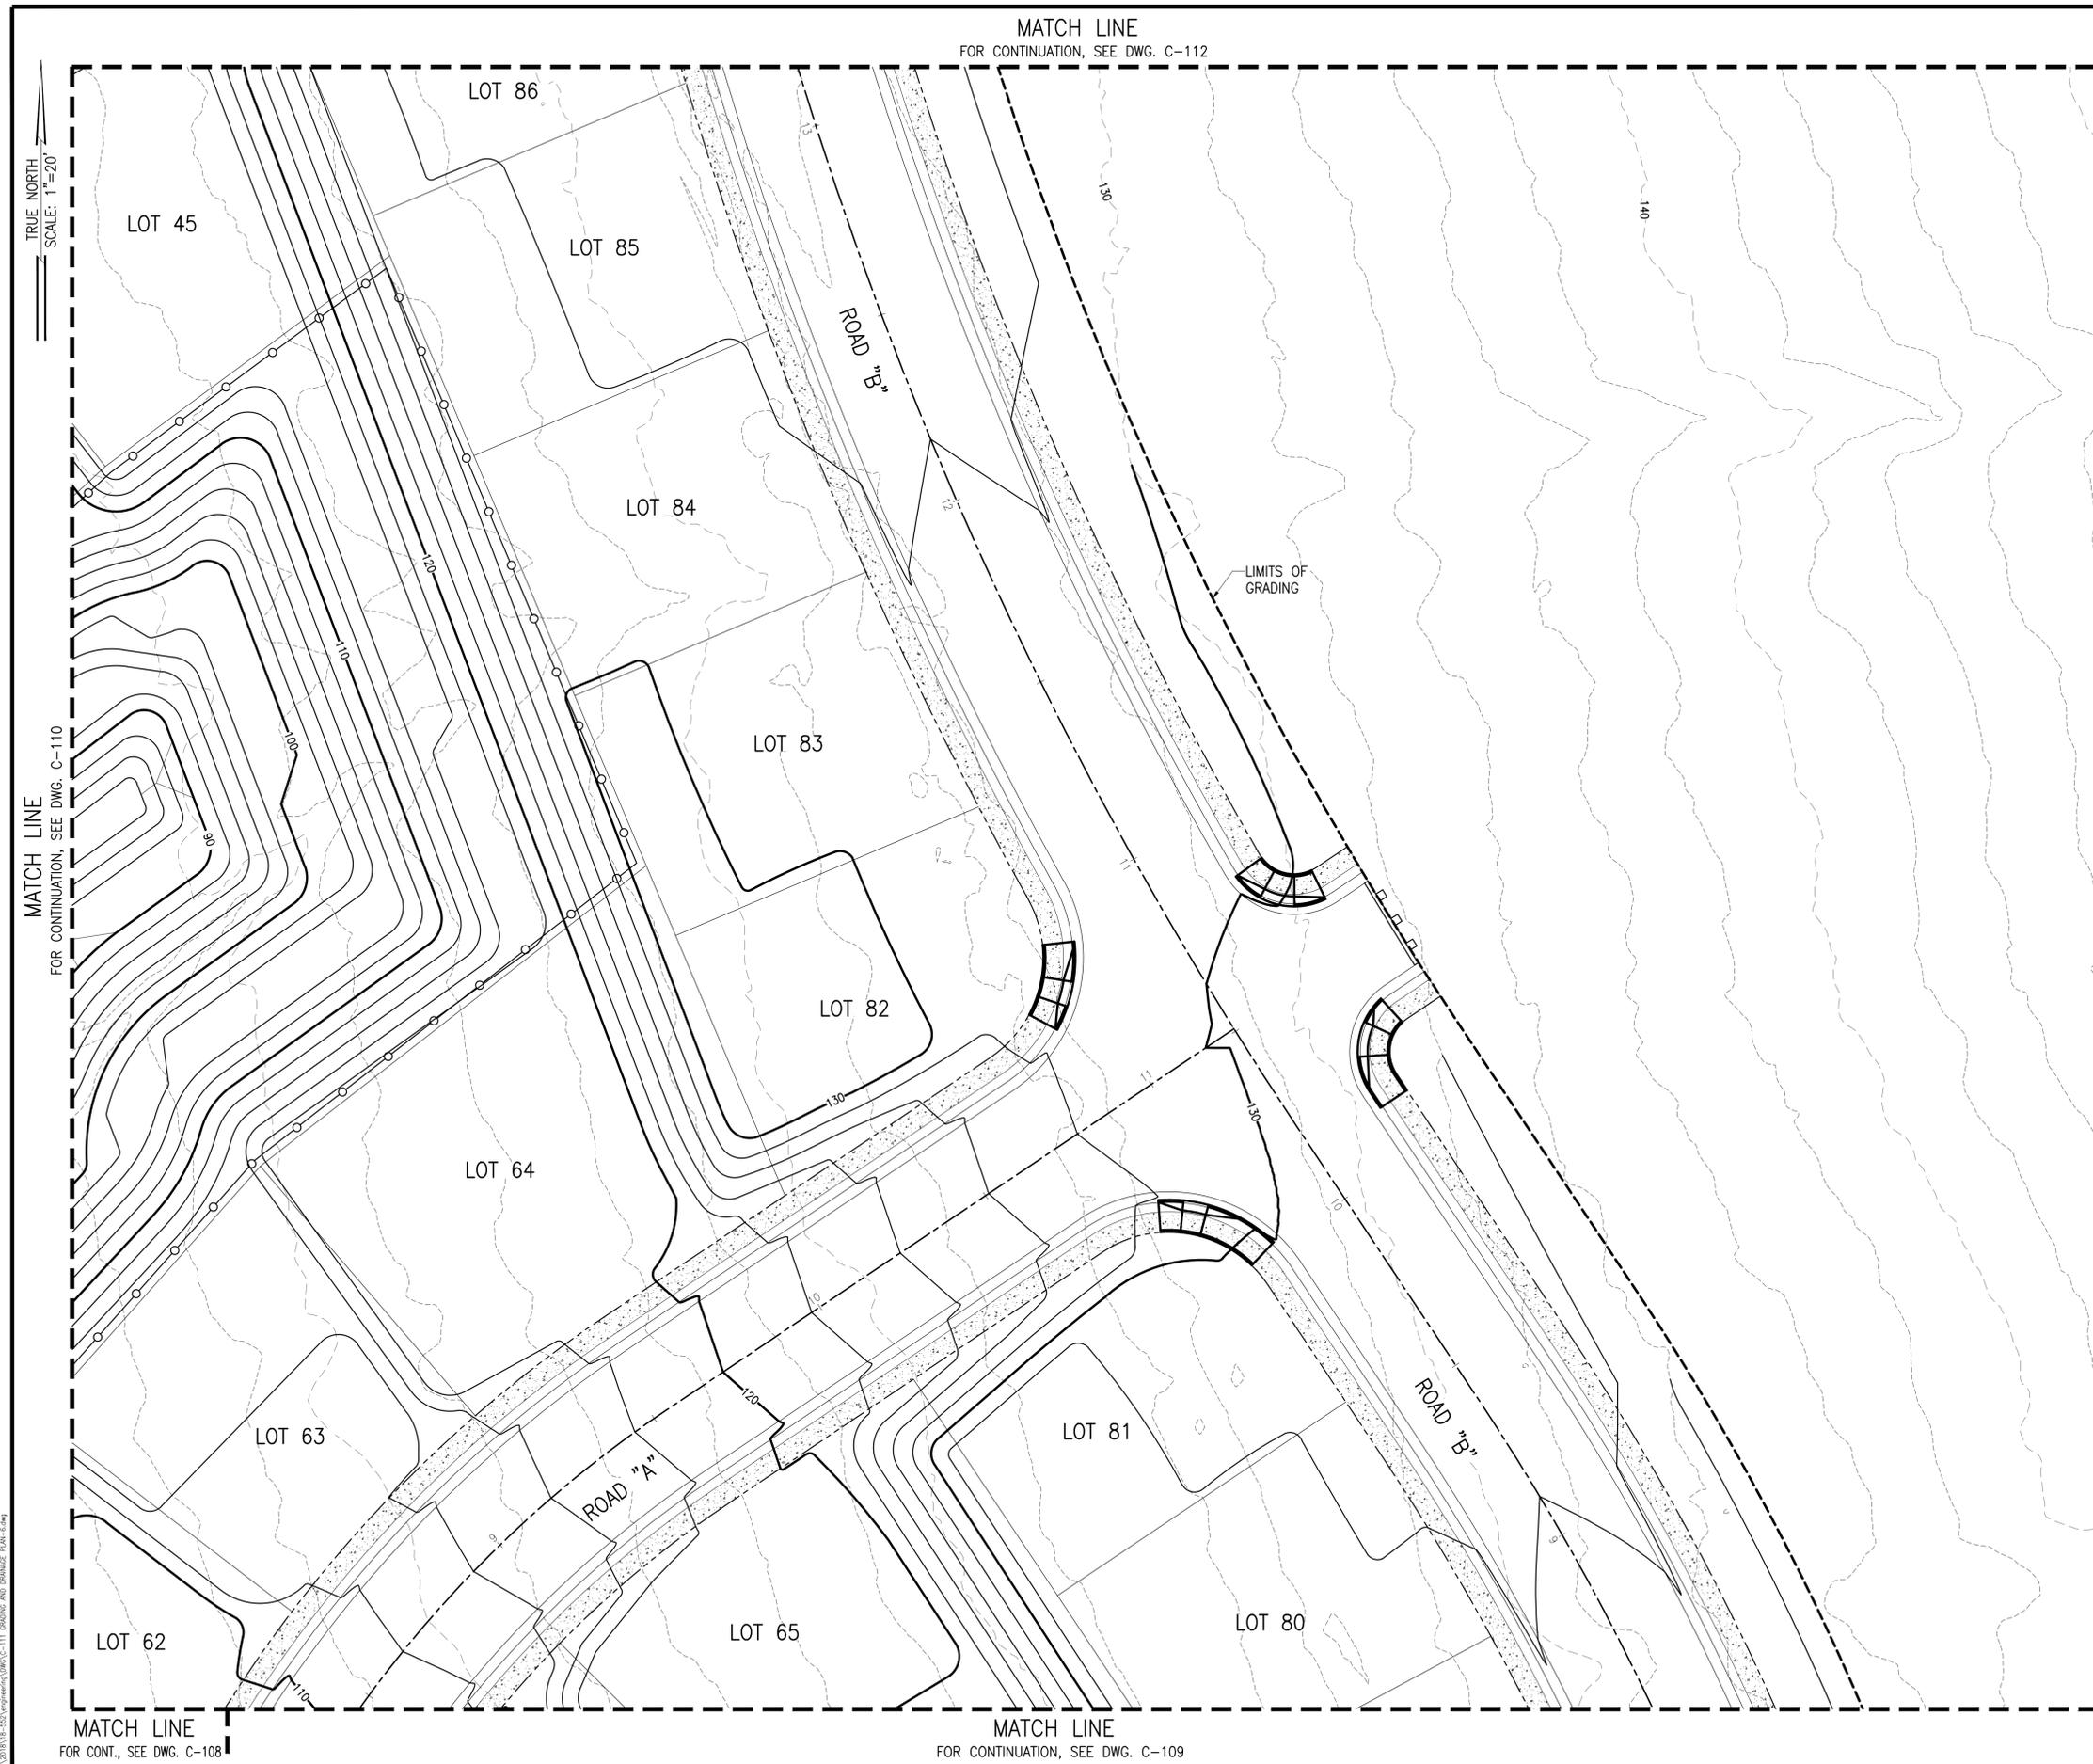

LEGEND:

- PAD HINGE
- PROPERTY LINE
- 10 — MAJOR CONTOUR (10-FOOT INTERVAL)
- 14 — MINOR CONTOUR (2-FOOT INTERVAL)
- 16 --- EXISTING CONTOUR
- LIMITS OF GRADING

GRADING AND DRAINAGE PLAN - 6

SCALE: 1"=20'



THIS WORK WAS PREPARED BY ME OR UNDER MY SUPERVISION AND CONSTRUCTION OF THIS PROJECT WILL BE UNDER MY OBSERVATION AS DEFINED IN SECTION 16-115-2, HAWAII ADMINISTRATIVE RULES, DEPARTMENT OF COMMERCE AND CONSUMER AFFAIRS, STATE OF HAWAII, PROFESSIONAL ENGINEERS, ARCHITECTS, SURVEYORS AND LANDSCAPE ARCHITECTS.

LICENSE EXPIRES: APRIL 30, 2024

0 1 2
LINE IS 2 INCHES AT FULL SIZE
(IF NOT 2-INCHES : Scale Accordingly)

DWG. NO. **C-111**

SHEET 20 OF



| | | | | |
|-----------------------------------------------------------------------------------------------------------------------------------------------------------------------------|----------------------|--------------------------------|--------------------|----------|
| REVISION | DATE | BRIEF | MADE BY | APPROVED |
| ATA AUSTIN, TSUTSUMI & ASSOCIATES, INC. ENGINEERS, SURVEYORS • HONOLULU, WAILUKU, HAWAII | | | | |
| DEPARTMENT OF HAWAIIAN HOME LANDS VILLAGES OF LEIALI'I, PHASE 1B TAX MAP KEY: (2) 4-5-21: 020 LAHAINA, MAUI, HAWAII GRADING AND DRAINAGE PLAN - 6 | | | | |
| DESIGNED BY: KM | DRAWN BY: ATA | CHECKED BY: AW | APPROVED BY: _____ | |
| SUBMITTED BY: _____ | | DATE: _____ FIRM NUMBER: _____ | | |

ATA\2018-18-522\DWG\C-111 GRADING AND DRAINAGE PLAN.dwg

| | | | |
|------|--------|--------|-----|
| FILE | POCKET | FOLDER | NO. |
| | | | |

TRUE NORTH
SCALE: 1"=20'

TMK: (2) 4-5-021: 018
HOUSING FINANCE AND DEVELOPMENT CORP

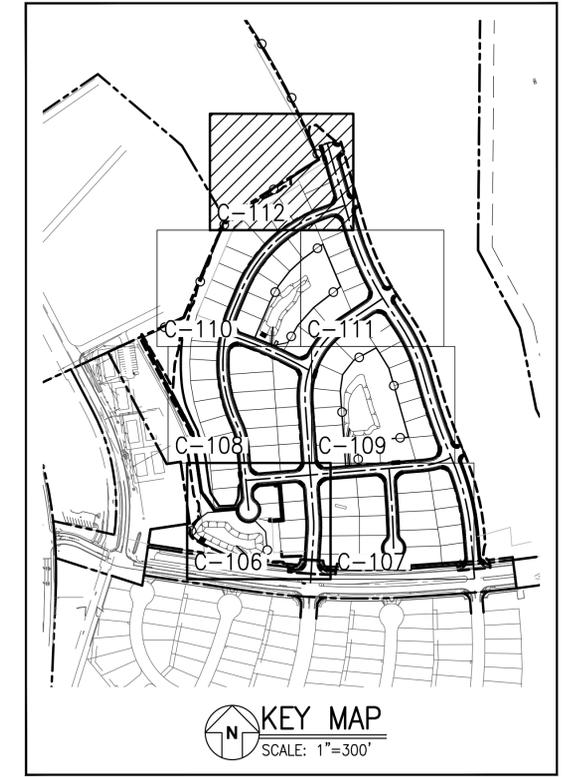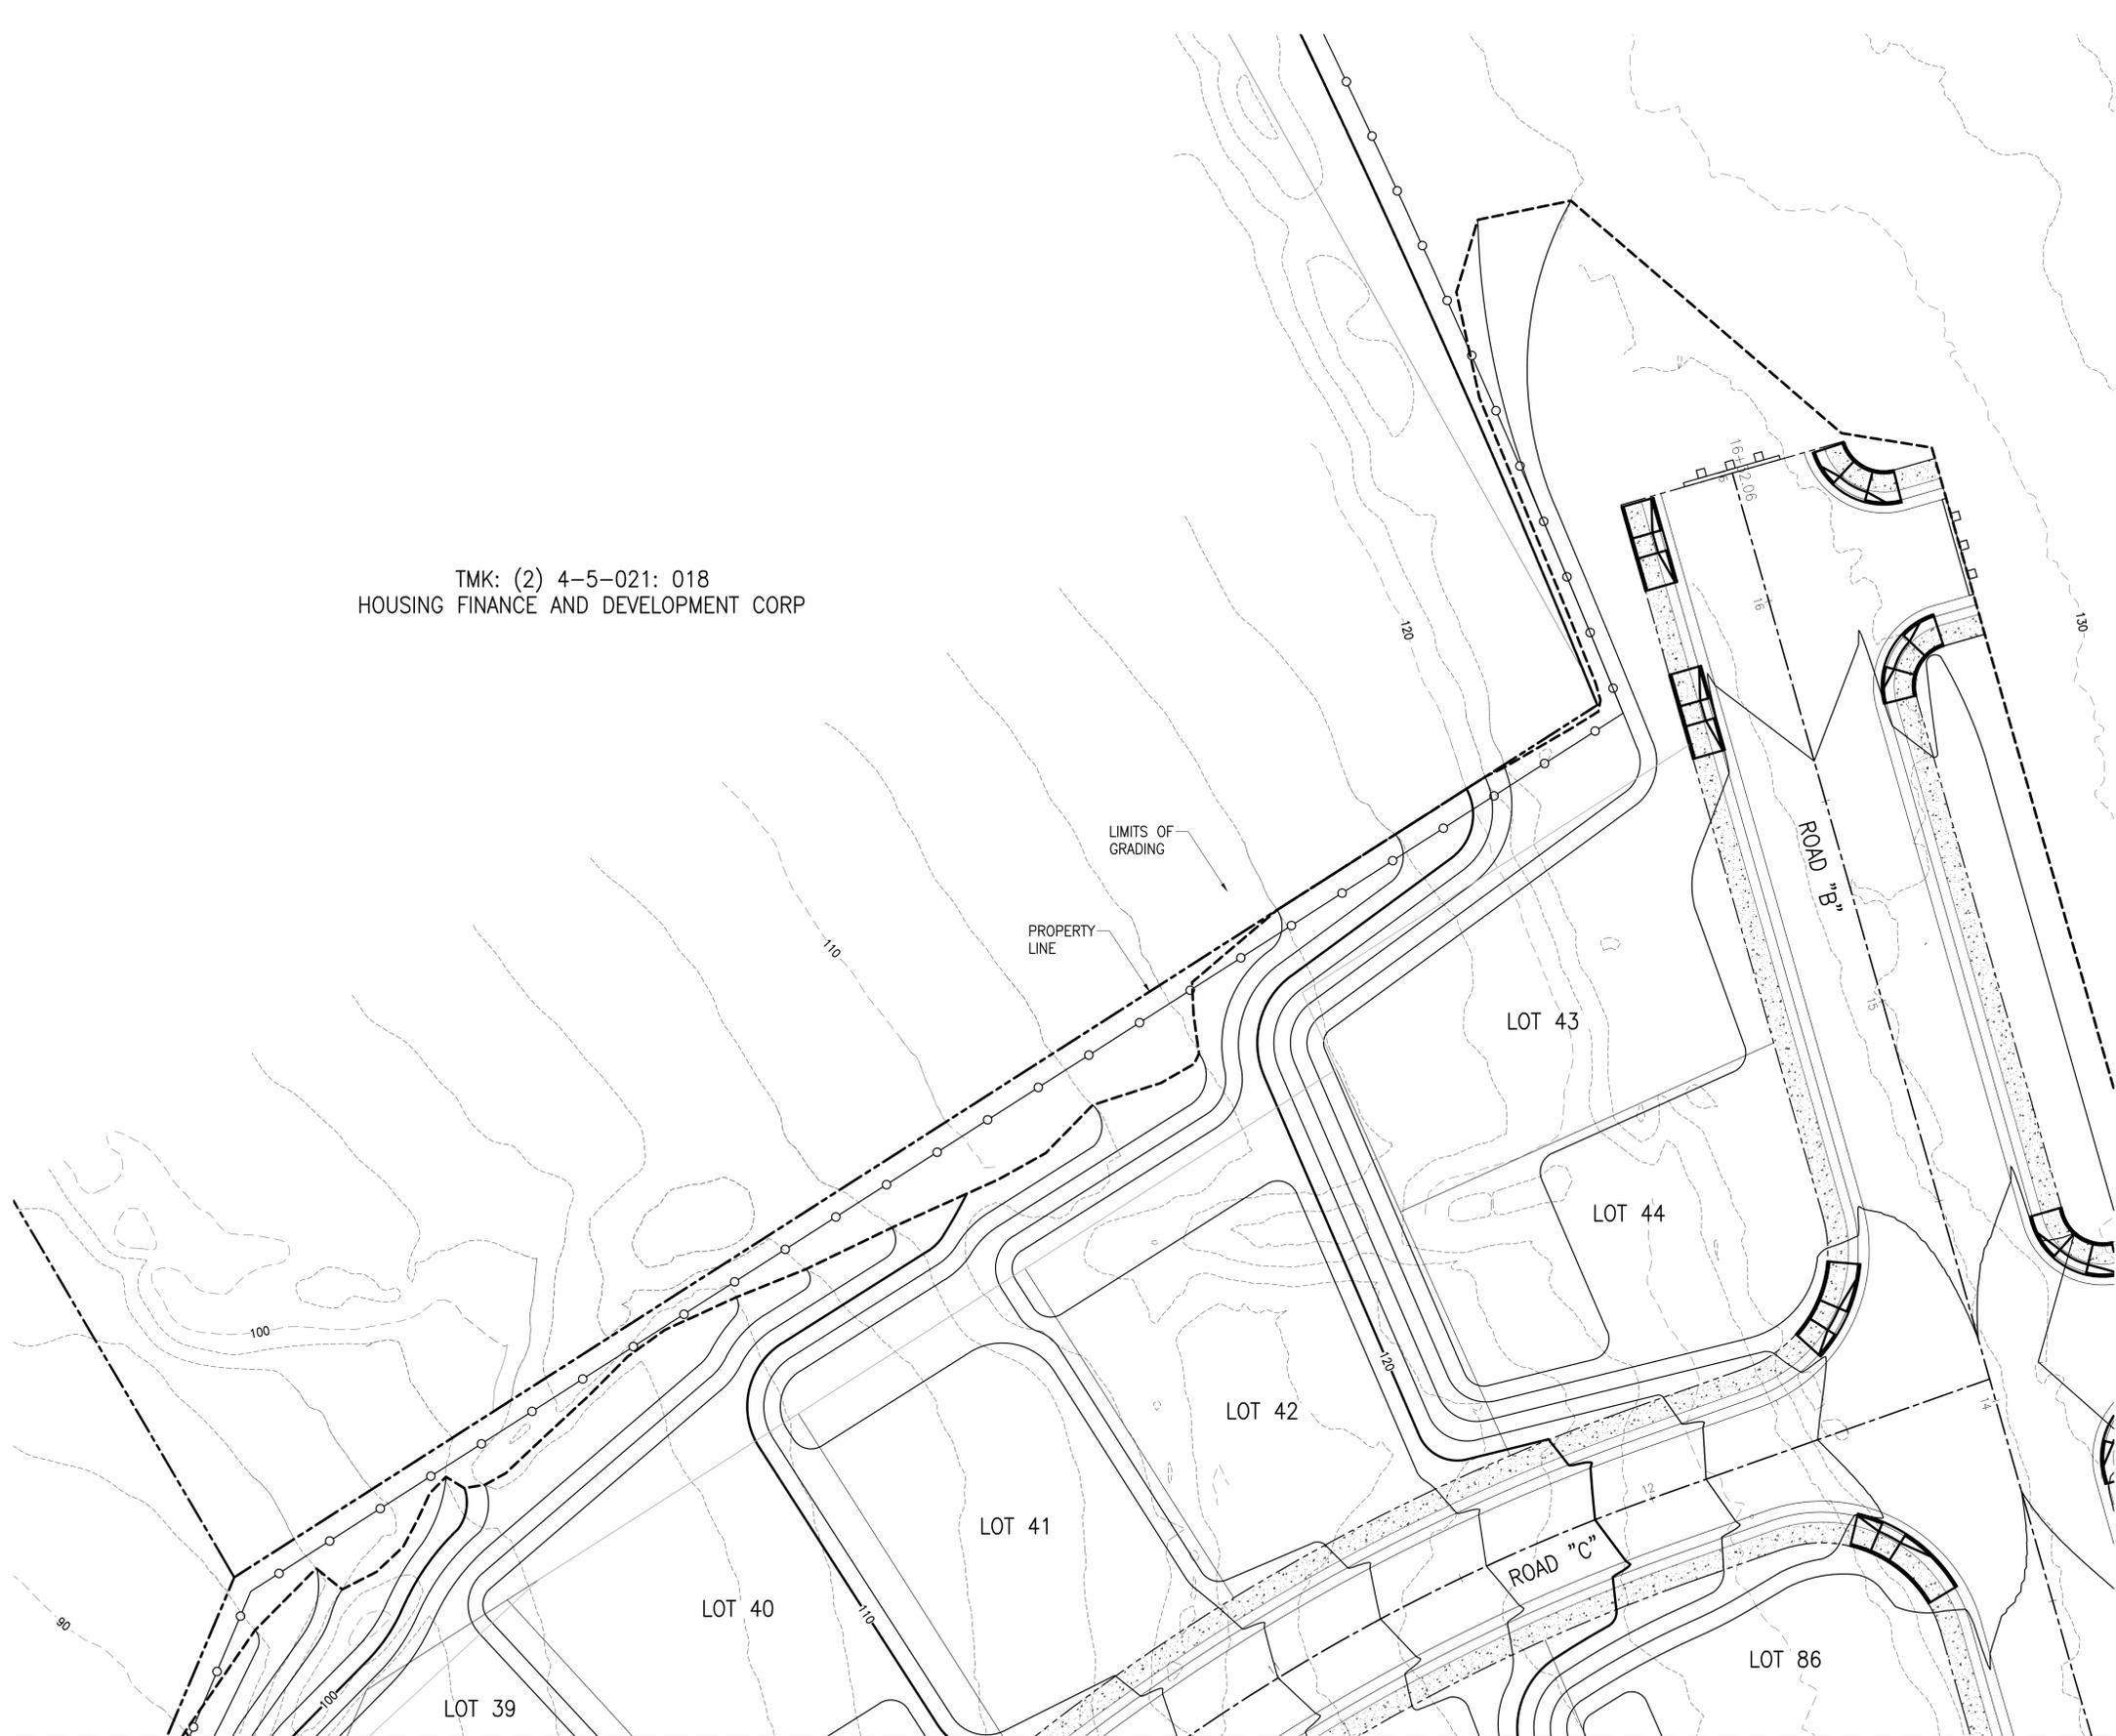

- LEGEND:**
- PAD HINGE
 - PROPERTY LINE
 - 10 — MAJOR CONTOUR (10-FOOT INTERVAL)
 - 14 — MINOR CONTOUR (2-FOOT INTERVAL)
 - 16 --- EXISTING CONTOUR
 - LIMITS OF GRADING

GRADING AND DRAINAGE PLAN - 7
SCALE: 1"=20'



THIS WORK WAS PREPARED BY ME OR UNDER MY SUPERVISION AND CONSTRUCTION OF THIS PROJECT WILL BE UNDER MY OBSERVATION AS DEFINED IN SECTION 16-115-2, HAWAII ADMINISTRATIVE RULES, DEPARTMENT OF COMMERCE AND CONSUMER AFFAIRS, STATE OF HAWAII, PROFESSIONAL ENGINEERS, ARCHITECTS, SURVEYORS AND LANDSCAPE ARCHITECTS.


LICENSE EXPIRES: APRIL 30, 2024

0 1 2
LINE IS 2 INCHES AT FULL SIZE
(IF NOT 2-INCHES : Scale Accordingly)


DWG. NO. **C-112**

SHEET 21 OF


| | | | | |
|-----------------------------------------------------------------------------------------------------------------------------------------------------------------------------|------|--------------|---------|------------|
| REVISION | DATE | BRIEF | MADE BY | APPROVED |
| ATA AUSTIN, TSUTSUMI & ASSOCIATES, INC. ENGINEERS, SURVEYORS • HONOLULU, WAILUKU, HAWAII | | | | |
| DEPARTMENT OF HAWAIIAN HOME LANDS VILLAGES OF LEIALI'I, PHASE 1B TAX MAP KEY: (2) 4-5-21: 020 LAHAINA, MAUI, HAWAII GRADING AND DRAINAGE PLAN - 7 | | | | |
| DESIGNED BY | KM | DRAWN BY | ATA | CHECKED BY |
| APPROVED BY | | SUBMITTED BY | AW | |
| DATE | | FIRM NUMBER | | DATE |

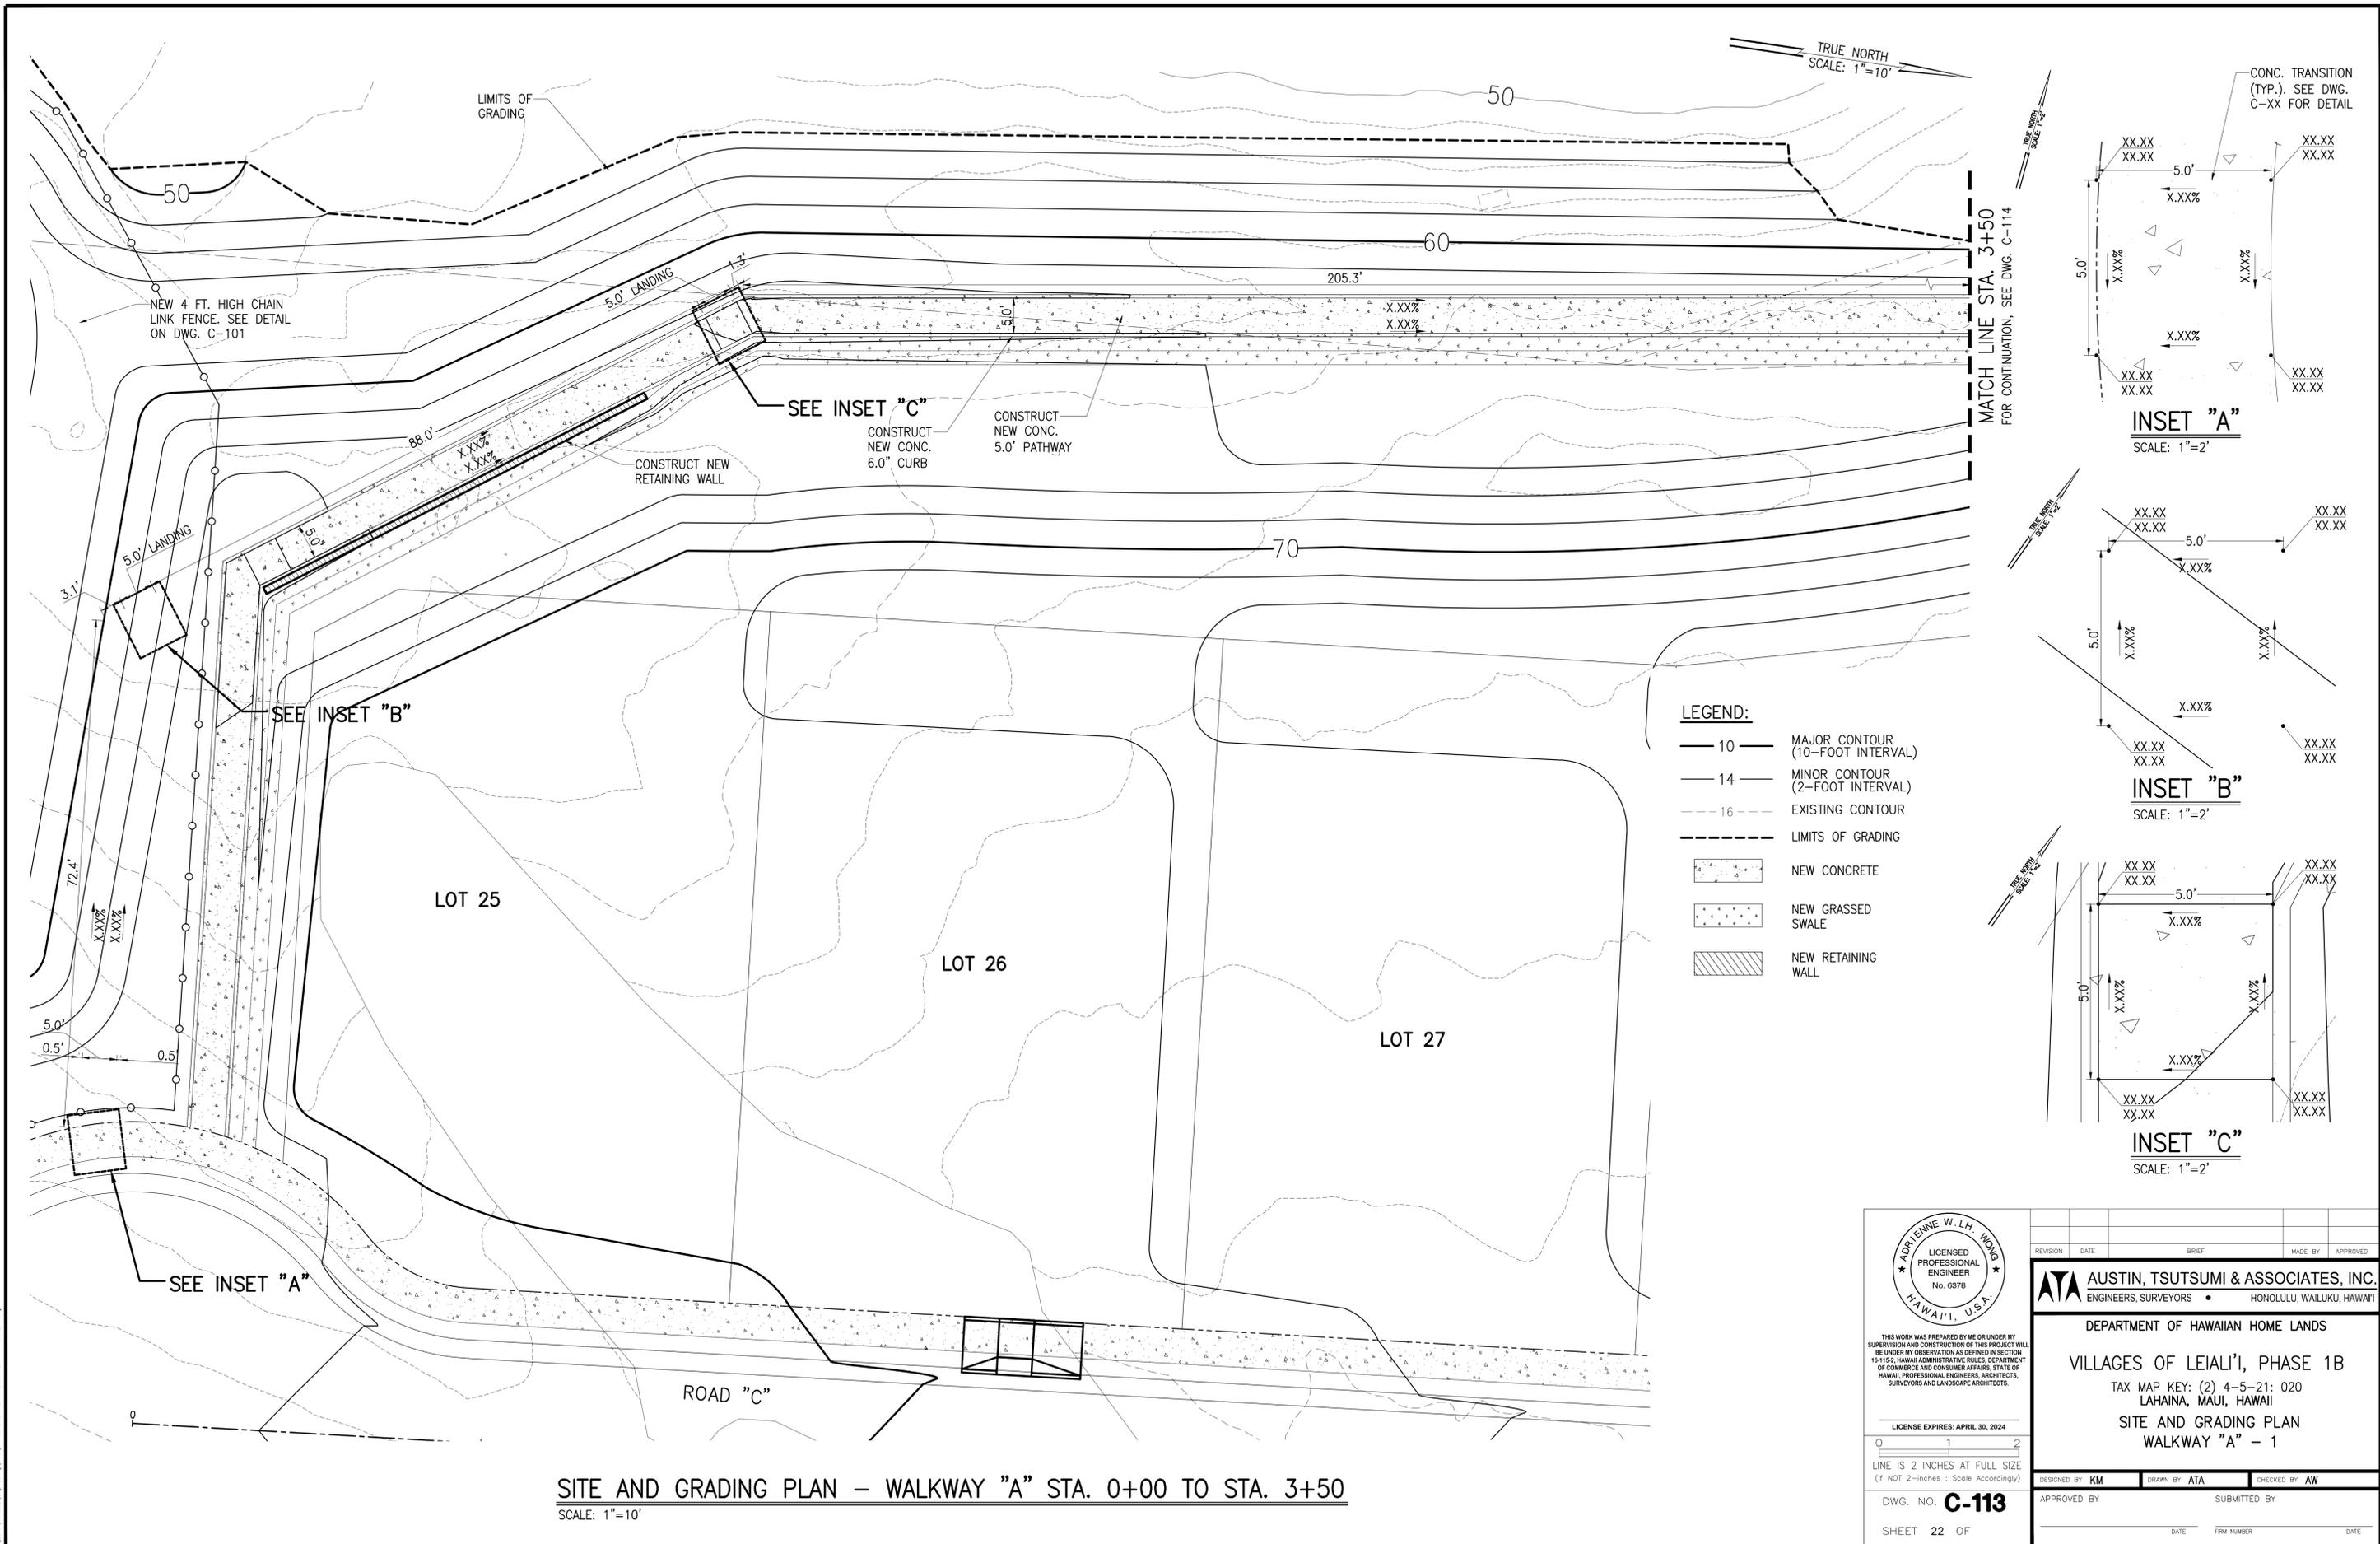


CONC. TRANSITION (TYP.). SEE DWG. C-XX FOR DETAIL.

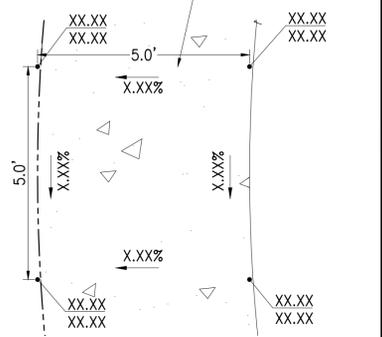

INSET "A"
SCALE: 1"=2'

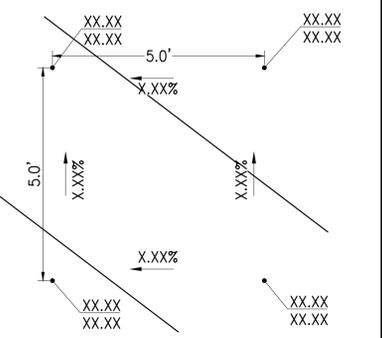


INSET "B"
SCALE: 1"=2'

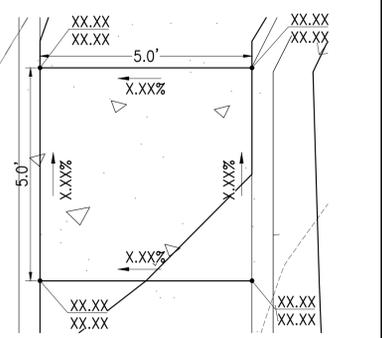

INSET "C"
SCALE: 1"=2'

- LEGEND:**
- 10 — MAJOR CONTOUR (10-FOOT INTERVAL)
 - 14 — MINOR CONTOUR (2-FOOT INTERVAL)
 - - - 16 - - - EXISTING CONTOUR
 - - - - - LIMITS OF GRADING
 - [Pattern] NEW CONCRETE
 - [Pattern] NEW GRASSED SWALE
 - [Pattern] NEW RETAINING WALL

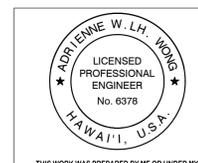

THIS WORK WAS PREPARED BY ME OR UNDER MY SUPERVISION AND CONSTRUCTION OF THIS PROJECT WILL BE UNDER MY OBSERVATION AS DEFINED IN SECTION 16-115-2, HAWAII ADMINISTRATIVE RULES, DEPARTMENT OF COMMERCE AND CONSUMER AFFAIRS, STATE OF HAWAII, PROFESSIONAL ENGINEERS, ARCHITECTS, SURVEYORS AND LANDSCAPE ARCHITECTS.

LICENSE EXPIRES: APRIL 30, 2024


LINE IS 2 INCHES AT FULL SIZE (IF NOT 2-INCHES : SCALE ACCORDINGLY)

DWG. NO. **C-113**

SHEET 22 OF

| REVISION | DATE | BRIEF | MADE BY | APPROVED |
|-----------------------------------------------------------------------------------------------------------------------------------------------------------------------------------------------|------|--------------|---------|------------|
| ATA AUSTIN, TSUTSUMI & ASSOCIATES, INC. ENGINEERS, SURVEYORS • HONOLULU, WAILUKU, HAWAII | | | | |
| DEPARTMENT OF HAWAIIAN HOME LANDS VILLAGES OF LEIALI'I, PHASE 1B TAX MAP KEY: (2) 4-5-21: 020 LAHAINA, MAUI, HAWAII SITE AND GRADING PLAN WALKWAY "A" - 1 | | | | |
| DESIGNED BY | KM | DRAWN BY | ATA | CHECKED BY |
| APPROVED BY | | SUBMITTED BY | | |
| DATE | | FIRM NUMBER | | DATE |



SITE AND GRADING PLAN - WALKWAY "A" STA. 0+00 TO STA. 3+50
SCALE: 1"=10'

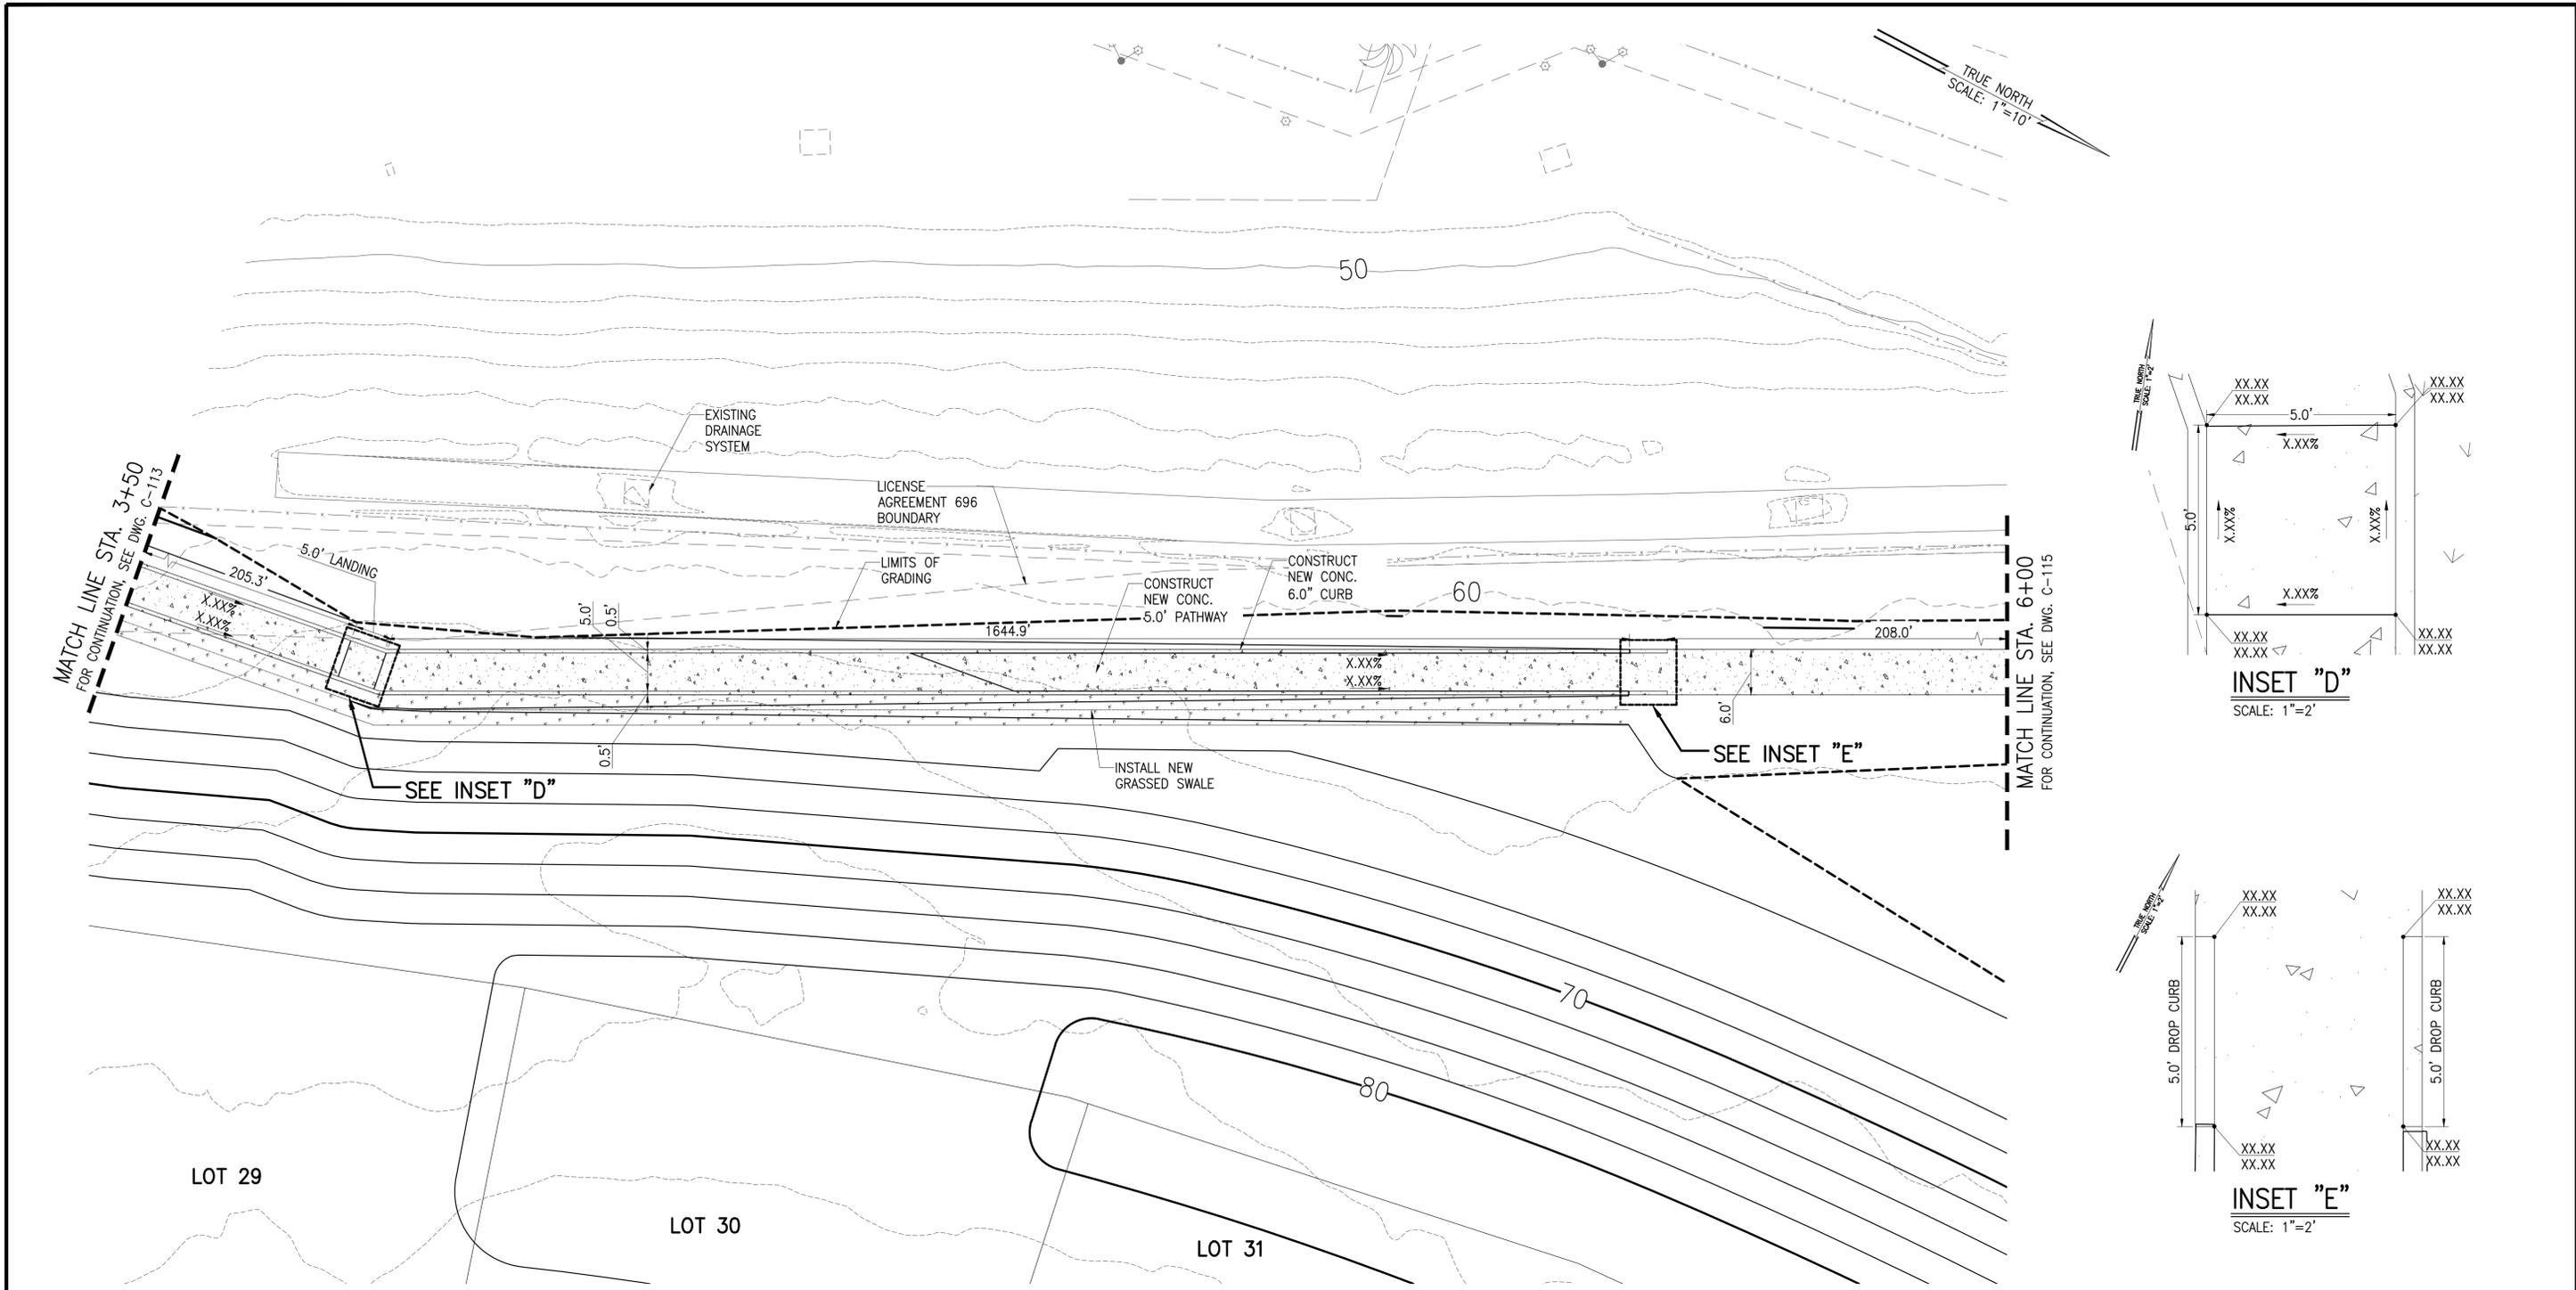

TRUE NORTH
SCALE: 1"=10'

MATCH LINE STA. 3+50
FOR CONTINUATION, SEE DWG. C-113

MATCH LINE STA. 6+00
FOR CONTINUATION, SEE DWG. C-115

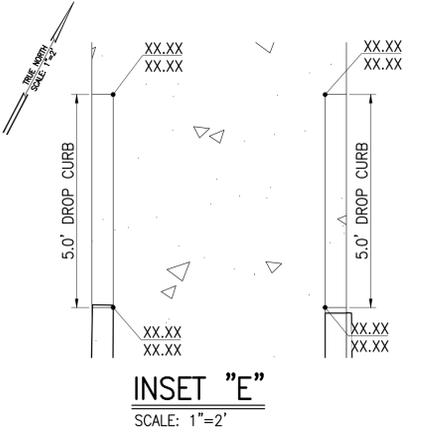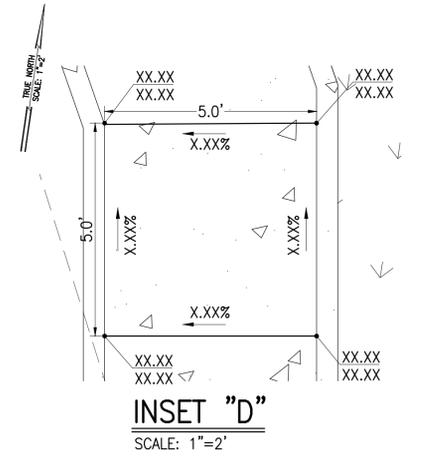

- LEGEND:**
- 10 — MAJOR CONTOUR (10-FOOT INTERVAL)
 - 14 — MINOR CONTOUR (2-FOOT INTERVAL)
 - - - 16 - - - EXISTING CONTOUR
 - - - - - LIMITS OF GRADING
 - [Pattern] NEW CONCRETE
 - [Pattern] NEW GRASSED SWALE

SITE AND GRADING PLAN – WALKWAY "A" STA. 3+50 TO STA. 6+00
SCALE: 1"=10'



THIS WORK WAS PREPARED BY ME OR UNDER MY SUPERVISION AND CONSTRUCTION OF THIS PROJECT WILL BE UNDER MY OBSERVATION AS DEFINED IN SECTION 16-115-2, HAWAII ADMINISTRATIVE RULES, DEPARTMENT OF COMMERCE AND CONSUMER AFFAIRS, STATE OF HAWAII, PROFESSIONAL ENGINEERS, ARCHITECTS, SURVEYORS AND LANDSCAPE ARCHITECTS.

LICENSE EXPIRES: APRIL 30, 2024

LINE IS 2 INCHES AT FULL SIZE
(If NOT 2-inches : Scale Accordingly)


DWG. NO. **C-114**

SHEET 23 OF


| REVISION | DATE | BRIEF | MADE BY | APPROVED | |
|--------------------------------------------------------------------------------------------------------------------------------------------------------------------------------------------------------------------------------------------------------------------------------------------------------------|------|--------------|---------|------------|----|
| <p>ATA AUSTIN, TSUTSUMI & ASSOCIATES, INC. ENGINEERS, SURVEYORS • HONOLULU, WAILUKU, HAWAII</p> <p>DEPARTMENT OF HAWAIIAN HOME LANDS</p> <p>VILLAGES OF LEIALI'I, PHASE 1B</p> <p>TAX MAP KEY: (2) 4-5-21: 020 LAHAINA, MAUI, HAWAII</p> <p>SITE AND GRADING PLAN WALKWAY "A" - 2</p> | | | | | |
| DESIGNED BY | KM | DRAWN BY | ATA | CHECKED BY | AW |
| APPROVED BY | | SUBMITTED BY | | | |
| DATE | | FIRM NUMBER | | DATE | |

A:\2018\18-522\18-522.dwg (C-114) SITE AND GRADING PLAN WALKWAY A - 2.dwg

| | | | |
|------|--------|--------|-----|
| FILE | POCKET | FOLDER | NO. |
|------|--------|--------|-----|

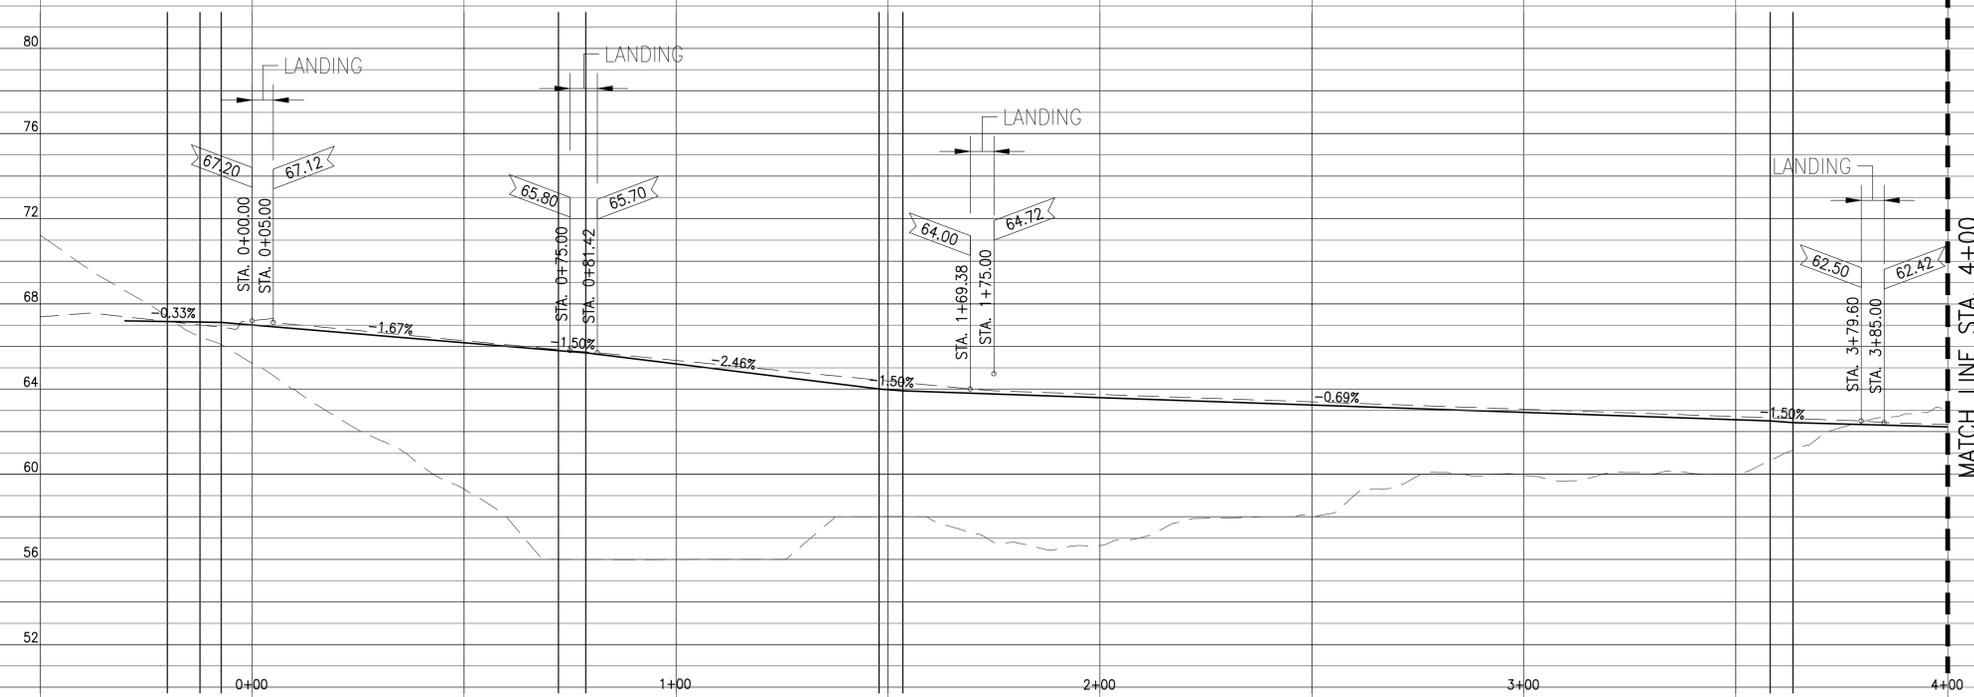

PROFILE – ADA PEDESTRIAN ROUTE "A" STA. 0+00 TO STA. 4+00
SCALE: 1"=20'

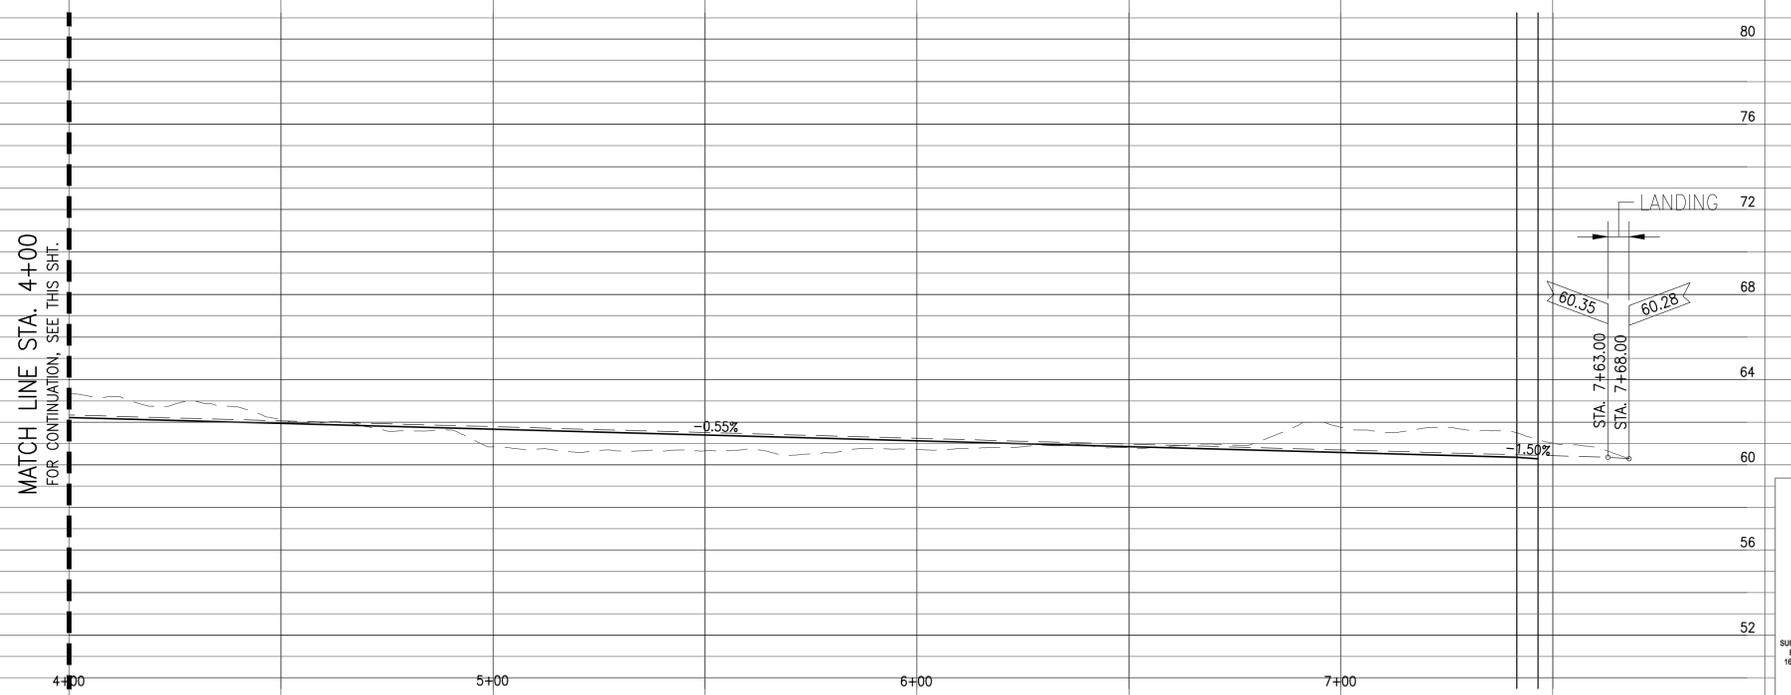

PROFILE – ADA PEDESTRIAN ROUTE "A" STA. 4+00 TO STA. END
SCALE: 1"=20'






THIS WORK WAS PREPARED BY ME OR UNDER MY SUPERVISION AND CONSTRUCTION OF THIS PROJECT WILL BE UNDER MY OBSERVATION AS DEFINED IN SECTION 16-115-2, HAWAII ADMINISTRATIVE RULES, DEPARTMENT OF COMMERCE AND CONSUMER AFFAIRS, STATE OF HAWAII, PROFESSIONAL ENGINEERS, ARCHITECTS, SURVEYORS AND LANDSCAPE ARCHITECTS.

LICENSE EXPIRES: APRIL 30, 2024

0 1 2
LINE IS 2 INCHES AT FULL SIZE
(IF NOT 2-INCHES : SCALE ACCORDINGLY)

DWG. NO. **C-116**
SHEET 25 OF

| REVISION | DATE | BRIEF | MADE BY | APPROVED |
|-------------------------------------------------------------------------------------------------------------------------------------------------------------------|-----------|--------------|------------|------------|
| AUSTIN, TSUTSUMI & ASSOCIATES, INC. ENGINEERS, SURVEYORS • HONOLULU, WAILUKU, HAWAII | | | | |
| DEPARTMENT OF HAWAIIAN HOME LANDS VILLAGES OF LEIALI'I, PHASE 1B TAX MAP KEY: (2) 4-5-21: 020 LAHAINA, MAUI, HAWAII PROFILE WALKWAY "A" | | | | |
| DESIGNED BY | KM | DRAWN BY | ATA | CHECKED BY |
| APPROVED BY | | SUBMITTED BY | | |
| DATE | | FIRM NUMBER | | DATE |

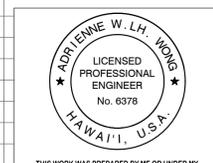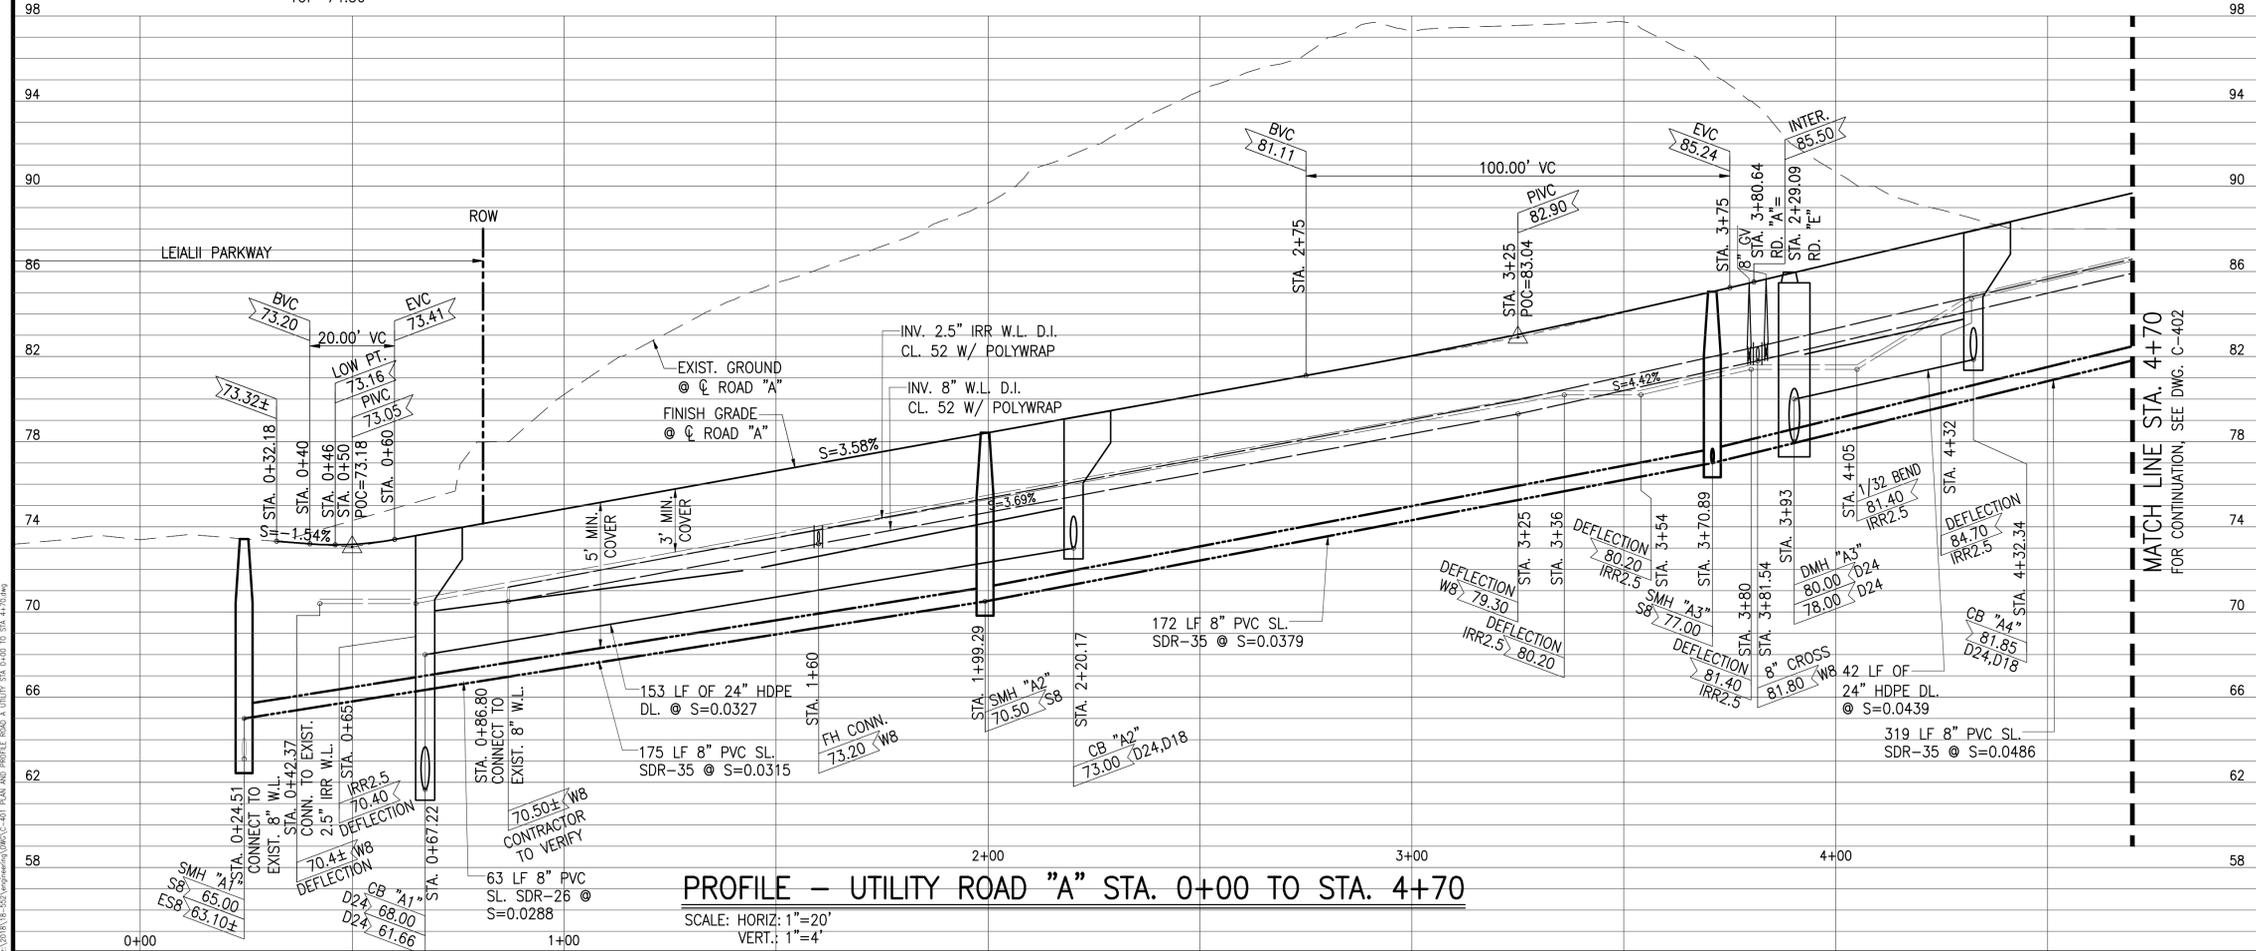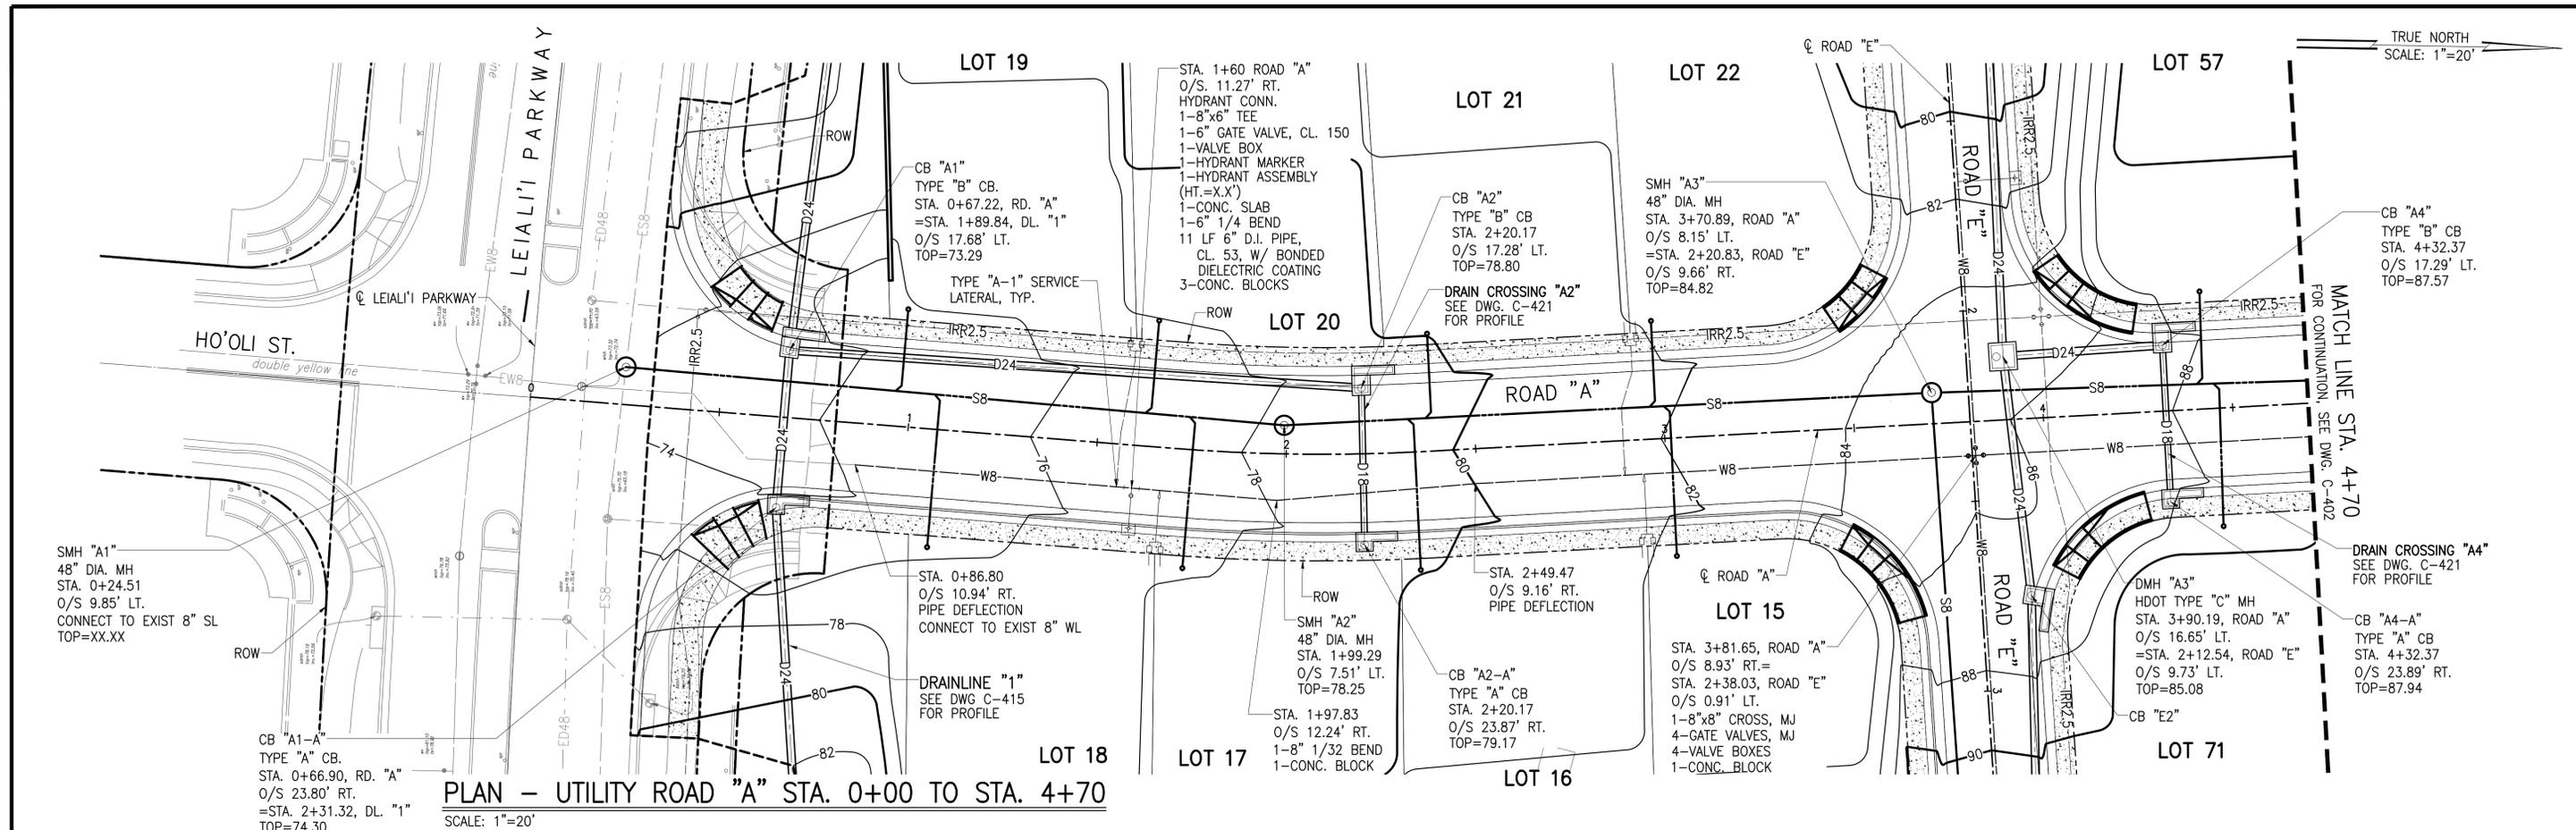

THIS WORK WAS PREPARED BY ME OR UNDER MY SUPERVISION AND CONSTRUCTION OF THIS PROJECT WILL BE UNDER MY OBSERVATION AS DEFINED IN SECTION 16-115-2, HAWAII ADMINISTRATIVE RULES, DEPARTMENT OF COMMERCE AND CONSUMER AFFAIRS, STATE OF HAWAII. PROFESSIONAL ENGINEER, ARCHITECT, SURVEYORS AND LANDSCAPE ARCHITECTS.


LICENSE EXPIRES: APRIL 30, 2024

LINE IS 2 INCHES AT FULL SIZE
(IF NOT 2-INCHES: SCALE ACCORDINGLY)

DWG. NO. **C-401**


SHEET 23 OF

| REVISION | DATE | BRIEF | MADE BY | APPROVED |
|---------------------------------------------------------------------------------------------------------------------------------------------------------------------------------------------------------|------|--------------|---------|------------|
| ATA AUSTIN, TSUTSUMI & ASSOCIATES, INC. ENGINEERS, SURVEYORS • HONOLULU, WAILUKU, HAWAII | | | | |
| DEPARTMENT OF HAWAIIAN HOME LANDS VILLAGES OF LEIALI'I, PHASE 1B TAX MAP KEY: (2) 4-5-21: 020 LAHAINA, MAUI, HAWAII PLAN AND PROFILE ROAD "A" UTILITY STA 0+00 TO STA 4+70 | | | | |
| DESIGNED BY | KM | DRAWN BY | ATA | CHECKED BY |
| APPROVED BY | | SUBMITTED BY | AW | |
| DATE | | FIRM NUMBER | | DATE |

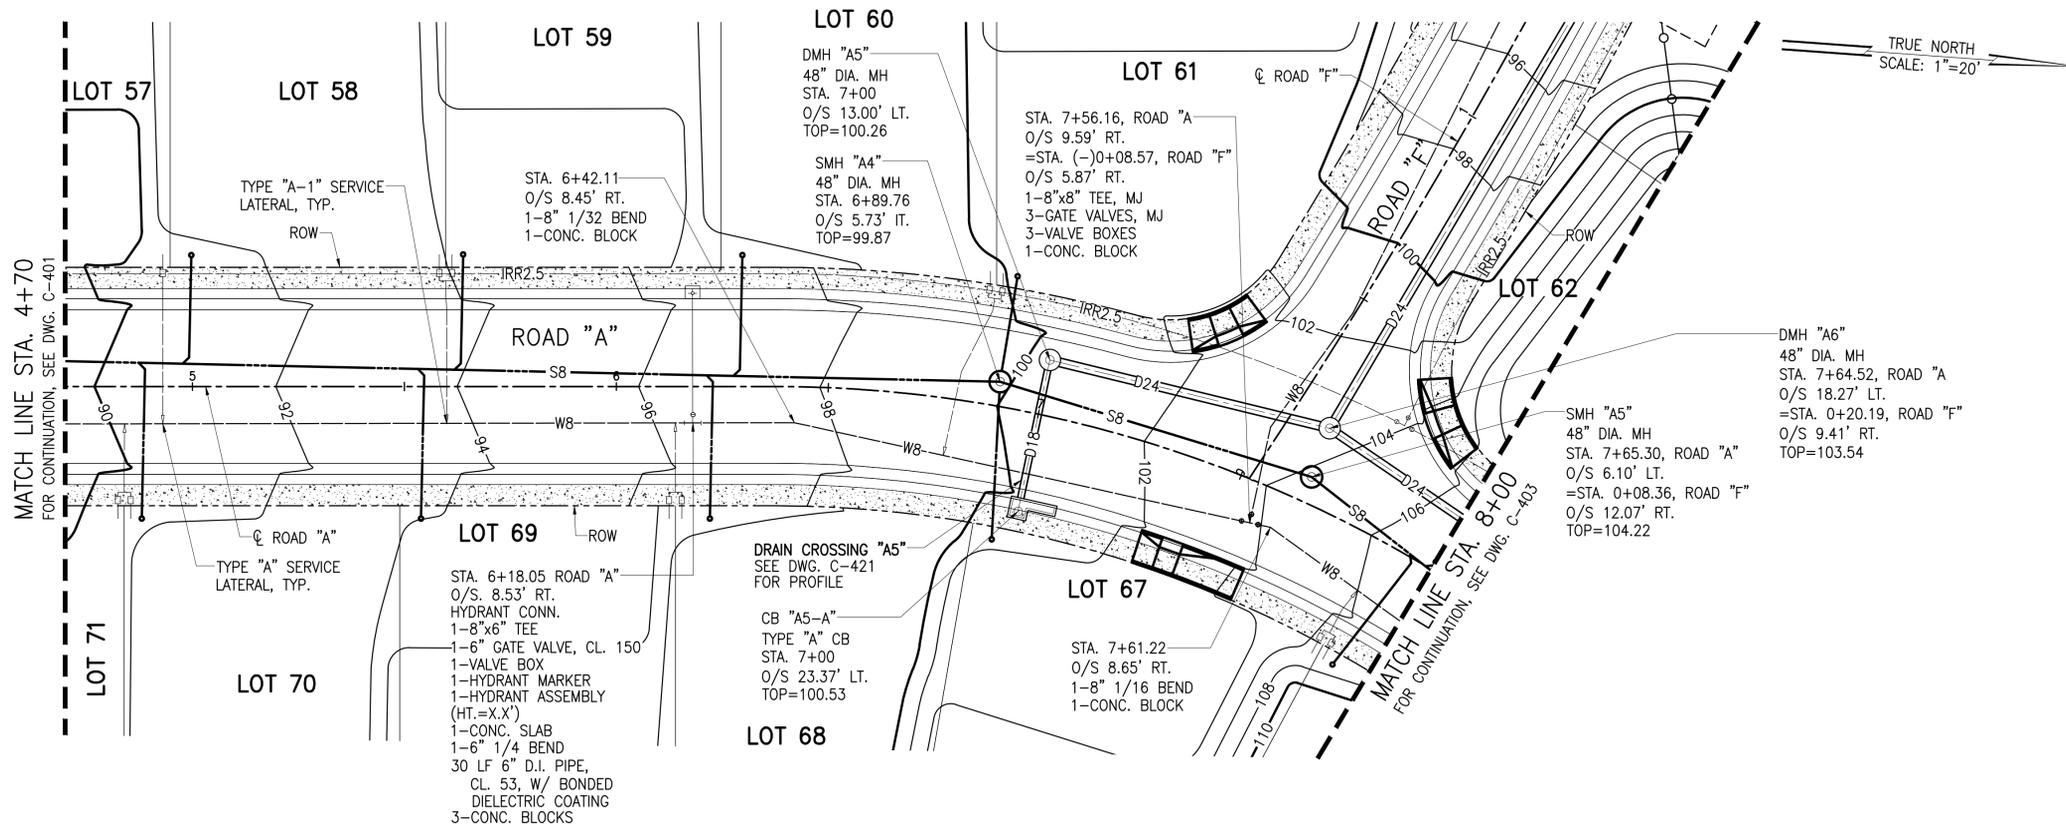

PLAN - UTILITY ROAD "A" STA. 4+70 TO STA. 8+00

SCALE: 1"=20'

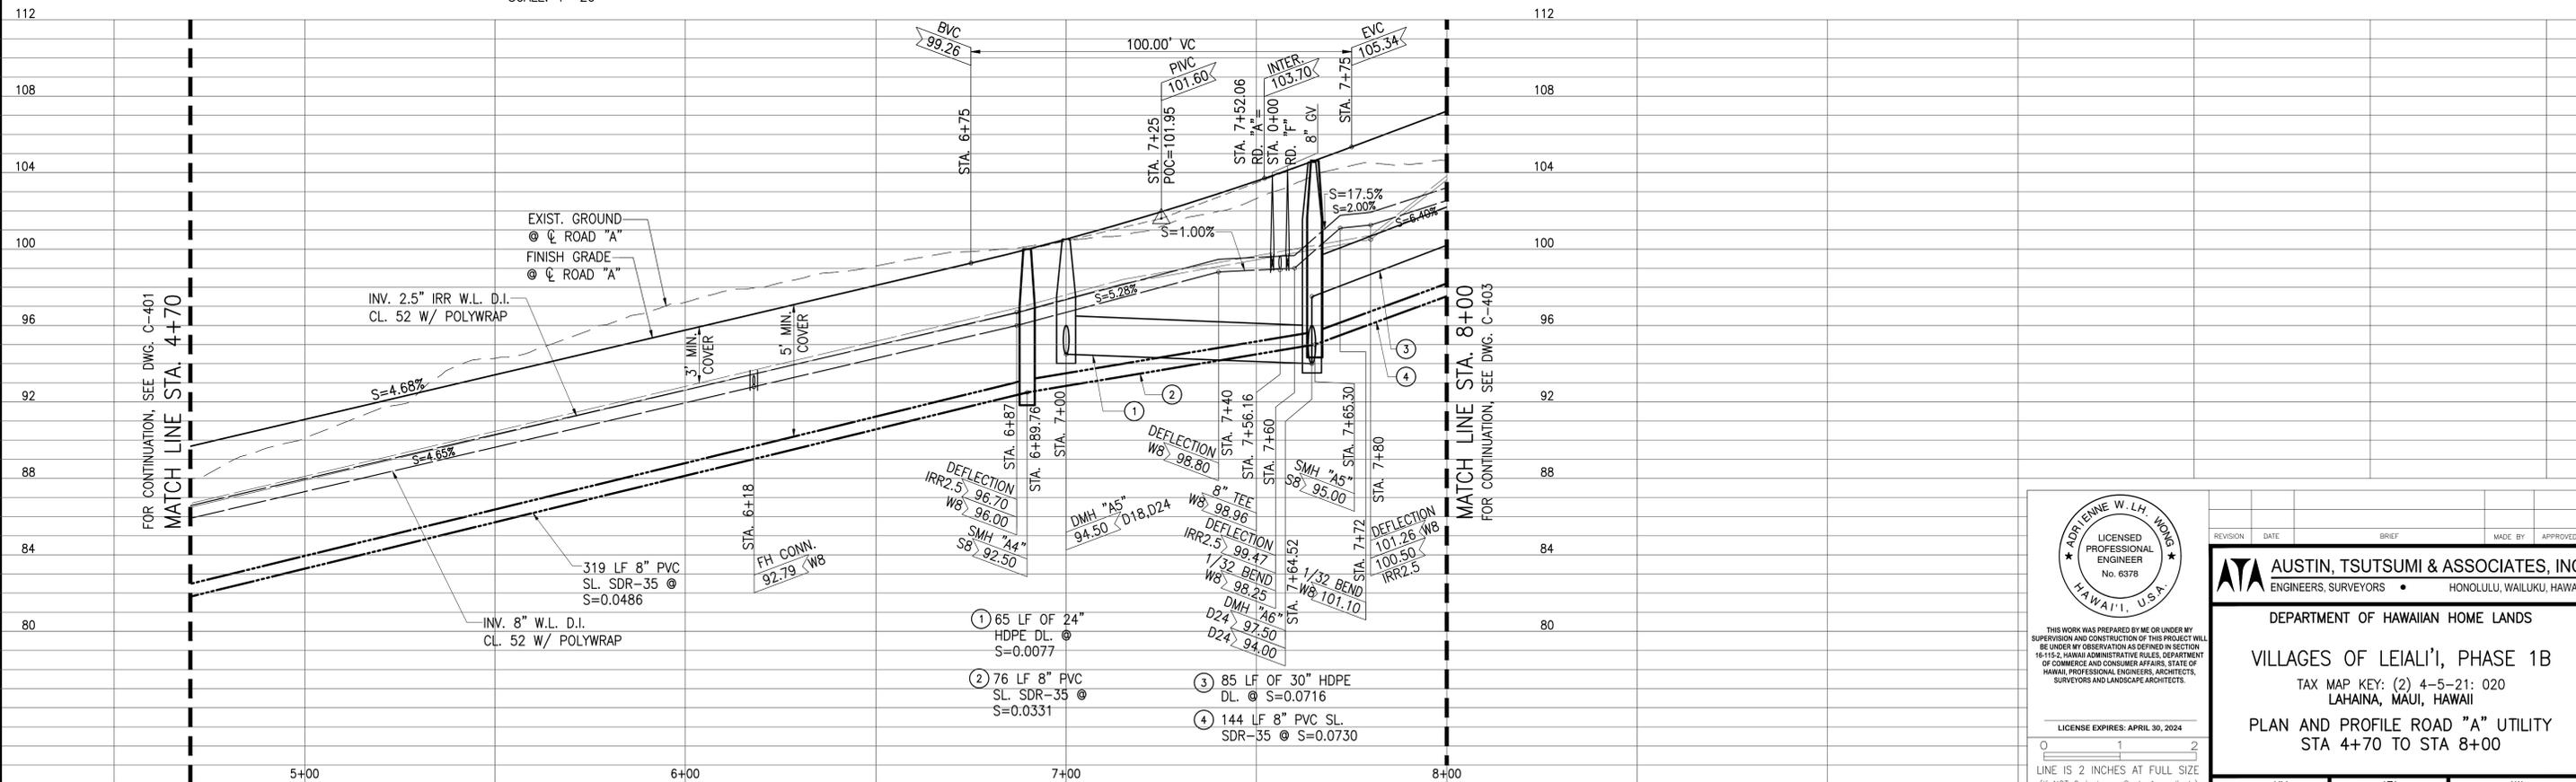

PROFILE - UTILITY ROAD "A" STA. 4+70 TO STA. 8+00

SCALE: HORIZ.: 1"=20'
VERT.: 1"=4'



THIS WORK WAS PREPARED BY ME OR UNDER MY SUPERVISION AND CONSTRUCTION OF THIS PROJECT WILL BE UNDER MY OBSERVATION AS DEFINED IN SECTION 16-115-2, HAWAII ADMINISTRATIVE RULES, DEPARTMENT OF COMMERCE AND CONSUMER AFFAIRS, STATE OF HAWAII, PROFESSIONAL ENGINEERS, ARCHITECTS, SURVEYORS AND LANDSCAPE ARCHITECTS.

LICENSE EXPIRES: APRIL 30, 2024


0 1 2
LINE IS 2 INCHES AT FULL SIZE
(IF NOT 2-INCHES: SCALE ACCORDINGLY)

DWG. NO. **C-402**

SHEET 24 OF


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|---------------------------------------------------------------------------------------------------------------------------------------------------------------------------------------------------------|----------------------|-----------------------|--------------------|----------|
| REVISION | DATE | BRIEF | MADE BY | APPROVED |
| ATA AUSTIN, TSUTSUMI & ASSOCIATES, INC. ENGINEERS, SURVEYORS • HONOLULU, WAILUKU, HAWAII | | | | |
| DEPARTMENT OF HAWAIIAN HOME LANDS VILLAGES OF LEIALI'I, PHASE 1B TAX MAP KEY: (2) 4-5-21: 020 LAHAINA, MAUI, HAWAII PLAN AND PROFILE ROAD "A" UTILITY STA 4+70 TO STA 8+00 | | | | |
| DESIGNED BY: KM | DRAWN BY: ATA | CHECKED BY: AW | APPROVED BY: _____ | |
| DATE: _____ | | FIRM NUMBER: _____ | | |

A:\2023\18-522\18-522.dwg (C-402) DATE: 09/01/2023 10:52:10 AM

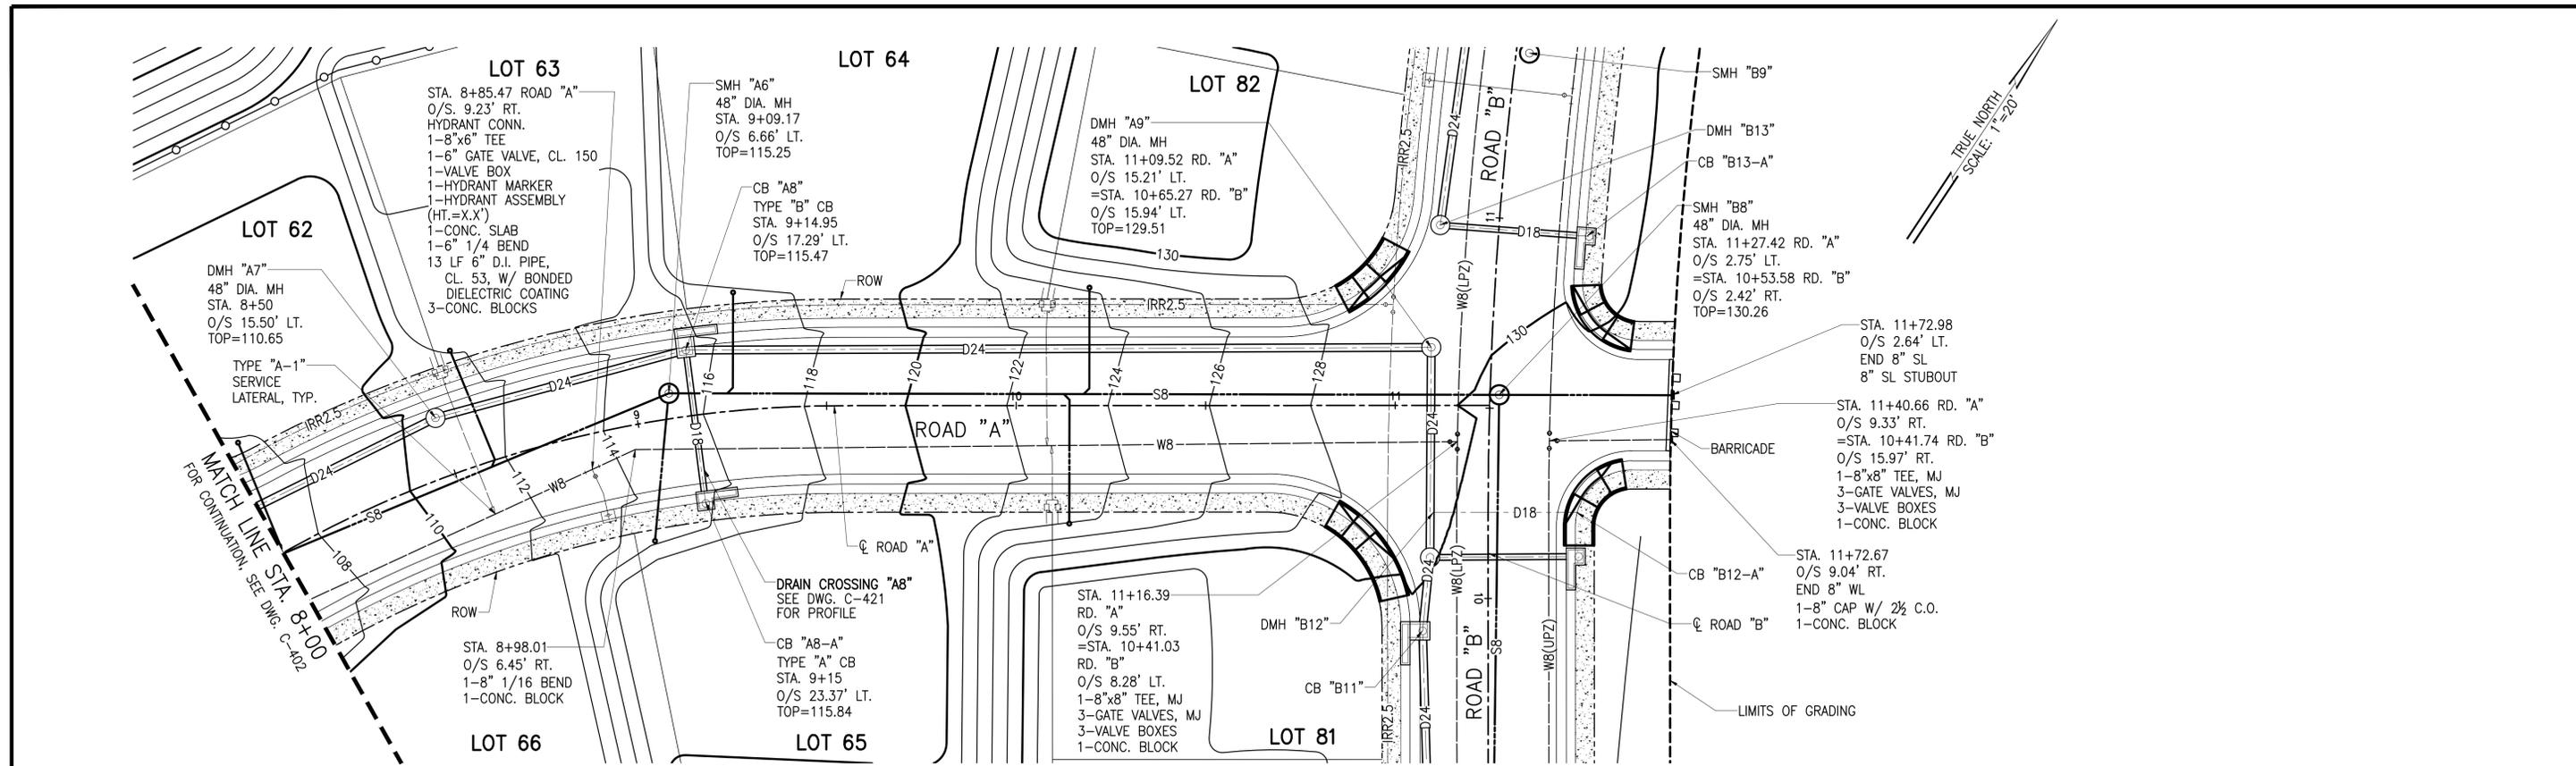

PLAN - UTILITY ROAD "A" STA. 8+00 TO END

SCALE: 1"=20'

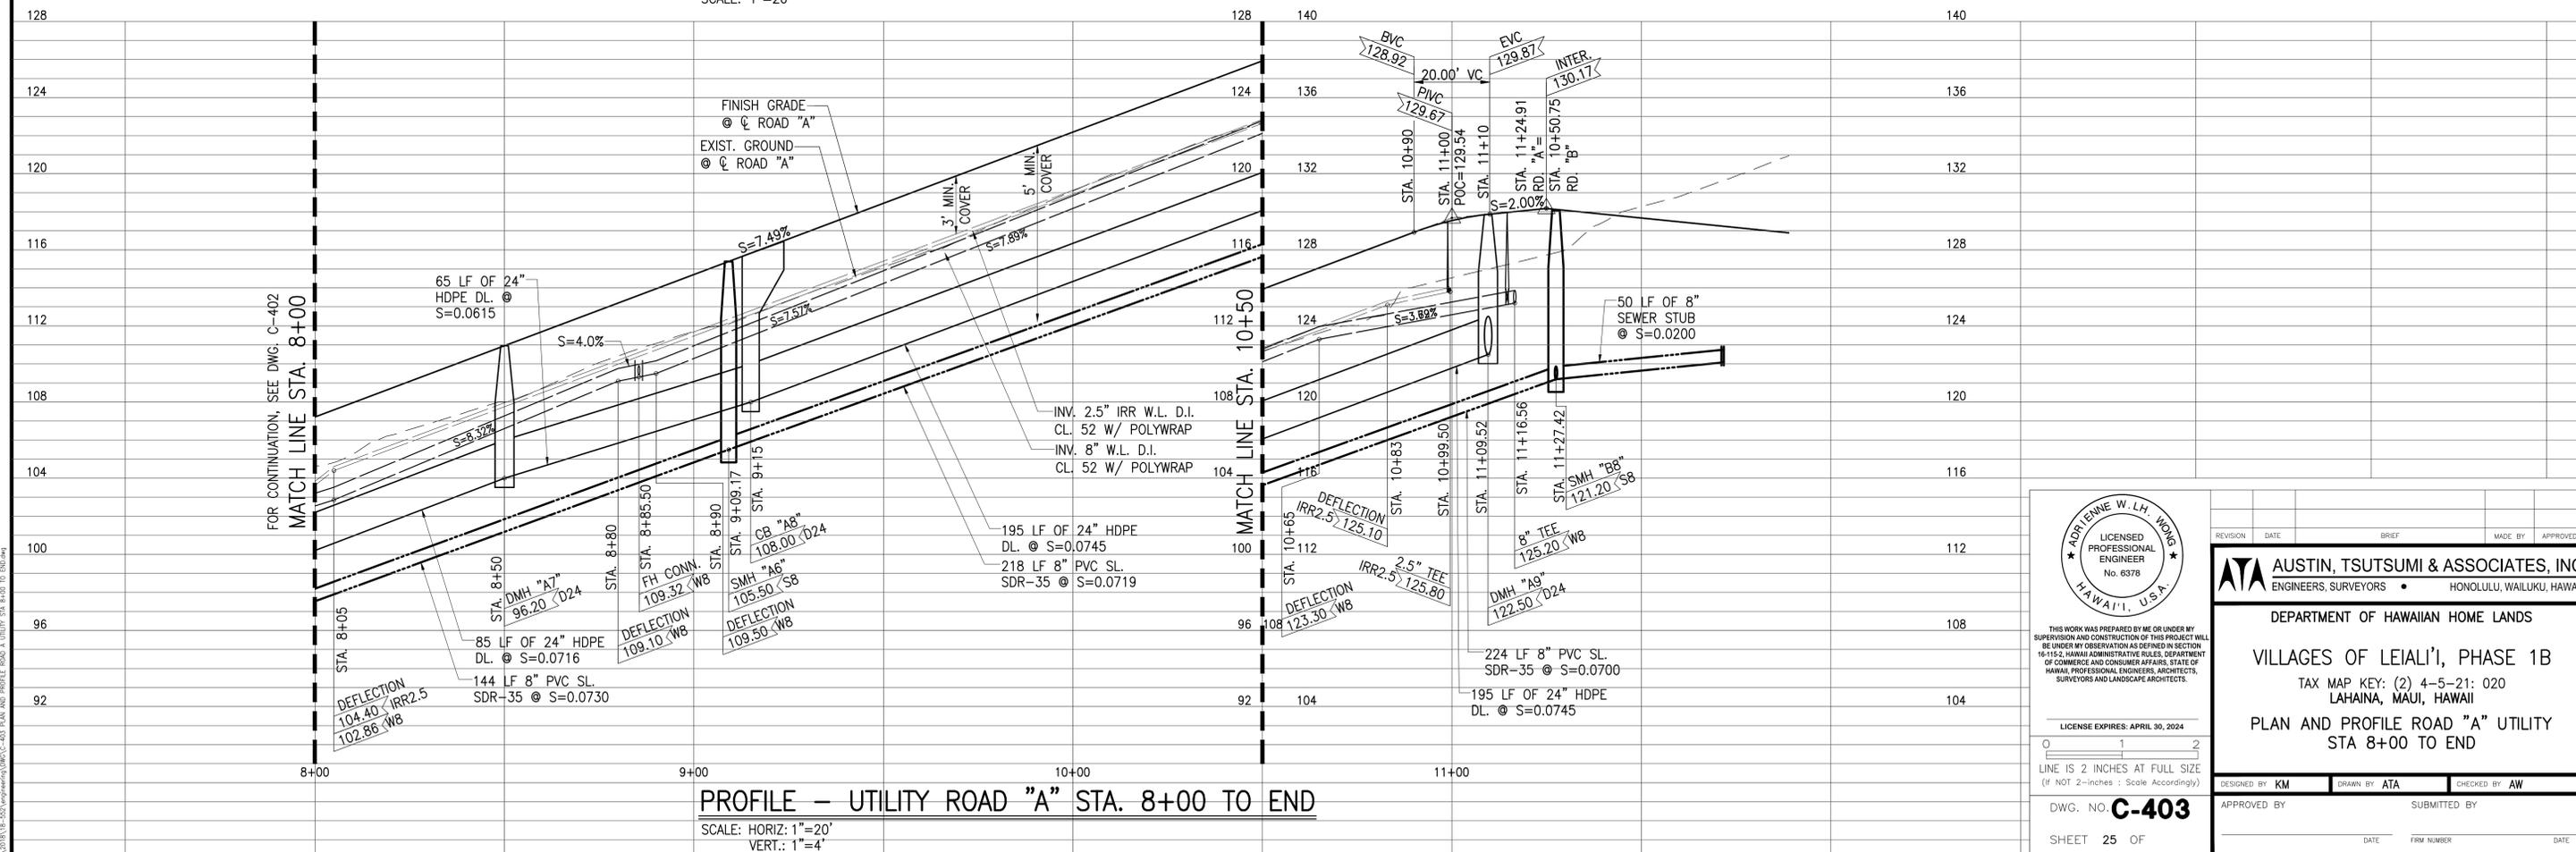

PROFILE - UTILITY ROAD "A" STA. 8+00 TO END

SCALE: HORIZ: 1"=20'
VERT.: 1"=4'



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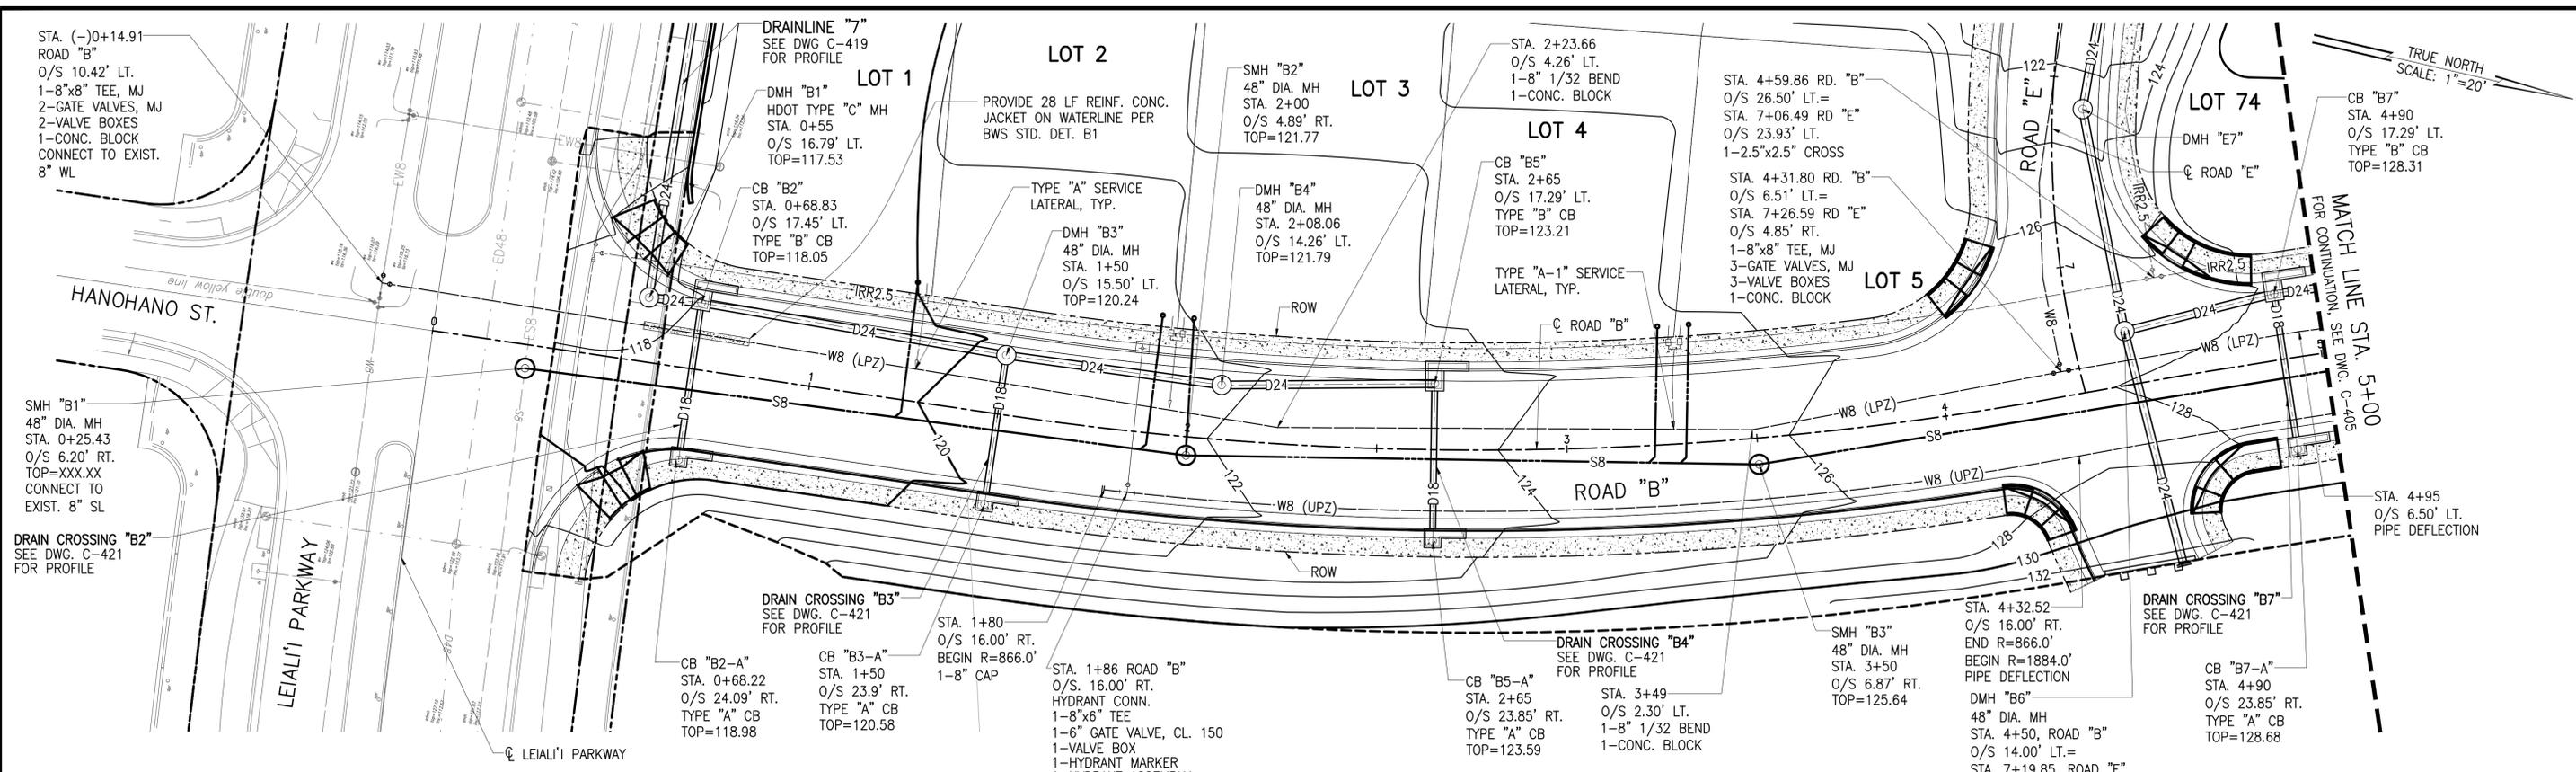
LICENSE EXPIRES: APRIL 30, 2024

0 1 2
LINE IS 2 INCHES AT FULL SIZE
(IF NOT 2-INCHES: SCALE ACCORDINGLY)


DWG. NO. **C-403**

SHEET 25 OF


| REVISION | DATE | BRIEF | MADE BY | APPROVED | |
|--------------------------------------------------------------------------------------------------------------------------------------------------------------------------------------------------------------------------------------------------------------------------------------------------------------------------|------|--------------|---------|------------|----|
| <p>ATA AUSTIN, TSUTSUMI & ASSOCIATES, INC. ENGINEERS, SURVEYORS • HONOLULU, WAILUKU, HAWAII</p> <p>DEPARTMENT OF HAWAIIAN HOME LANDS</p> <p>VILLAGES OF LEIALI'I, PHASE 1B</p> <p>TAX MAP KEY: (2) 4-5-21: 020 LAHAINA, MAUI, HAWAII</p> <p>PLAN AND PROFILE ROAD "A" UTILITY STA 8+00 TO END</p> | | | | | |
| DESIGNED BY | KM | DRAWN BY | ATA | CHECKED BY | AW |
| APPROVED BY | | SUBMITTED BY | | | |
| DATE | | FIRM NUMBER | | DATE | |




PLAN - UTILITY ROAD "B" STA. 0+00 TO STA. 5+00
SCALE: 1"=20'

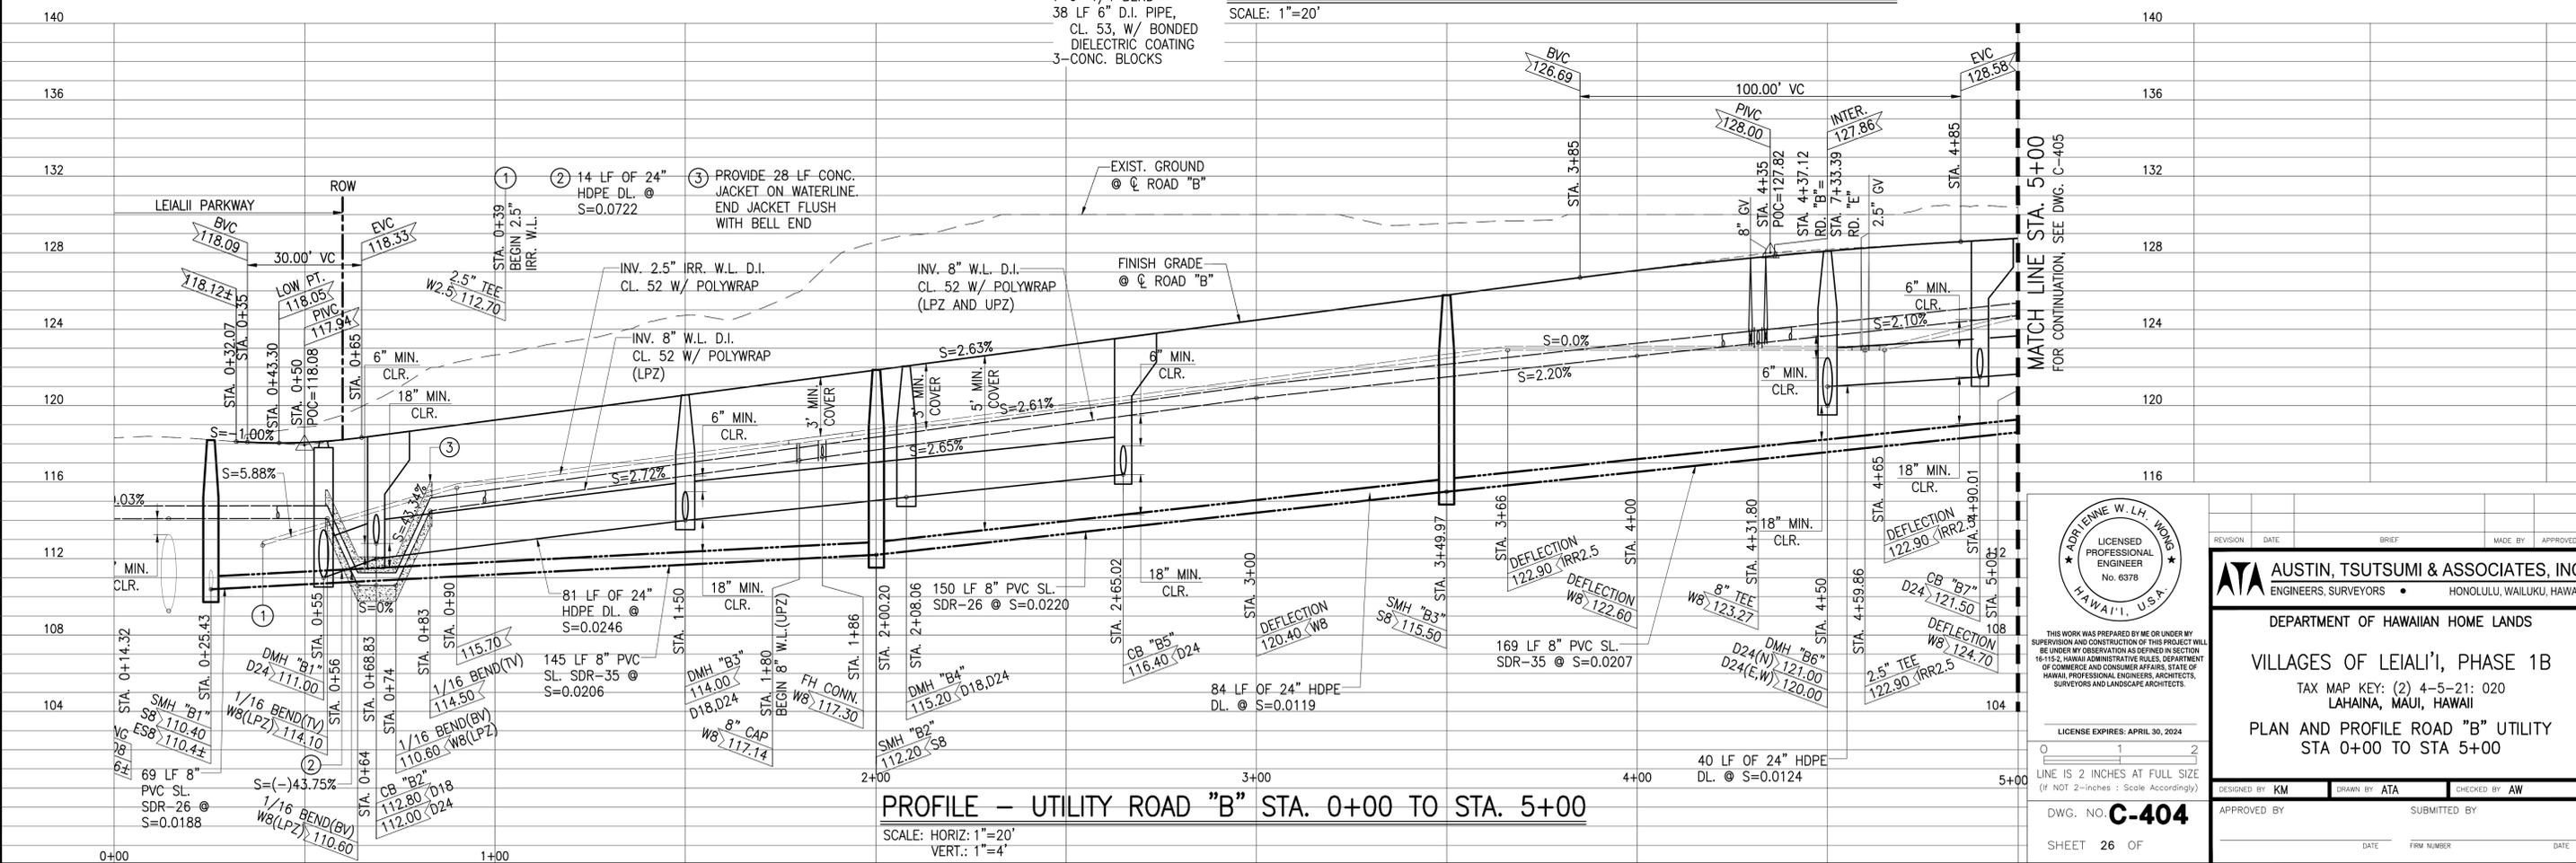

PROFILE - UTILITY ROAD "B" STA. 0+00 TO STA. 5+00
SCALE: HORIZ: 1"=20'
VERT.: 1"=4'

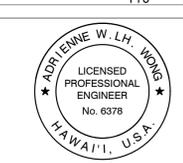


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|---------------------------------------------------------------------------------------------------------------------------------------------------------------------------------------------------------|------|--------------|---------|------------|
| REVISION | DATE | BRIEF | MADE BY | APPROVED |
| ATA AUSTIN, TSUTSUMI & ASSOCIATES, INC. ENGINEERS, SURVEYORS • HONOLULU, WAILUKU, HAWAII | | | | |
| DEPARTMENT OF HAWAIIAN HOME LANDS VILLAGES OF LEIALI'I, PHASE 1B TAX MAP KEY: (2) 4-5-21: 020 LAHAINA, MAUI, HAWAII PLAN AND PROFILE ROAD "B" UTILITY STA 0+00 TO STA 5+00 | | | | |
| DESIGNED BY | KM | DRAWN BY | ATA | CHECKED BY |
| APPROVED BY | | SUBMITTED BY | AW | |
| LICENSE EXPIRES: APRIL 30, 2024 DWG. NO. C-404 SHEET 26 OF | | | | |
| DATE | | FIRM NUMBER | | DATE |

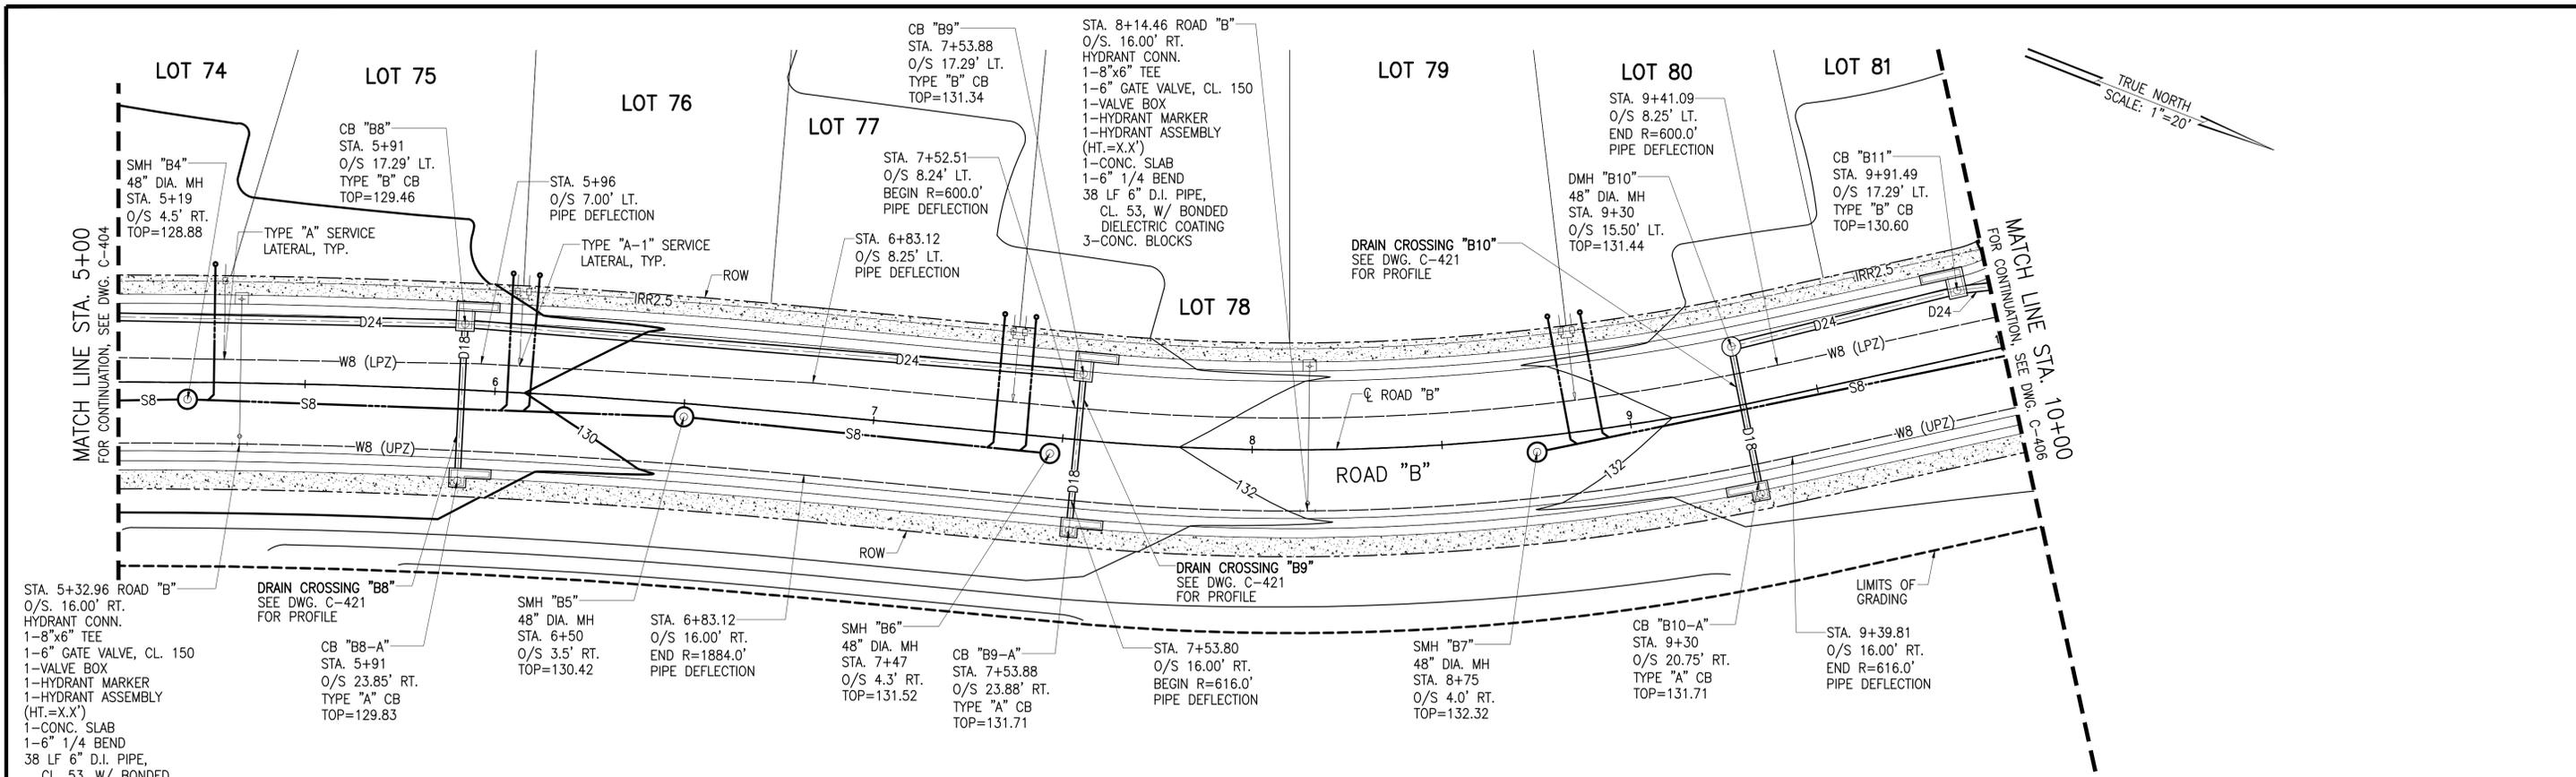


PLAN - UTILITY ROAD "B" STA. 5+00 TO STA. 10+00

SCALE: 1"=20'

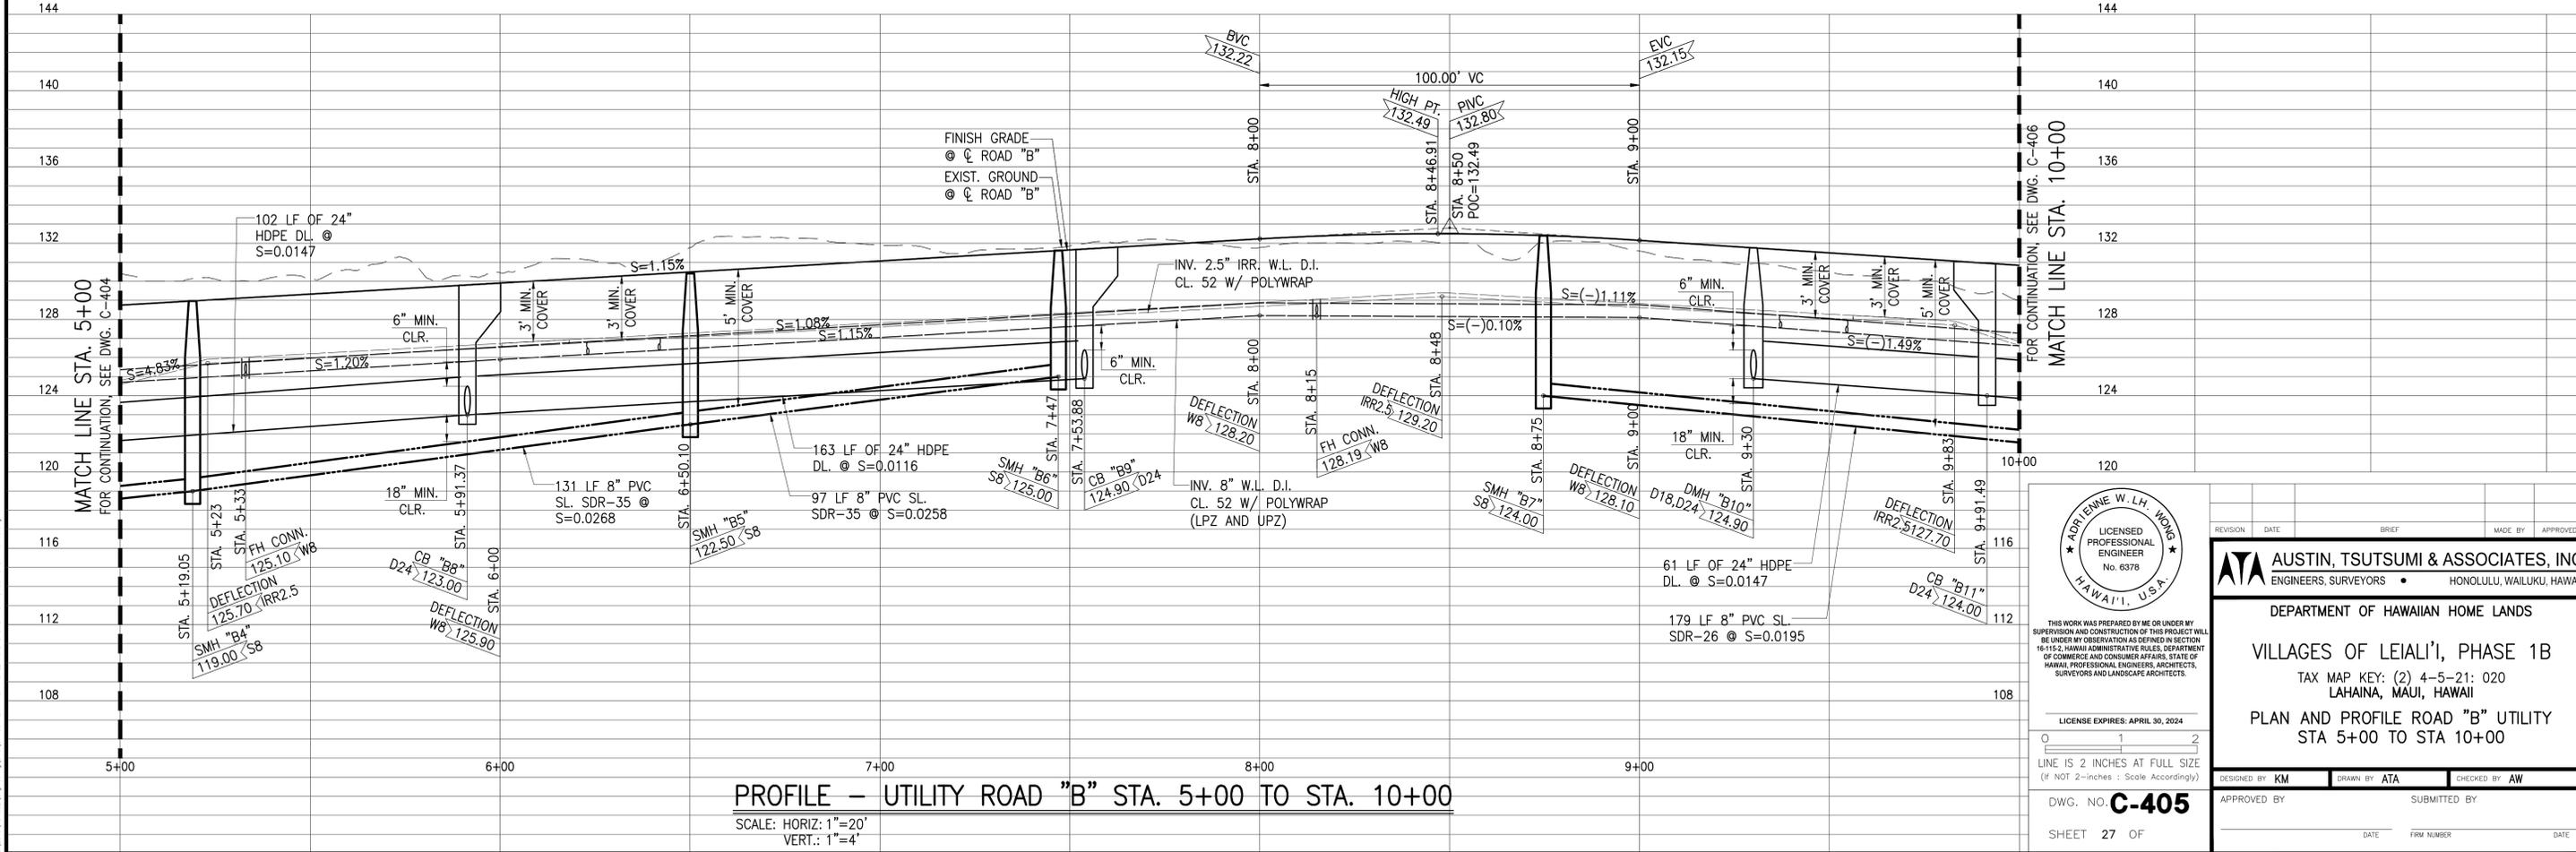


PROFILE - UTILITY ROAD "B" STA. 5+00 TO STA. 10+00


SCALE: HORIZ: 1"=20'
VERT.: 1"=4'

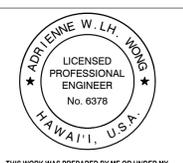


| | | | | |
|--------------------------------------------------------------------------------------------------------------------------------------------------------------------------------------------------------------------|------|--------------|---------|------------|
| REVISION | DATE | BRIEF | MADE BY | APPROVED |
| ATA AUSTIN, TSUTSUMI & ASSOCIATES, INC. ENGINEERS, SURVEYORS • HONOLULU, WAILUKU, HAWAII | | | | |
| DEPARTMENT OF HAWAIIAN HOME LANDS VILLAGES OF LEIALI'I, PHASE 1B TAX MAP KEY: (2) 4-5-21: 020 LAHAINA, MAUI, HAWAII PLAN AND PROFILE ROAD "B" UTILITY STA 5+00 TO STA 10+00 | | | | |
| DESIGNED BY | KM | DRAWN BY | ATA | CHECKED BY |
| APPROVED BY | | SUBMITTED BY | AW | |
| LICENSE EXPIRES: APRIL 30, 2024 DWG. NO. C-405 SHEET 27 OF | | | | |

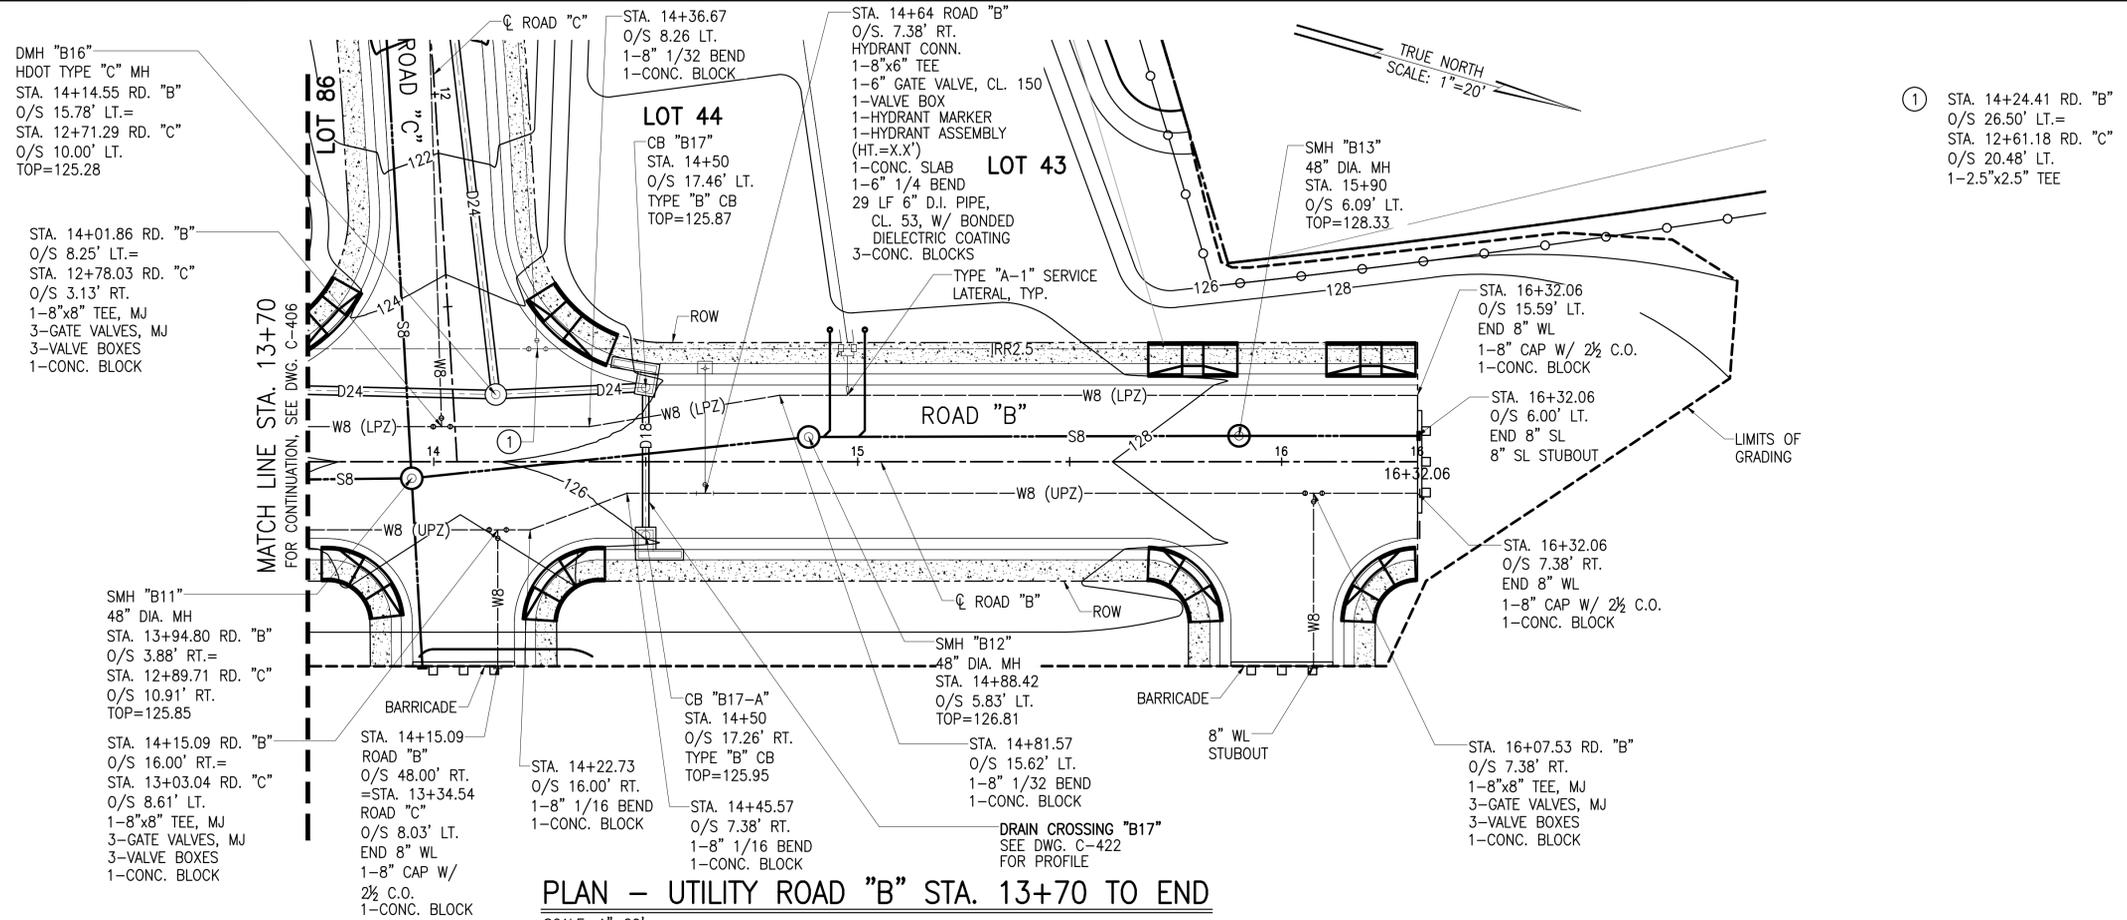

PLAN - UTILITY ROAD "B" STA. 13+70 TO END
SCALE: 1"=20'

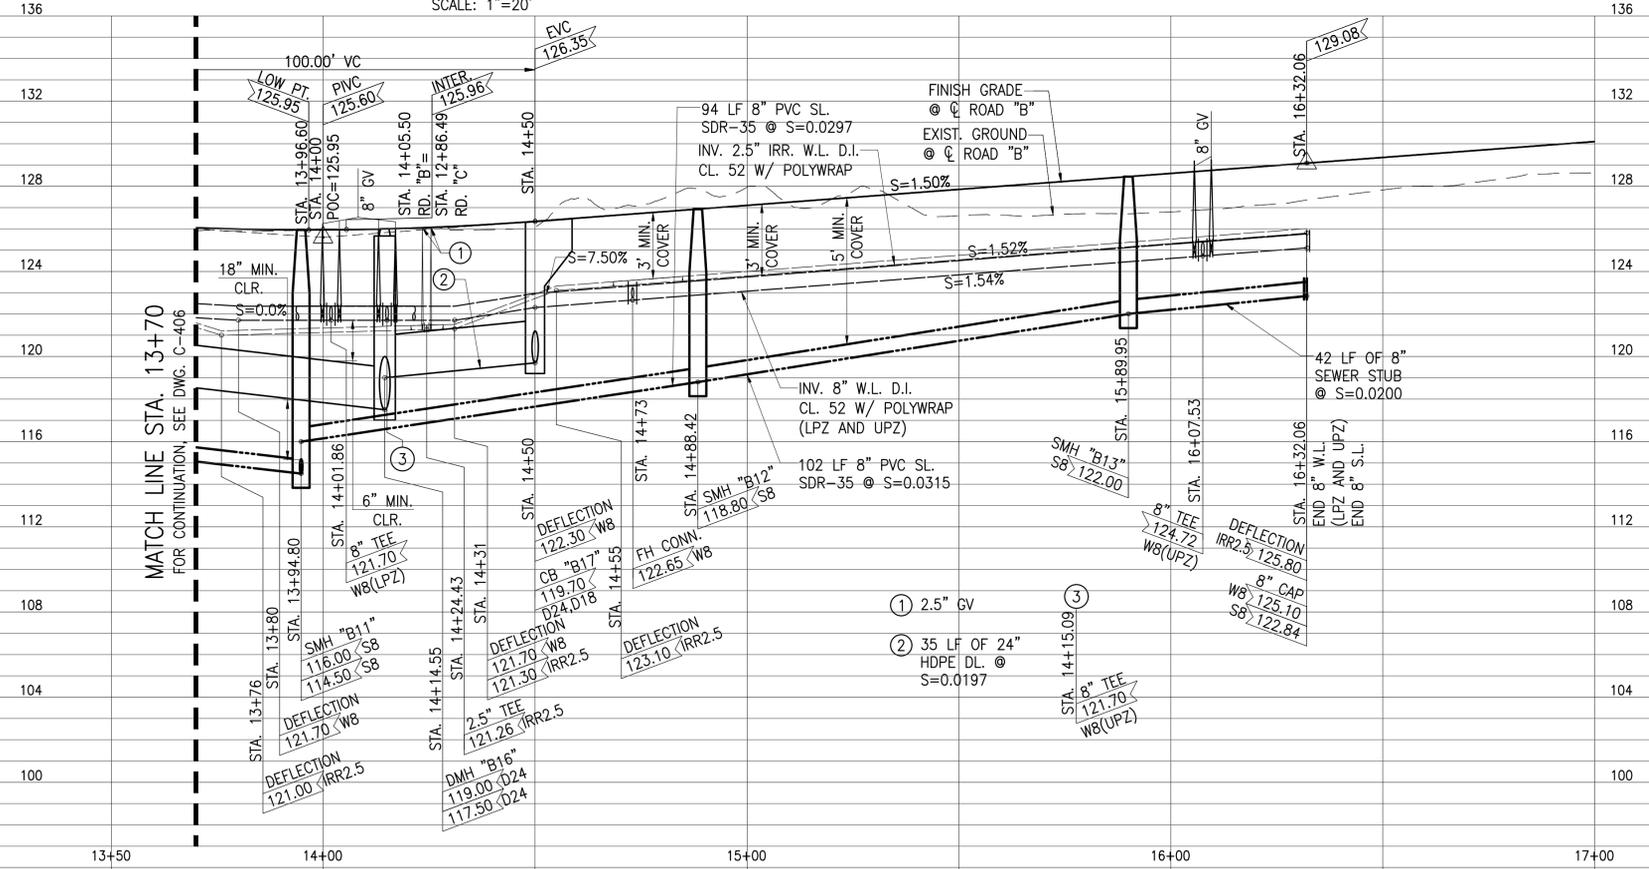

PROFILE - UTILITY ROAD "B" STA. 13+70 TO END
SCALE: HORIZ: 1"=20'
VERT.: 1"=4'

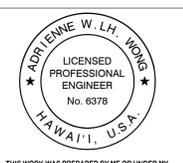

THIS WORK WAS PREPARED BY ME OR UNDER MY SUPERVISION AND CONSTRUCTION OF THIS PROJECT WILL BE UNDER MY OBSERVATION AS DEFINED IN SECTION 16-115-2, HAWAII ADMINISTRATIVE RULES, DEPARTMENT OF COMMERCE AND CONSUMER AFFAIRS, STATE OF HAWAII. PROFESSIONAL ENGINEER, ARCHITECTS, SURVEYORS AND LANDSCAPE ARCHITECTS.

LICENSE EXPIRES: APRIL 30, 2024

0 1 2
LINE IS 2 INCHES AT FULL SIZE
(IF NOT 2-INCHES : SCALE ACCORDINGLY)

DWG. NO. **C-407**
SHEET 29 OF

| REVISION | DATE | BRIEF | MADE BY | APPROVED |
|----------|------|-------|---------|----------|
| | | | | |

ATA AUSTIN, TSUTSUMI & ASSOCIATES, INC.
ENGINEERS, SURVEYORS • HONOLULU, WAILUKU, HAWAII

DEPARTMENT OF HAWAIIAN HOME LANDS

VILLAGES OF LEIALI'I, PHASE 1B
TAX MAP KEY: (2) 4-5-21: 020
LAHAINA, MAUI, HAWAII


PLAN AND PROFILE ROAD "B" UTILITY
STA 13+70 TO END

DESIGNED BY: **KM** DRAWN BY: **ATA** CHECKED BY: **AW**


APPROVED BY: _____ SUBMITTED BY: _____

DATE: _____ FIRM NUMBER: _____ DATE: _____


13+70(14+30)PVC(14+00)POC(125.95)8"GV(14+05.50)RD."B"=STA.12+86.49RD."C"14+15.09STA.14+15.09ROAD "B"0/S 48.00' RT.=STA.13+34.54ROAD "C"0/S 8.03' LT. END 8" WL 1-8" CAP W/ 2 1/2 C.O. 1-CONC. BLOCK

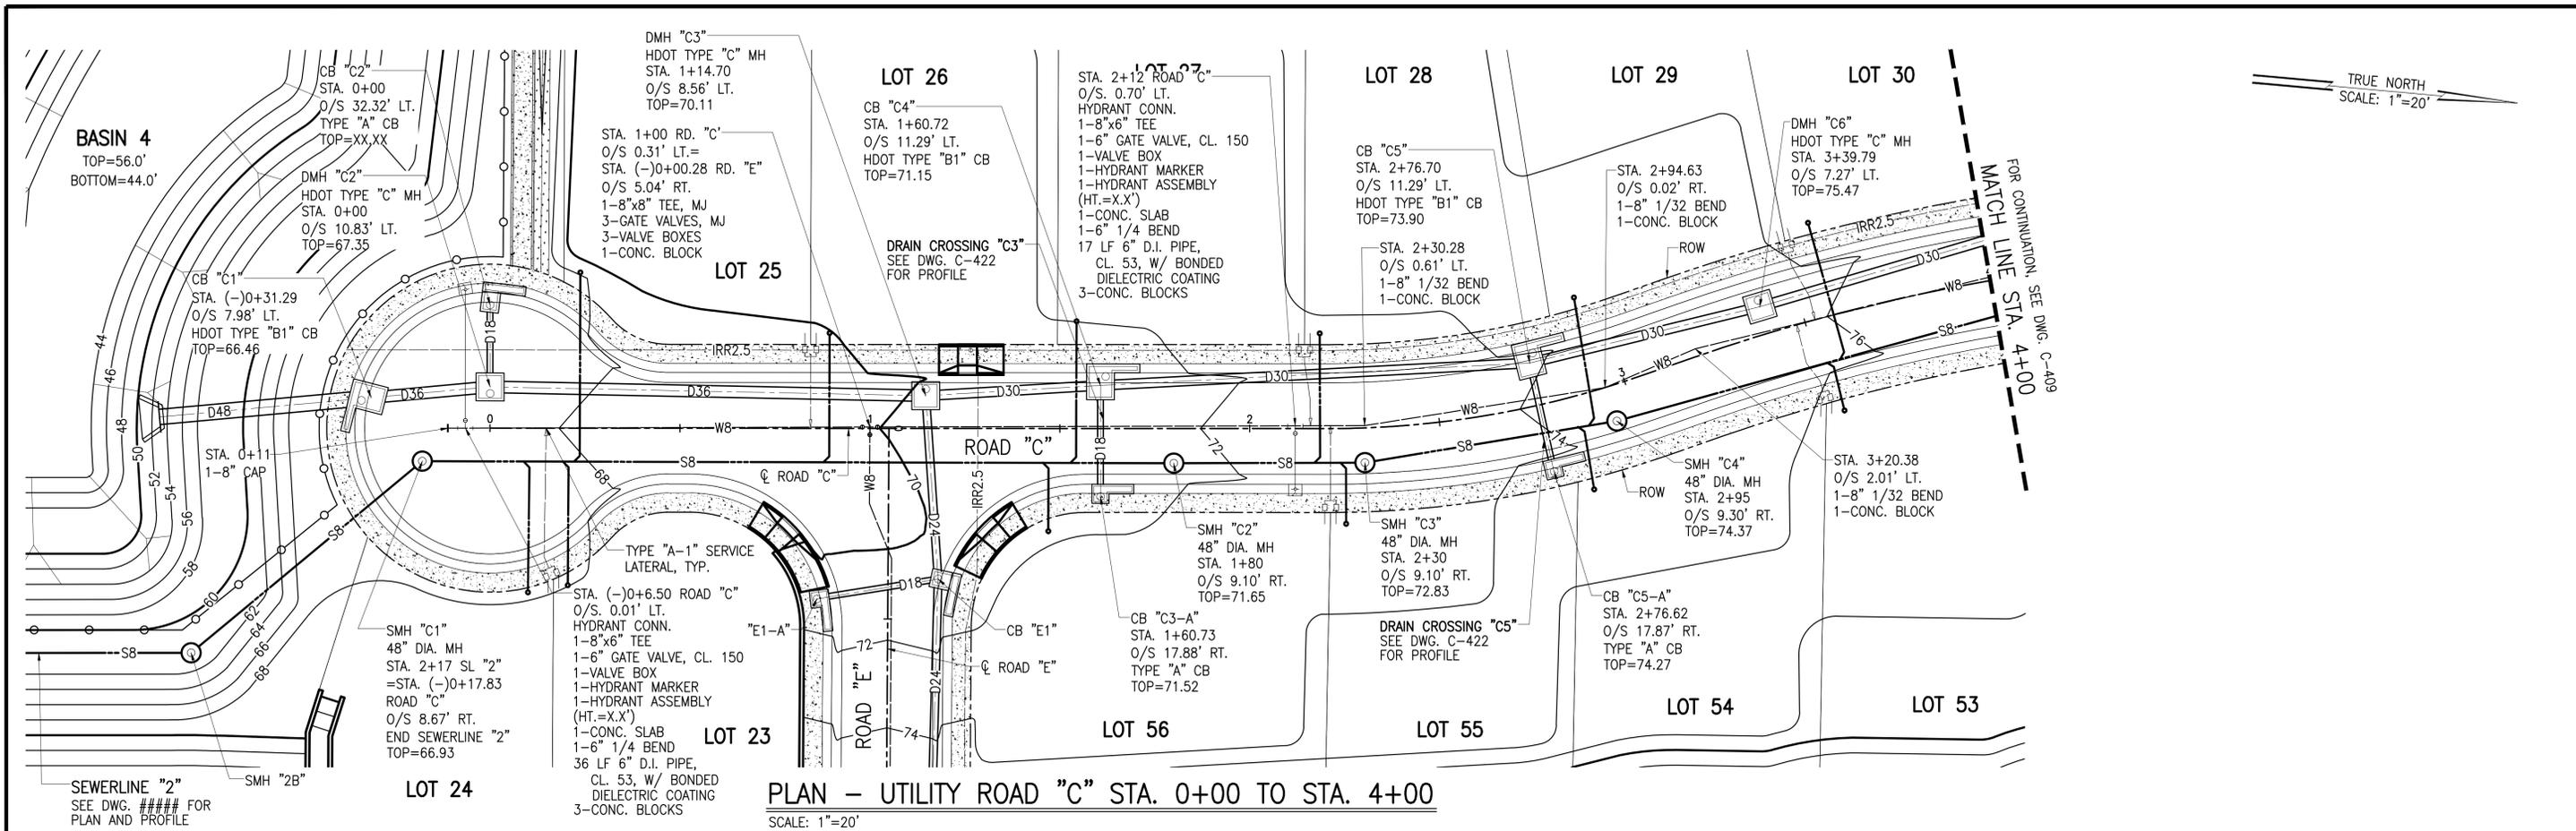

PLAN - UTILITY ROAD "C" STA. 0+00 TO STA. 4+00
SCALE: 1"=20'

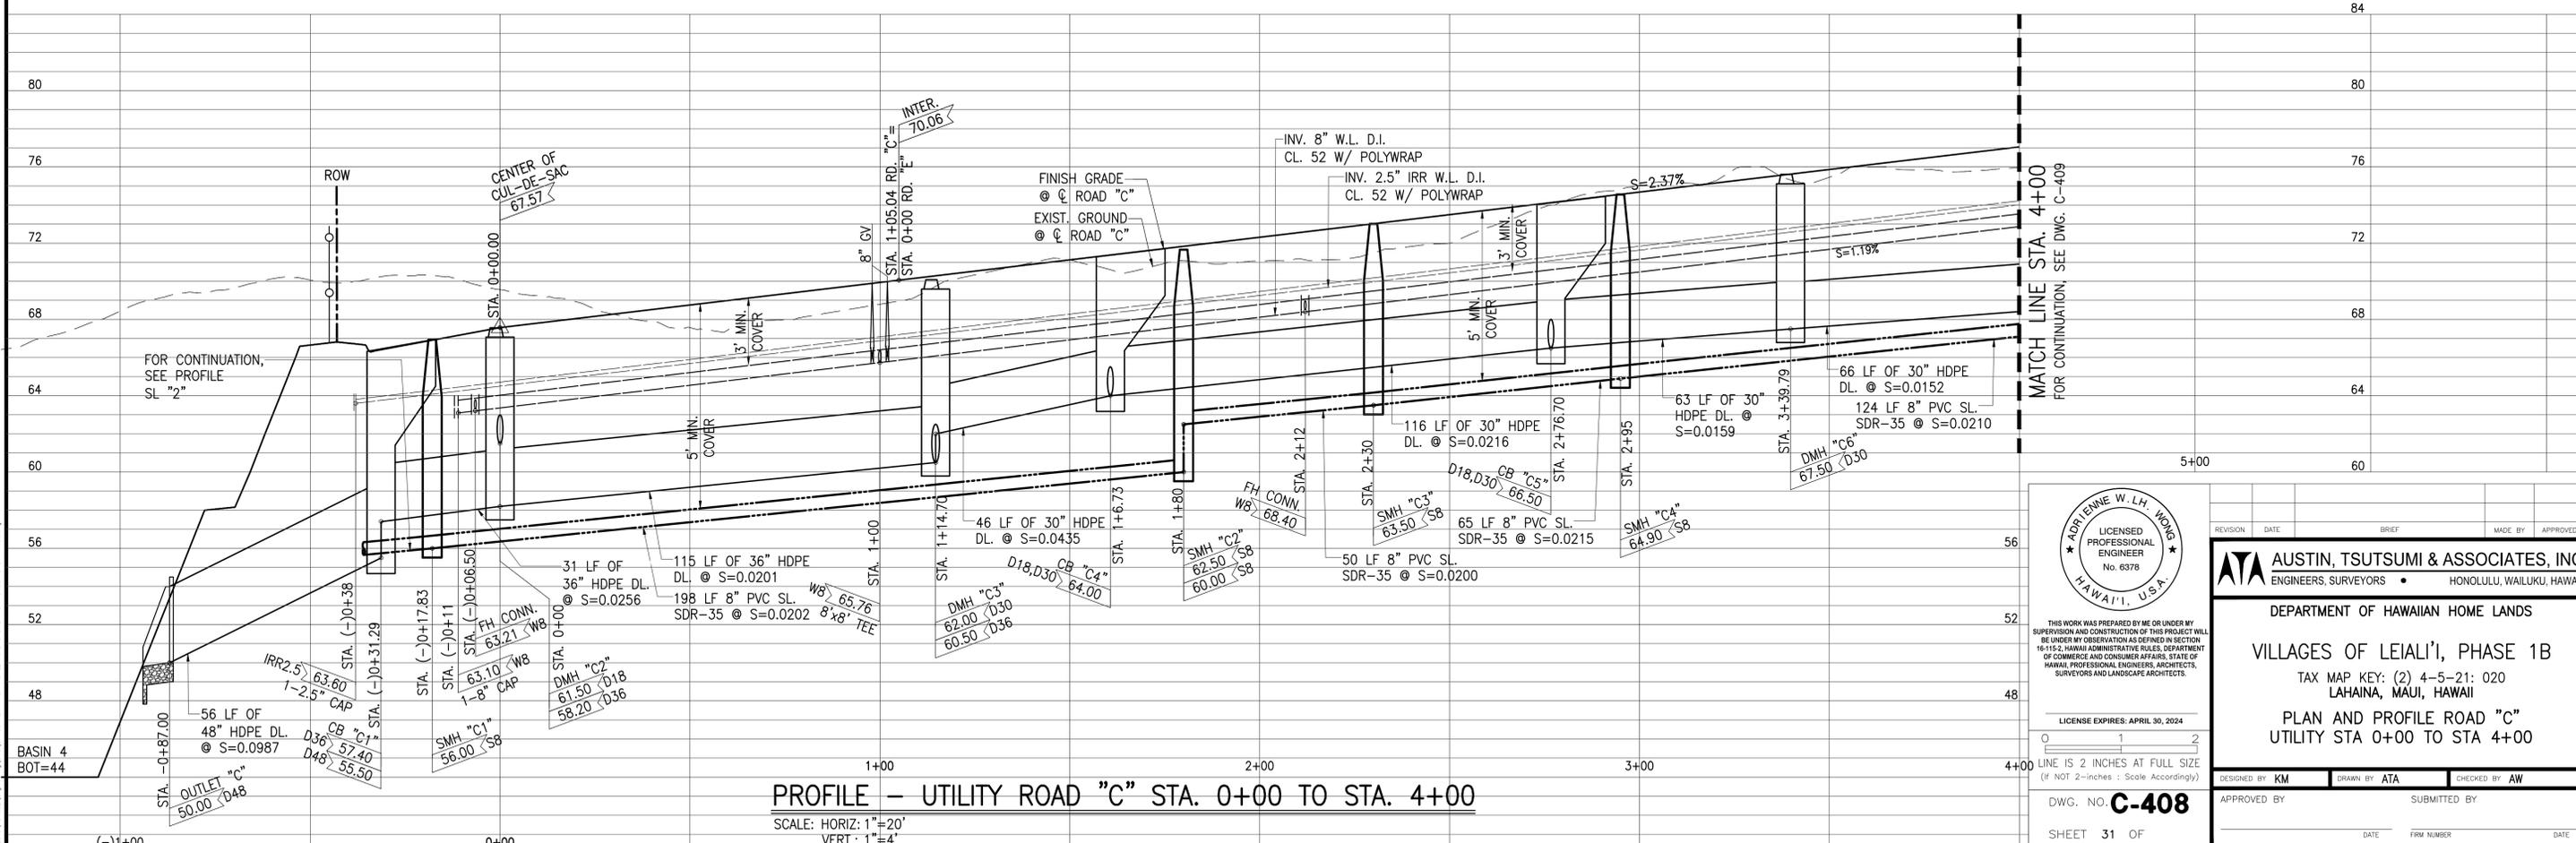

PROFILE - UTILITY ROAD "C" STA. 0+00 TO STA. 4+00
SCALE: HORIZ: 1"=20'
VERT.: 1"=4'

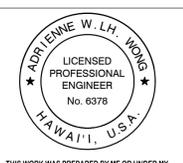

THIS WORK WAS PREPARED BY ME OR UNDER MY SUPERVISION AND CONSTRUCTION OF THIS PROJECT WILL BE UNDER MY OBSERVATION AS DEFINED IN SECTION 16-115-2, HAWAII ADMINISTRATIVE RULES, DEPARTMENT OF COMMERCE AND CONSUMER AFFAIRS, STATE OF HAWAII. PROFESSIONAL ENGINEER, ARCHITECTS, SURVEYORS AND LANDSCAPE ARCHITECTS.

LICENSE EXPIRES: APRIL 30, 2024

LINE IS 2 INCHES AT FULL SIZE
(IF NOT 2-INCHES : SCALE ACCORDINGLY)

DWG. NO. **C-408**

SHEET 31 OF

| REVISION | DATE | BRIEF | MADE BY | APPROVED |
|----------|------|-------|---------|----------|
| | | | | |

ATA AUSTIN, TSUTSUMI & ASSOCIATES, INC.
ENGINEERS, SURVEYORS • HONOLULU, WAILUKU, HAWAII

DEPARTMENT OF HAWAIIAN HOME LANDS

VILLAGES OF LEIALI'I, PHASE 1B


TAX MAP KEY: (2) 4-5-21: 020
LAHAINA, MAUI, HAWAII

PLAN AND PROFILE ROAD "C"
UTILITY STA 0+00 TO STA 4+00

DESIGNED BY: **KM** DRAWN BY: **ATA** CHECKED BY: **AW**

APPROVED BY: _____ SUBMITTED BY: _____


DATE: _____ FIRM NUMBER: _____ DATE: _____

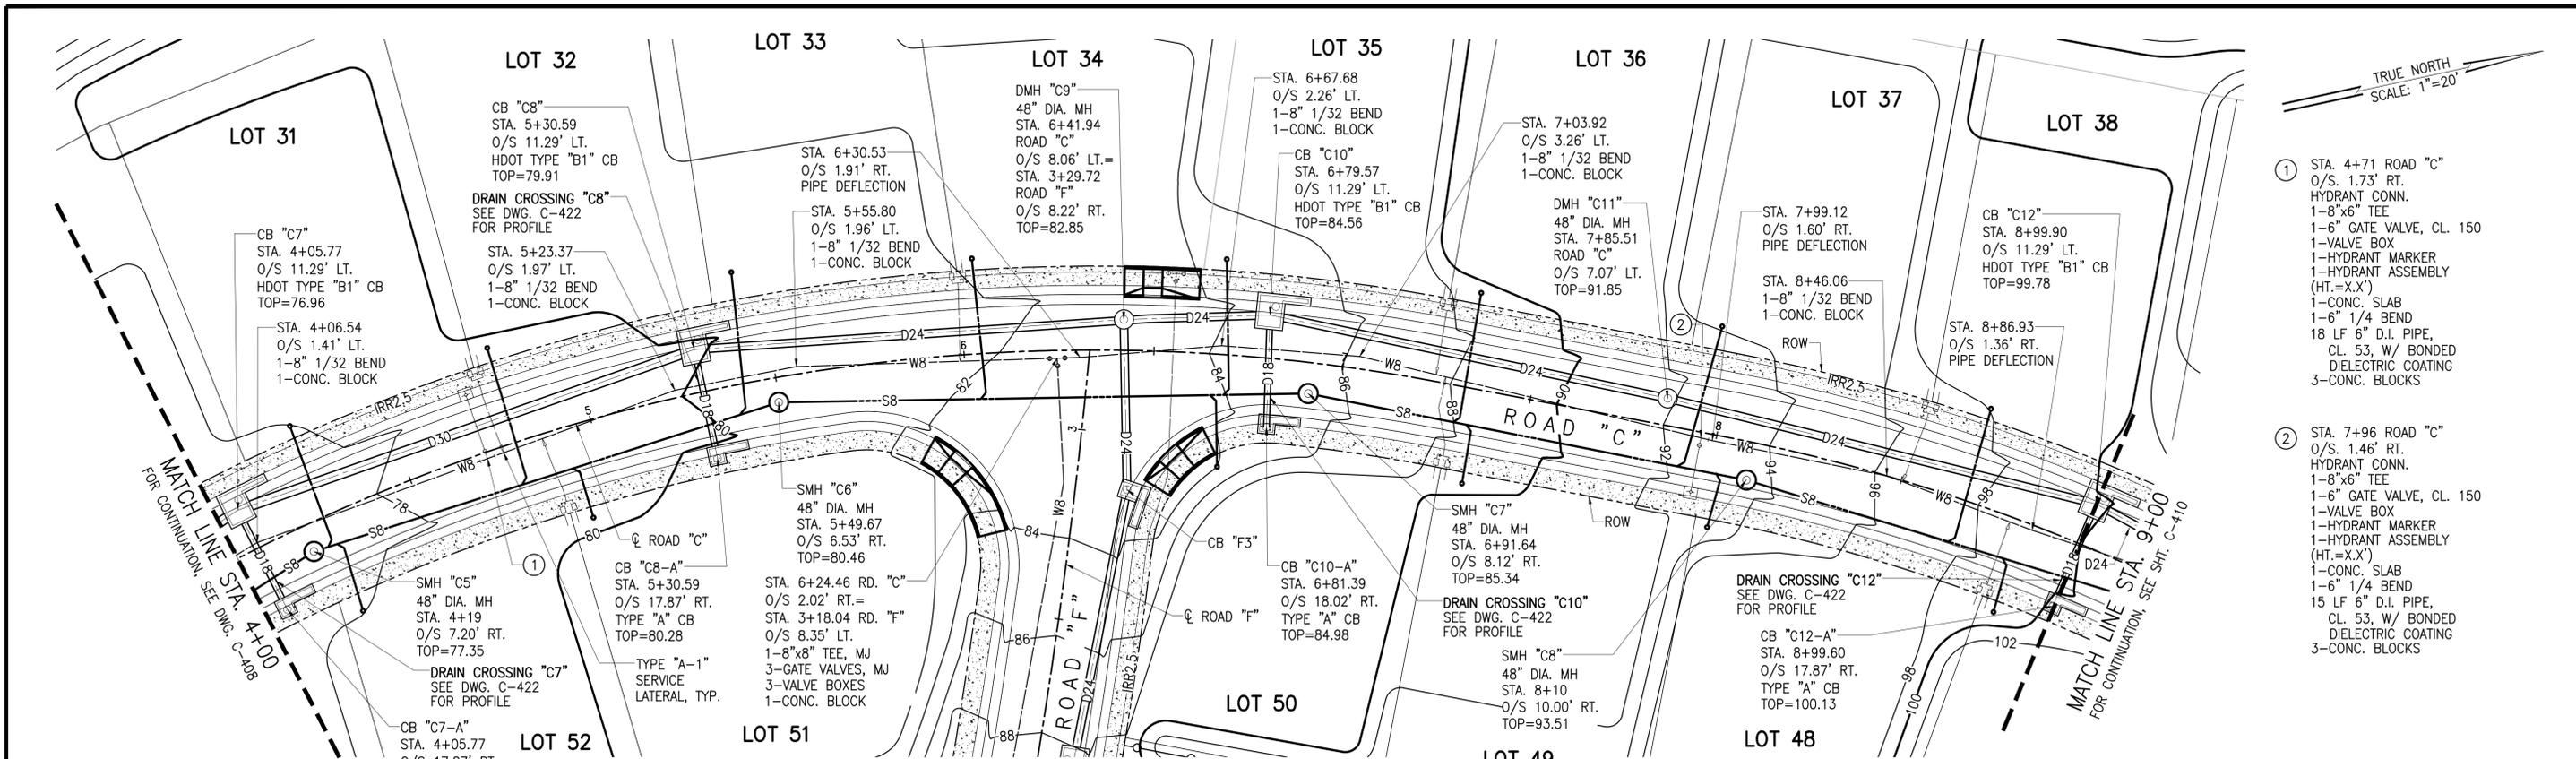

TRUE NORTH
SCALE: 1"=20'

- ① STA. 4+71 ROAD "C"
O/S. 1.73' RT.
HYDRANT CONN.
1-8"x6" TEE
1-6" GATE VALVE, CL. 150
1-VALVE BOX
1-HYDRANT MARKER
1-HYDRANT ASSEMBLY (HT.=X.X')
1-CONC. SLAB
1-6" 1/4 BEND
18 LF 6" D.I. PIPE,
CL. 53, W/ BONDED
DIELECTRIC COATING
3-CONC. BLOCKS
- ② STA. 7+96 ROAD "C"
O/S. 1.46' RT.
HYDRANT CONN.
1-8"x6" TEE
1-6" GATE VALVE, CL. 150
1-VALVE BOX
1-HYDRANT MARKER
1-HYDRANT ASSEMBLY (HT.=X.X')
1-CONC. SLAB
1-6" 1/4 BEND
15 LF 6" D.I. PIPE,
CL. 53, W/ BONDED
DIELECTRIC COATING
3-CONC. BLOCKS

PLAN - UTILITY ROAD "C" STA. 4+00 TO STA. 9+00
SCALE: 1"=20'

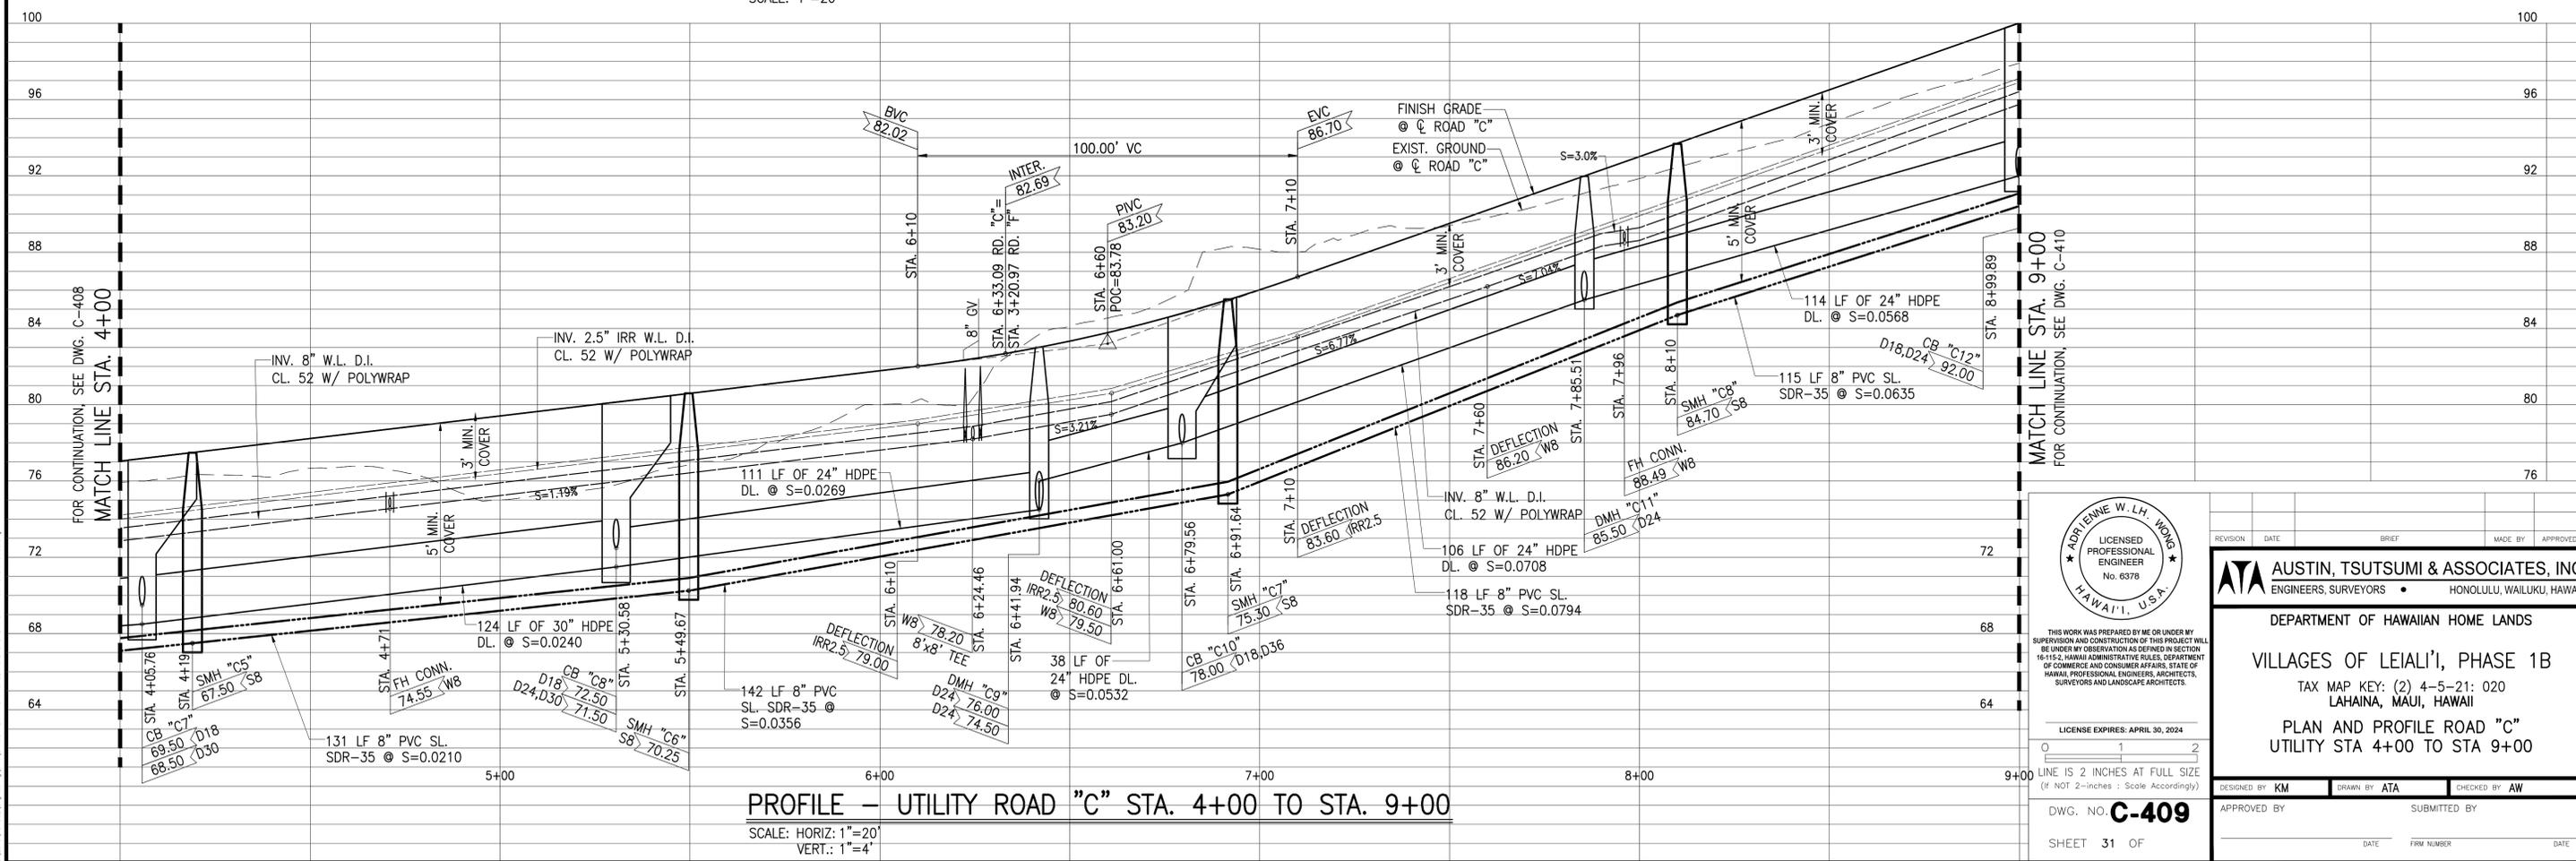

PROFILE - UTILITY ROAD "C" STA. 4+00 TO STA. 9+00
SCALE: HORIZ: 1"=20'
VERT.: 1"=4'



THIS WORK WAS PREPARED BY ME OR UNDER MY SUPERVISION AND CONSTRUCTION OF THIS PROJECT WILL BE UNDER MY OBSERVATION AS DEFINED IN SECTION 16-115-2, HAWAII ADMINISTRATIVE RULES, DEPARTMENT OF COMMERCE AND CONSUMER AFFAIRS, STATE OF HAWAII. PROFESSIONAL ENGINEER, ARCHITECTS, SURVEYORS AND LANDSCAPE ARCHITECTS.

LICENSE EXPIRES: APRIL 30, 2024

LINE IS 2 INCHES AT FULL SIZE
(IF NOT 2-INCHES : SCALE ACCORDINGLY)

DWG. NO. **C-409**

SHEET 31 OF

| REVISION | DATE | BRIEF | MADE BY | APPROVED |
|----------|------|-------|---------|----------|
| | | | | |

ATA AUSTIN, TSUTSUMI & ASSOCIATES, INC.
ENGINEERS, SURVEYORS • HONOLULU, WAILUKU, HAWAII

DEPARTMENT OF HAWAIIAN HOME LANDS

VILLAGES OF LEIALI'I, PHASE 1B

TAX MAP KEY: (2) 4-5-21: 020
LAHAINA, MAUI, HAWAII


PLAN AND PROFILE ROAD "C"
UTILITY STA 4+00 TO STA 9+00

DESIGNED BY: **KM** DRAWN BY: **ATA** CHECKED BY: **AW**



APPROVED BY: _____ SUBMITTED BY: _____

DATE: _____ FIRM NUMBER: _____ DATE: _____

A:\2024\18-522\DWG\C-409 PLAN AND PROFILE ROAD C UTILITY STA 4+00 TO STA 9+00.dwg

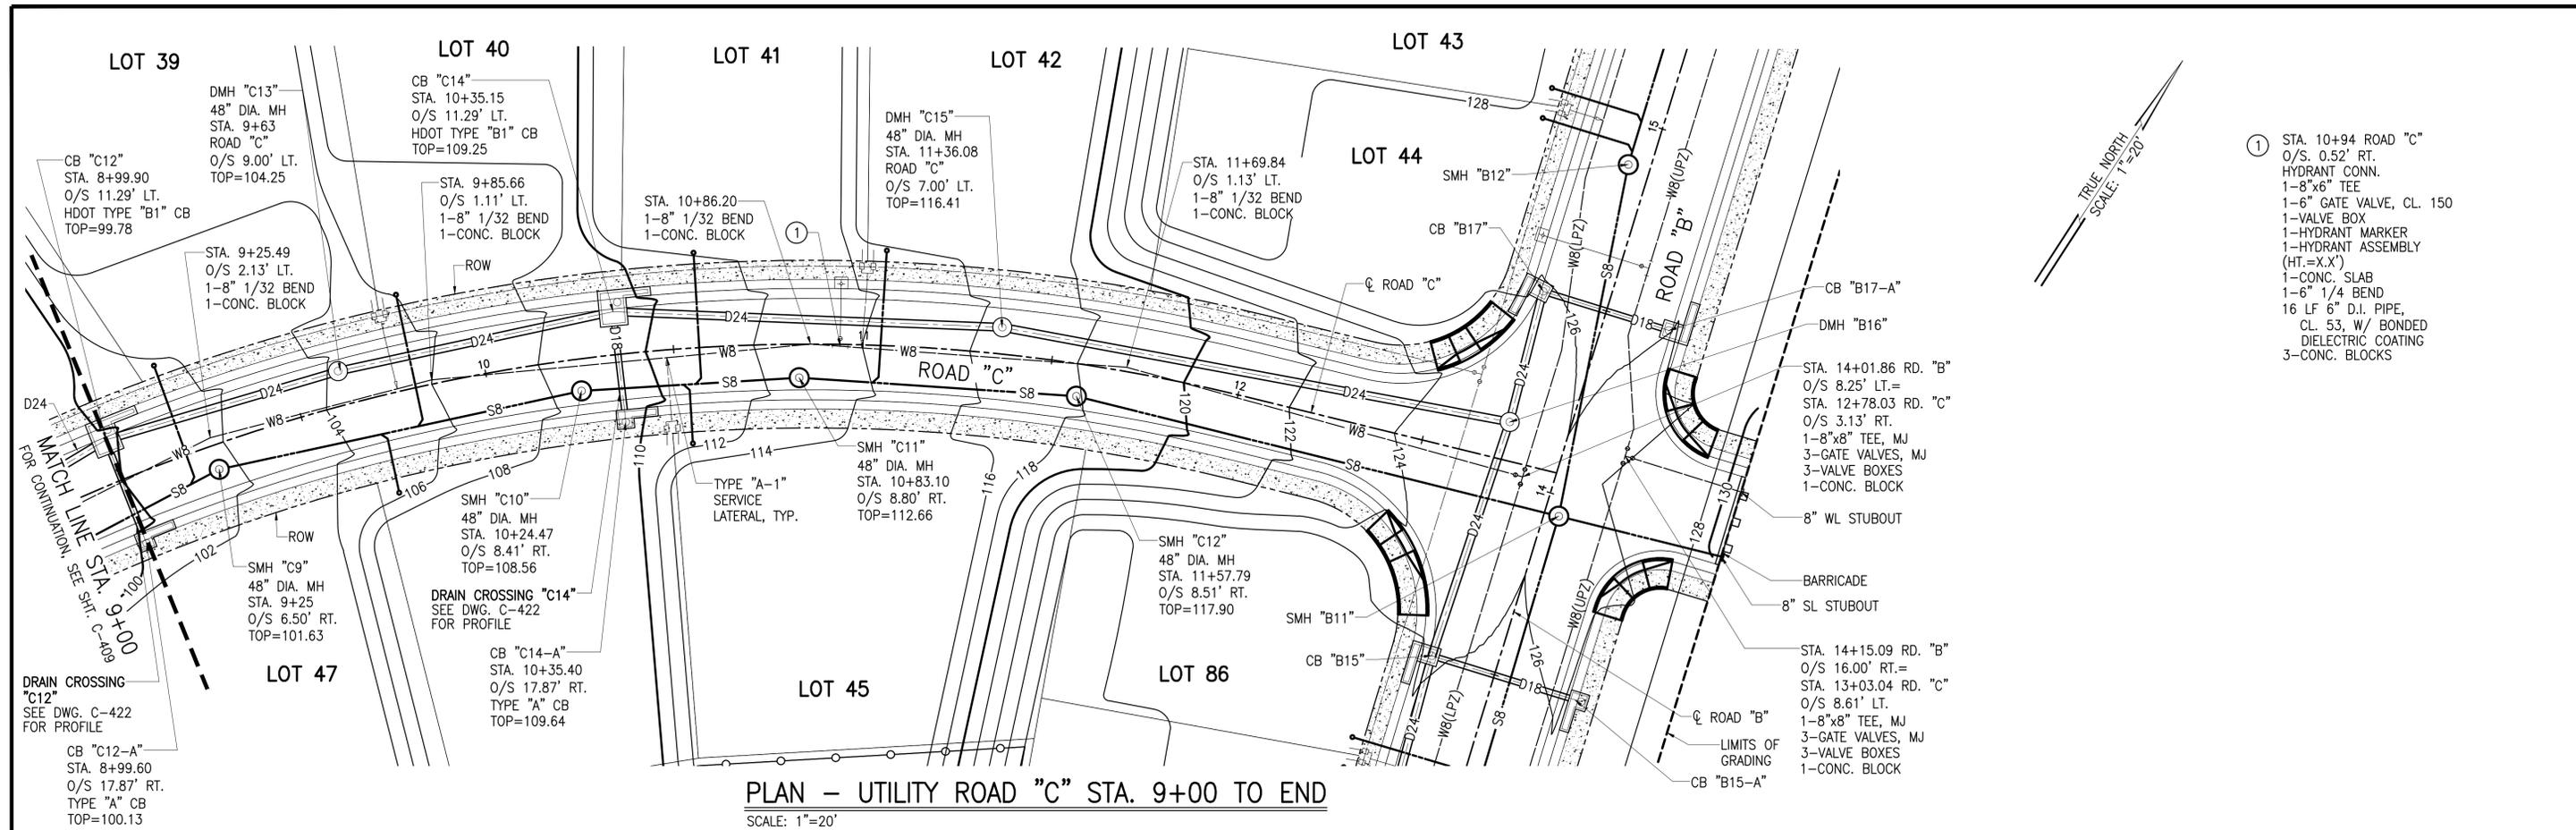

- ① STA. 10+94 ROAD "C"
O/S. 0.52' RT.
HYDRANT CONN.
1-8"x6" TEE
1-6" GATE VALVE, CL. 150
1-VALVE BOX
1-HYDRANT MARKER
1-HYDRANT ASSEMBLY
(HT.=X.X')
1-CONC. SLAB
1-6" 1/4 BEND
16 LF 6" D.I. PIPE,
CL. 53, W/ BONDED
DIELECTRIC COATING
3-CONC. BLOCKS

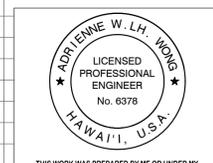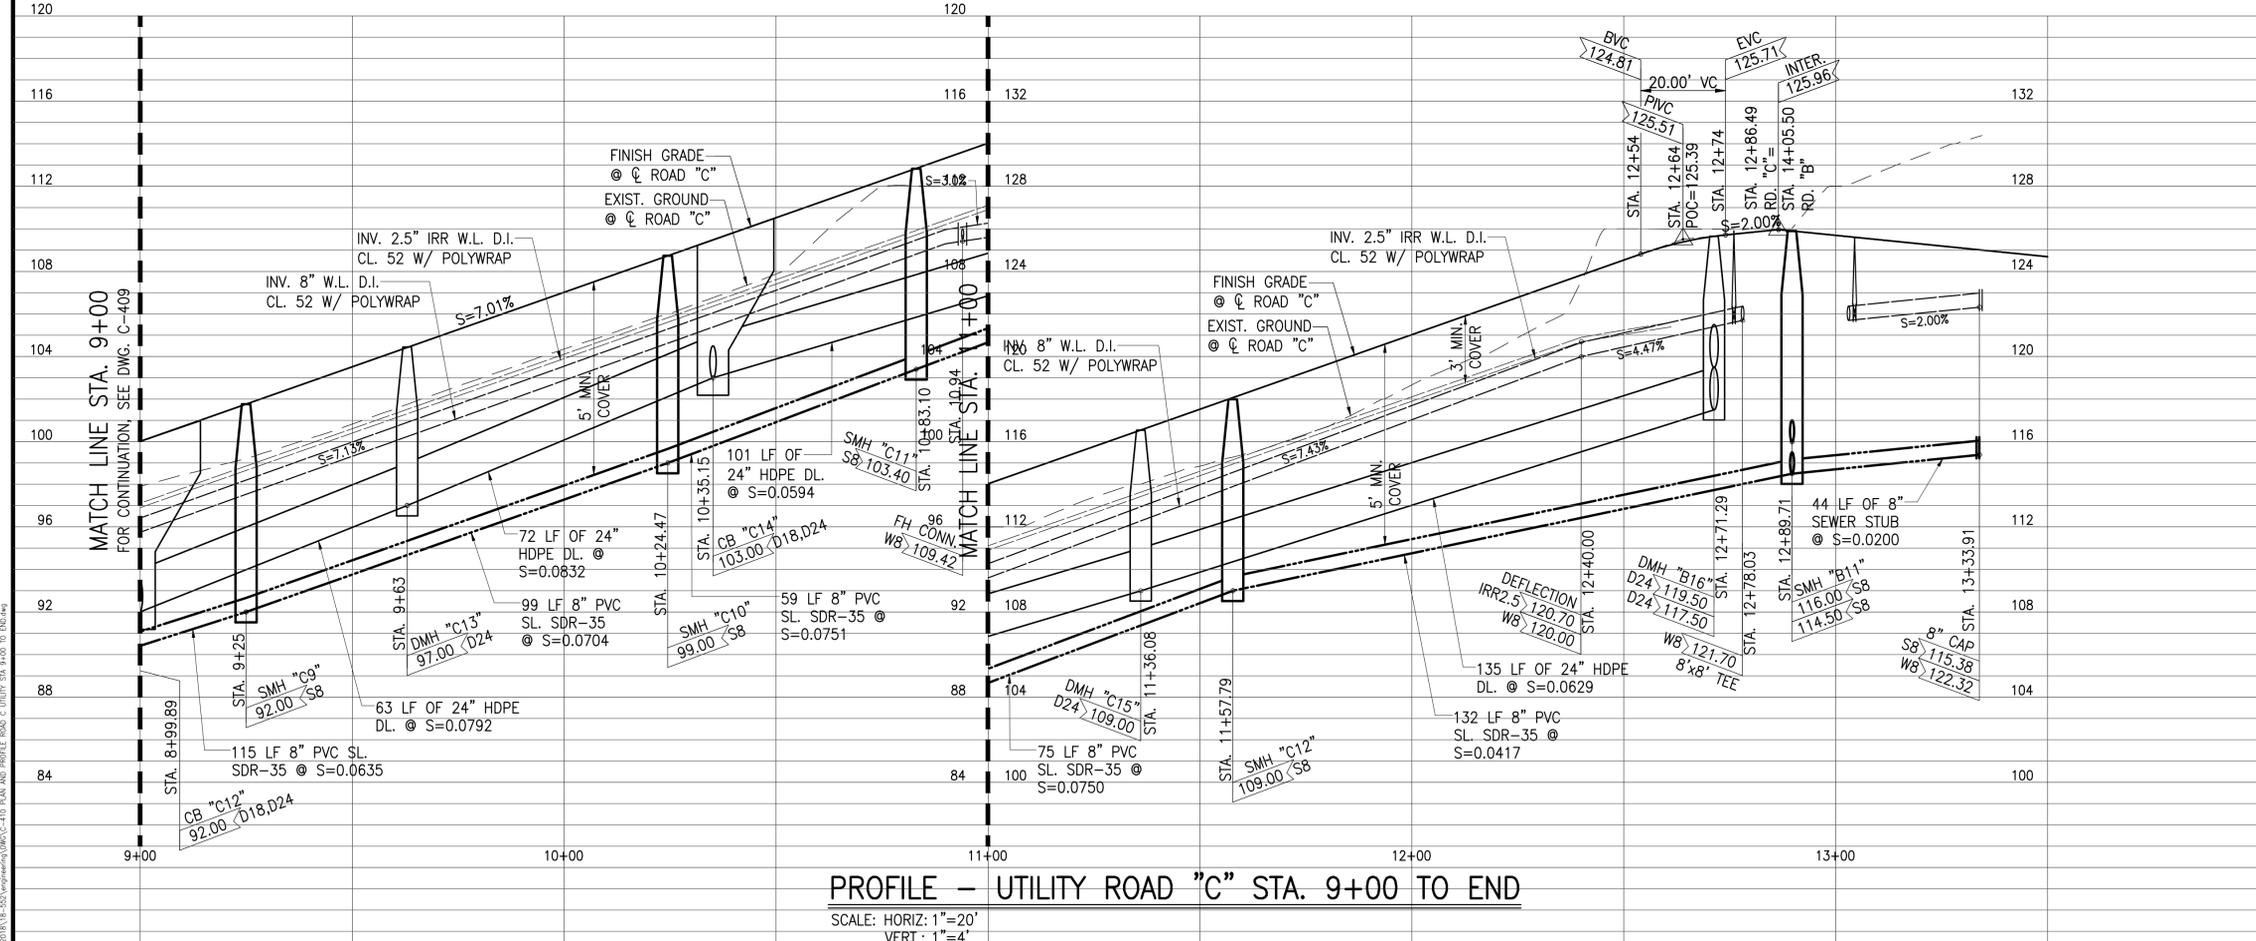

THIS WORK WAS PREPARED BY ME OR UNDER MY SUPERVISION AND CONSTRUCTION OF THIS PROJECT WILL BE UNDER MY OBSERVATION AS DEFINED IN SECTION 16-115-2, HAWAII ADMINISTRATIVE RULES, DEPARTMENT OF COMMERCE AND CONSUMER AFFAIRS, STATE OF HAWAII. PROFESSIONAL ENGINEER, ARCHITECT, SURVEYORS AND LANDSCAPE ARCHITECTS.



LICENSE EXPIRES: APRIL 30, 2024


LINE IS 2 INCHES AT FULL SIZE
(IF NOT 2-INCHES : Scale Accordingly)

DWG. NO. **C-410**


SHEET 32 OF

| | | | | |
|-----------------------------------------------------------------------------------------------------------------------------------------------------------------------------------------------------------|------|--------------|---------|------------|
| REVISION | DATE | BRIEF | MADE BY | APPROVED |
| | | | | |
| ATA AUSTIN, TSUTSUMI & ASSOCIATES, INC. ENGINEERS, SURVEYORS • HONOLULU, WAILUKU, HAWAII | | | | |
| DEPARTMENT OF HAWAIIAN HOME LANDS VILLAGES OF LEIALI'I, PHASE 1B TAX MAP KEY: (2) 4-5-21: 020 LAHAINA, MAUI, HAWAII PLAN AND PROFILE ROAD "C" UTILITY STA 9+00 TO END | | | | |
| DESIGNED BY | KM | DRAWN BY | ATA | CHECKED BY |
| APPROVED BY | | SUBMITTED BY | AW | |
| DATE | | FIRM NUMBER | | DATE |

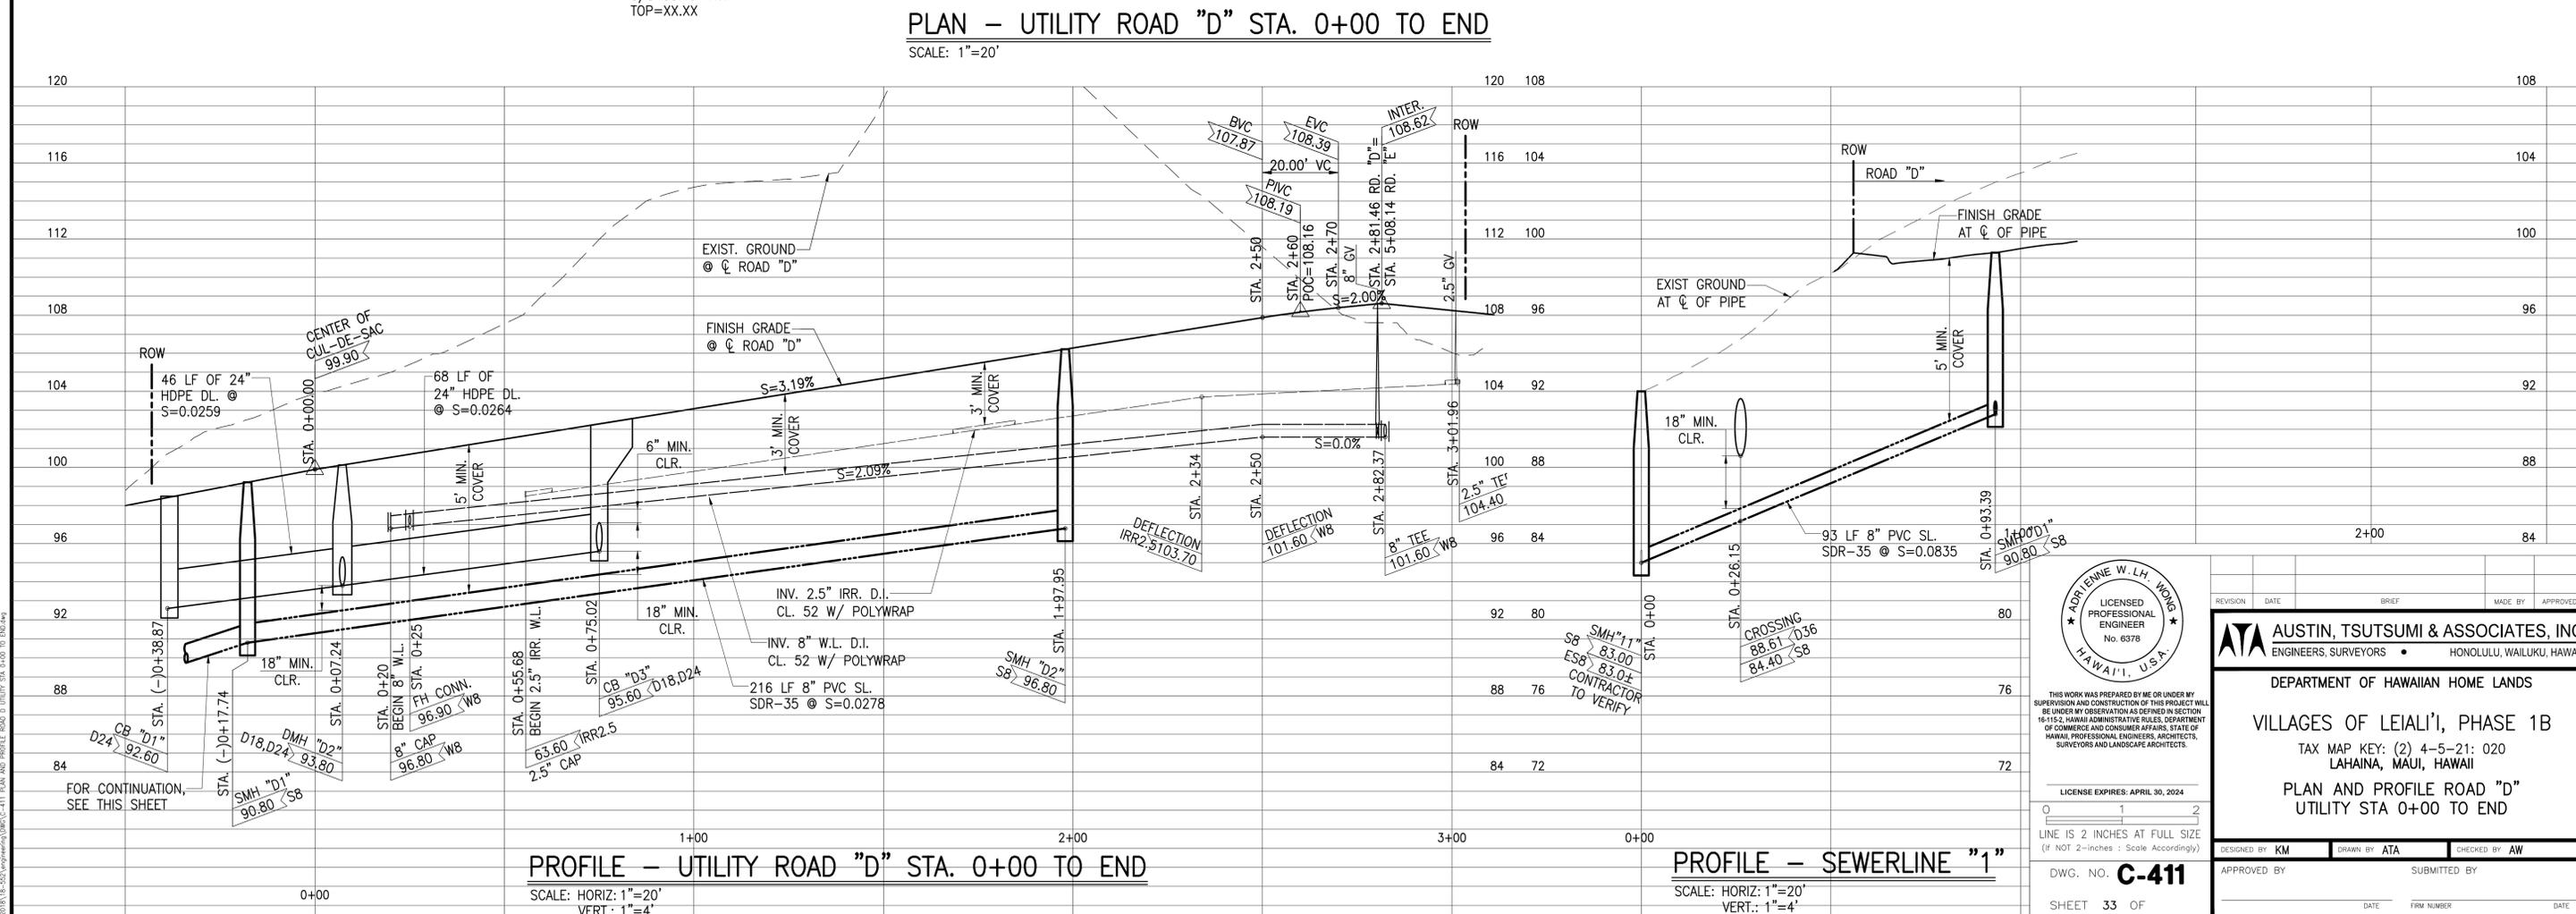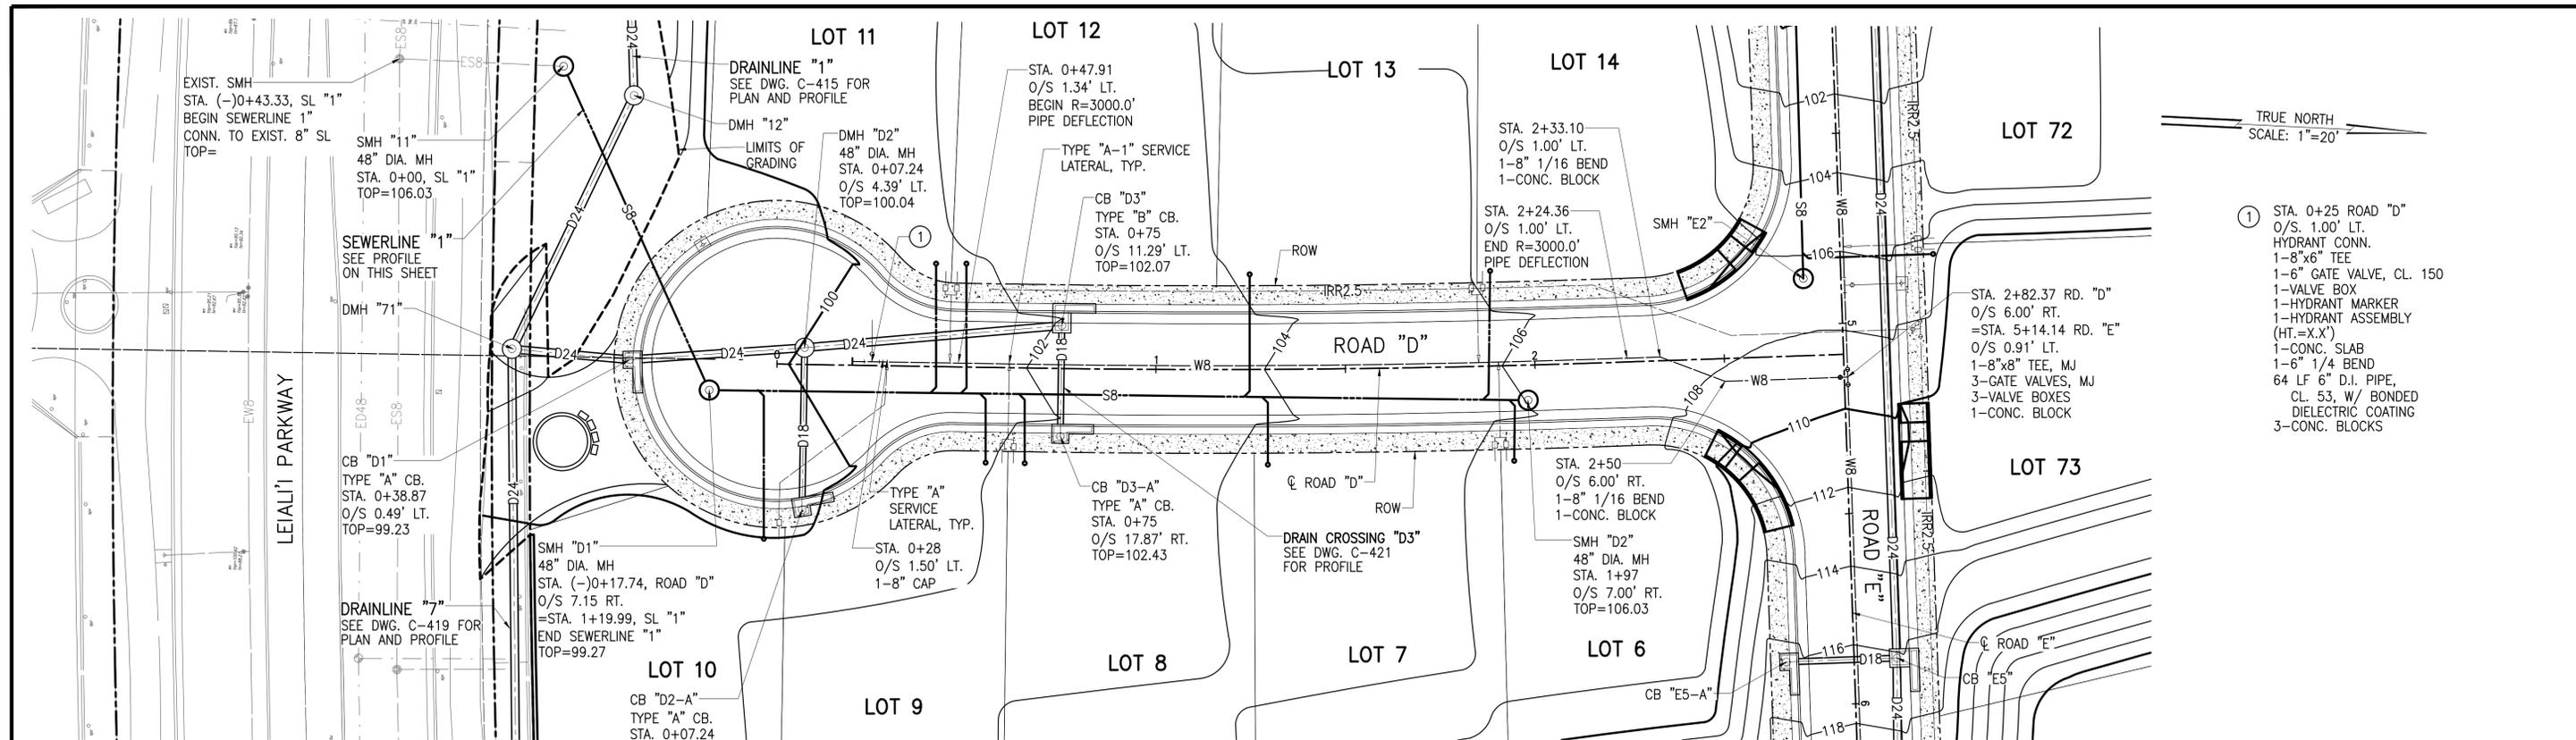

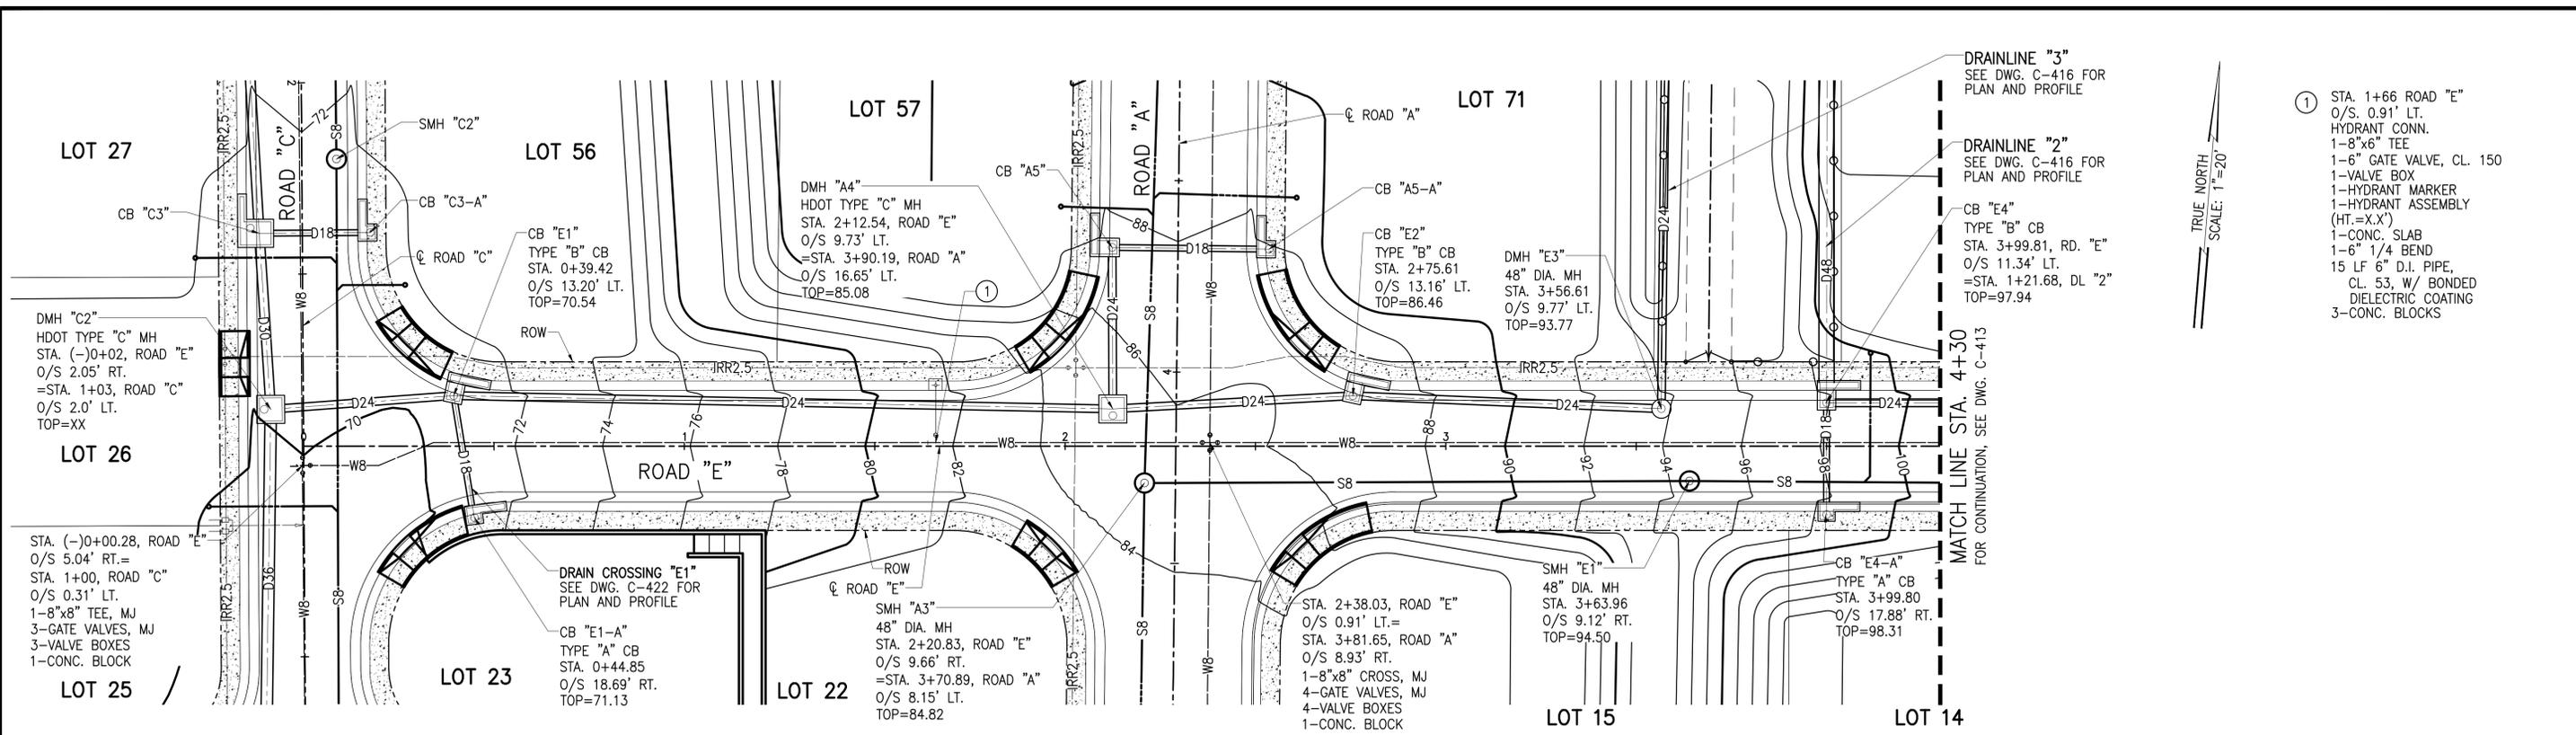

PLAN - UTILITY ROAD "E" STA. 0+00 TO STA. 4+30
 SCALE: 1"=20'

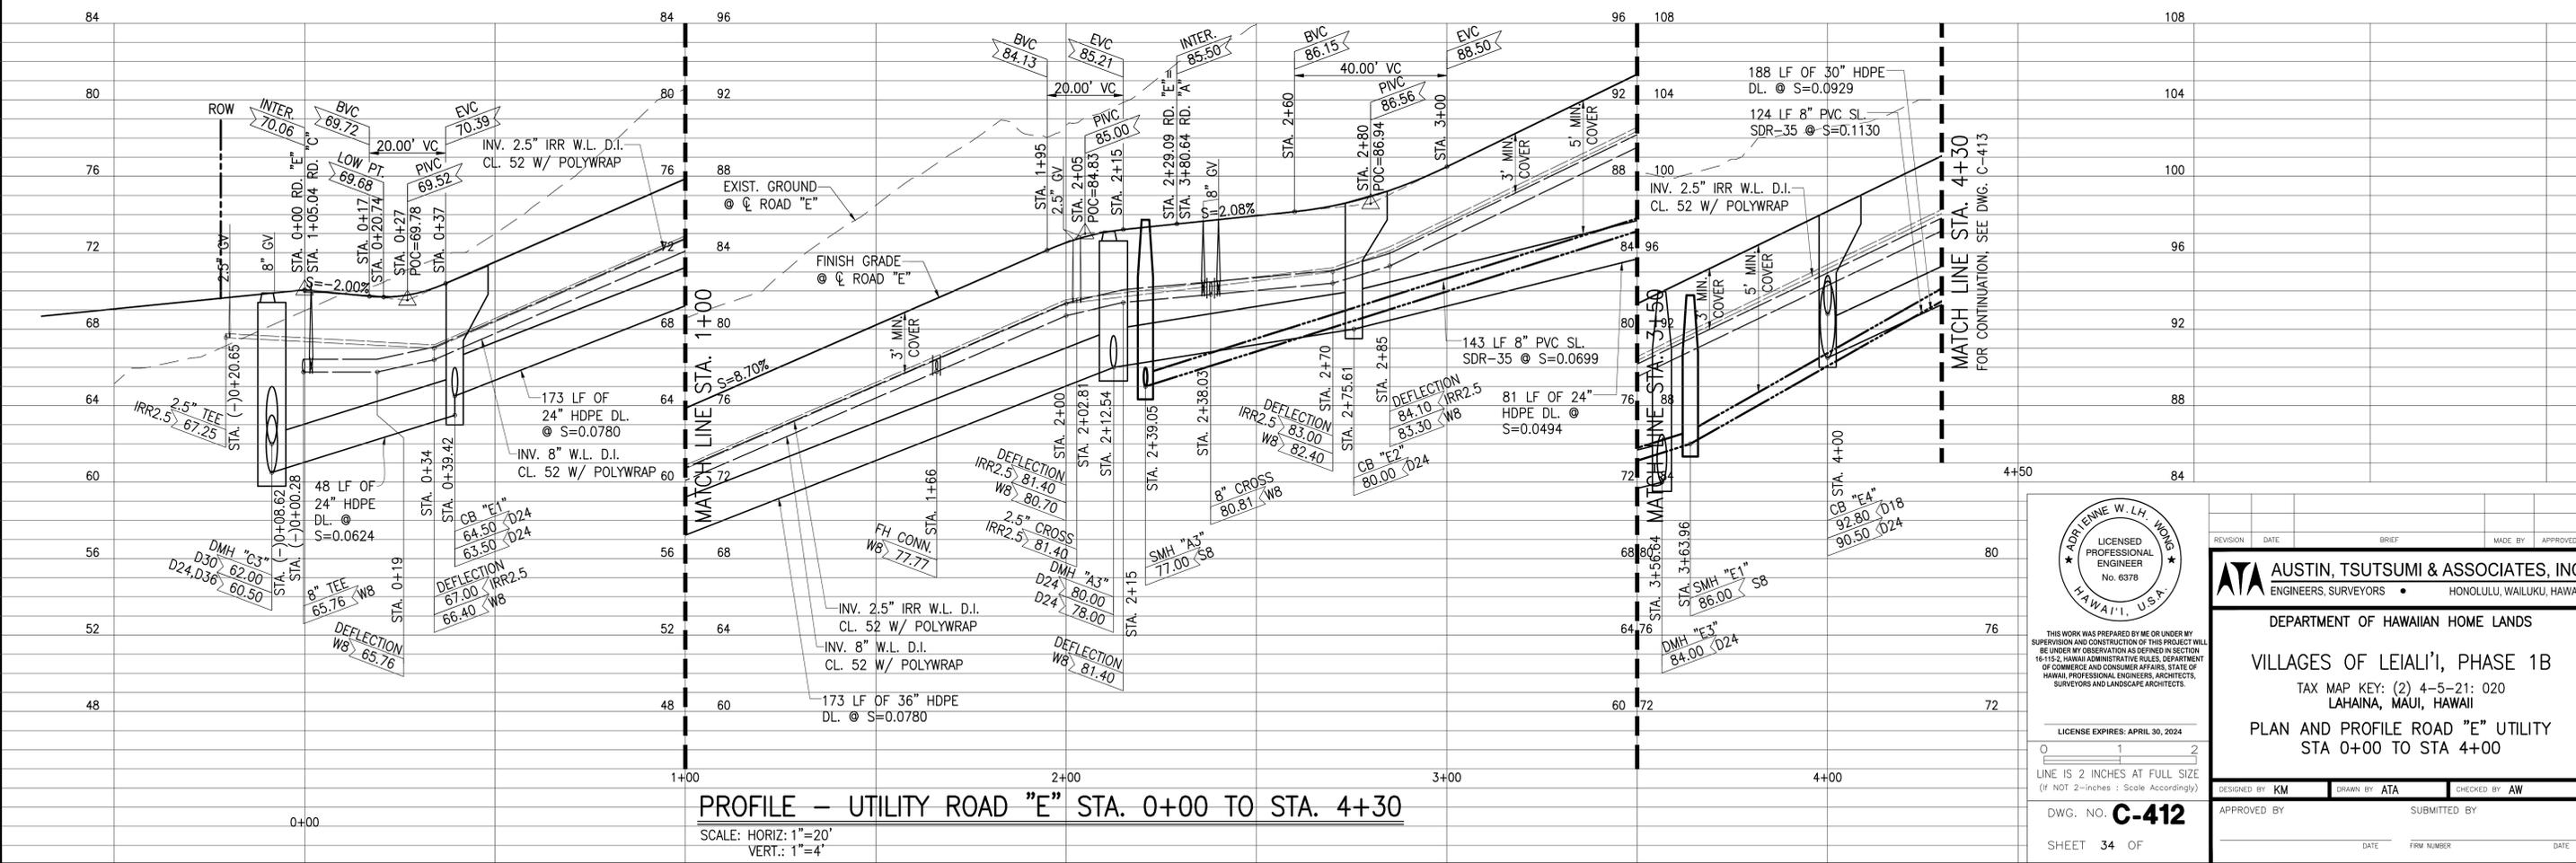

PROFILE - UTILITY ROAD "E" STA. 0+00 TO STA. 4+30
 SCALE: HORIZ: 1"=20'
 VERT.: 1"=4'

DRAINLINE "3"
 SEE DWG. C-416 FOR
 PLAN AND PROFILE

DRAINLINE "2"
 SEE DWG. C-416 FOR
 PLAN AND PROFILE

CB "E4"
 TYPE "B" CB
 STA. 3+99.81, RD. "E"
 O/S 11.34' LT.
 =STA. 1+21.68, DL "2"
 TOP=97.94



- ① STA. 1+66 ROAD "E"
 O/S. 0.91' LT.
 HYDRANT CONN.
 1-8"x6" TEE
 1-6" GATE VALVE, CL. 150
 1-VALVE BOX
 1-HYDRANT MARKER
 1-HYDRANT ASSEMBLY
 (HT.=X.X')
 1-CONC. SLAB
 1-6" 1/4 BEND
 15 LF 6" D.I. PIPE,
 CL. 53, W/ BONDED
 DIELECTRIC COATING
 3-CONC. BLOCKS

MATCH LINE STA. 4+30
 FOR CONTINUATION, SEE DWG. C-413

MATCH LINE STA. 4+30
 FOR CONTINUATION, SEE DWG. C-413



THIS WORK WAS PREPARED BY ME OR UNDER MY SUPERVISION AND CONSTRUCTION OF THIS PROJECT WILL BE UNDER MY OBSERVATION AS DEFINED IN SECTION 16-115-2, HAWAII ADMINISTRATIVE RULES, DEPARTMENT OF COMMERCE AND CONSUMER AFFAIRS, STATE OF HAWAII, PROFESSIONAL ENGINEERS, ARCHITECTS, SURVEYORS AND LANDSCAPE ARCHITECTS.

LICENSE EXPIRES: APRIL 30, 2024


LINE IS 2 INCHES AT FULL SIZE
 (IF NOT 2-INCHES : Scale Accordingly)

DWG. NO. **C-412**

SHEET 34 OF


| | | | | |
|---------------------------------------------------------------------------------------------------------------------------------------------------------------------------------------------------------|---------------------|----------------------|--------------------------------------|--------------|
| REVISION | DATE | BRIEF | MADE BY | APPROVED |
| ATA AUSTIN, TSUTSUMI & ASSOCIATES, INC. ENGINEERS, SURVEYORS • HONOLULU, WAILUKU, HAWAII | | | | |
| DEPARTMENT OF HAWAIIAN HOME LANDS VILLAGES OF LEIALI'I, PHASE 1B TAX MAP KEY: (2) 4-5-21: 020 LAHAINA, MAUI, HAWAII PLAN AND PROFILE ROAD "E" UTILITY STA 0+00 TO STA 4+00 | | | | |
| DESIGNED BY KM | DRAWN BY ATA | CHECKED BY AW | APPROVED BY _____ SUBMITTED BY _____ | |
| DATE _____ | FIRM NUMBER _____ | DATE _____ | FILE _____ | POCKET _____ |

A:\2018\18-522\18-522.dwg (C:\18-522.dwg) PLOT DATE: 09/20/23 10:54:00 AM

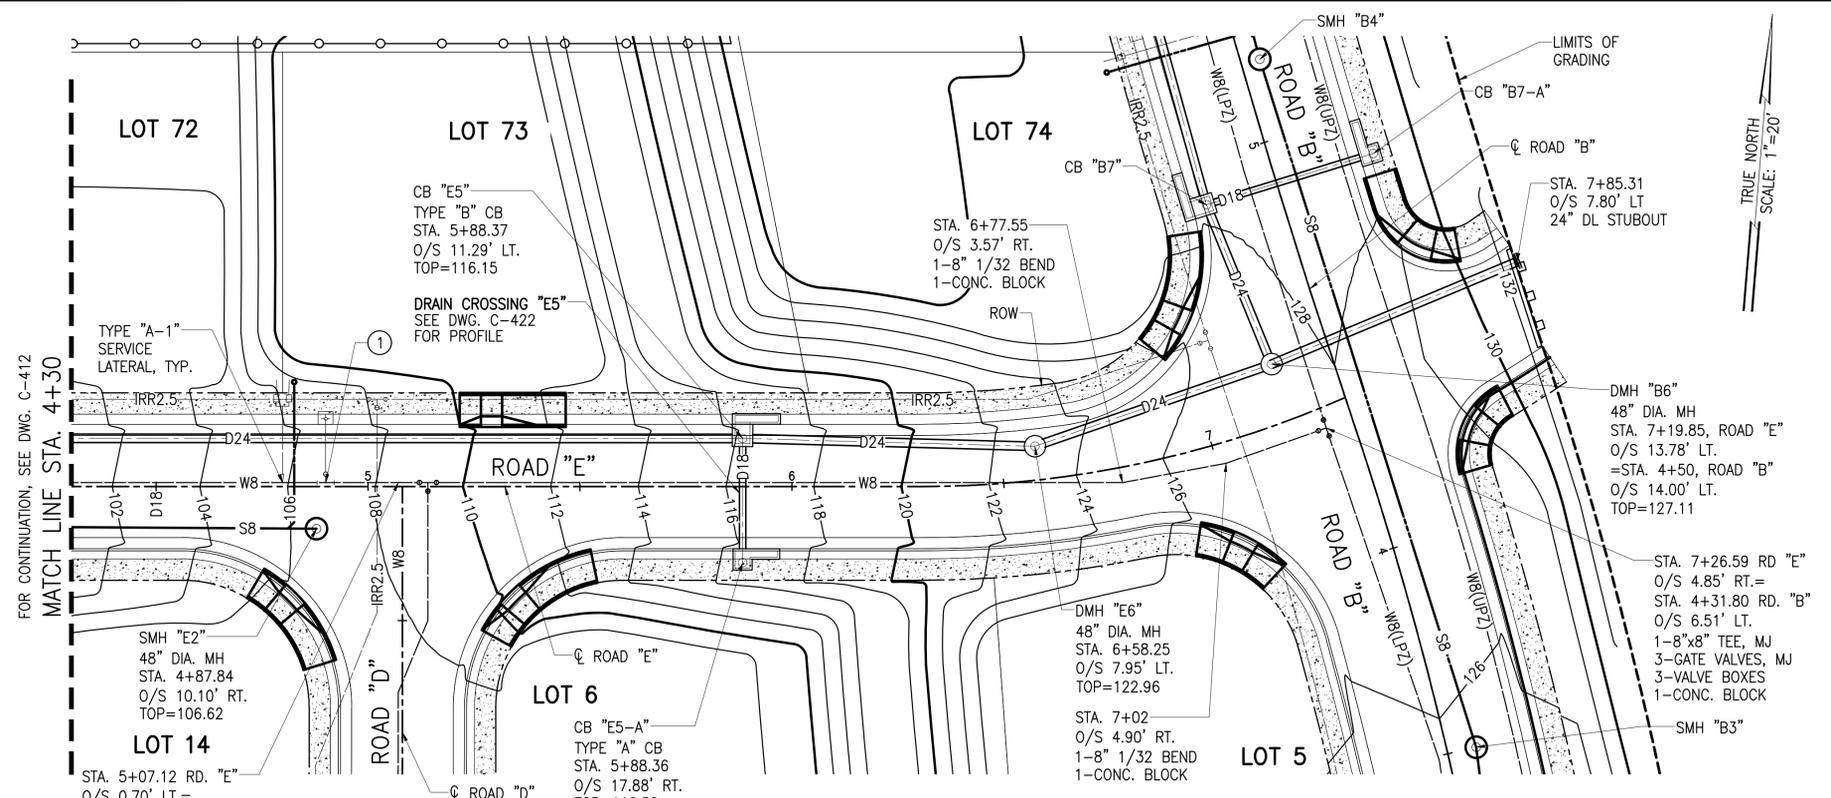


- ① STA. 4+90 ROAD "E"
O/S. 0.91' LT.
HYDRANT CONN.
1-8"x6" TEE
1-6" GATE VALVE, CL. 150
1-VALVE BOX
1-HYDRANT MARKER
1-HYDRANT ASSEMBLY (HT.=X.X')
1-CONC. SLAB
1-6" 1/4 BEND
15 LF 6" D.I. PIPE,
CL. 53, W/ BONDED DIELECTRIC COATING
3-CONC. BLOCKS

PLAN - UTILITY ROAD "E" STA. 4+30 TO END
SCALE: 1"=20'

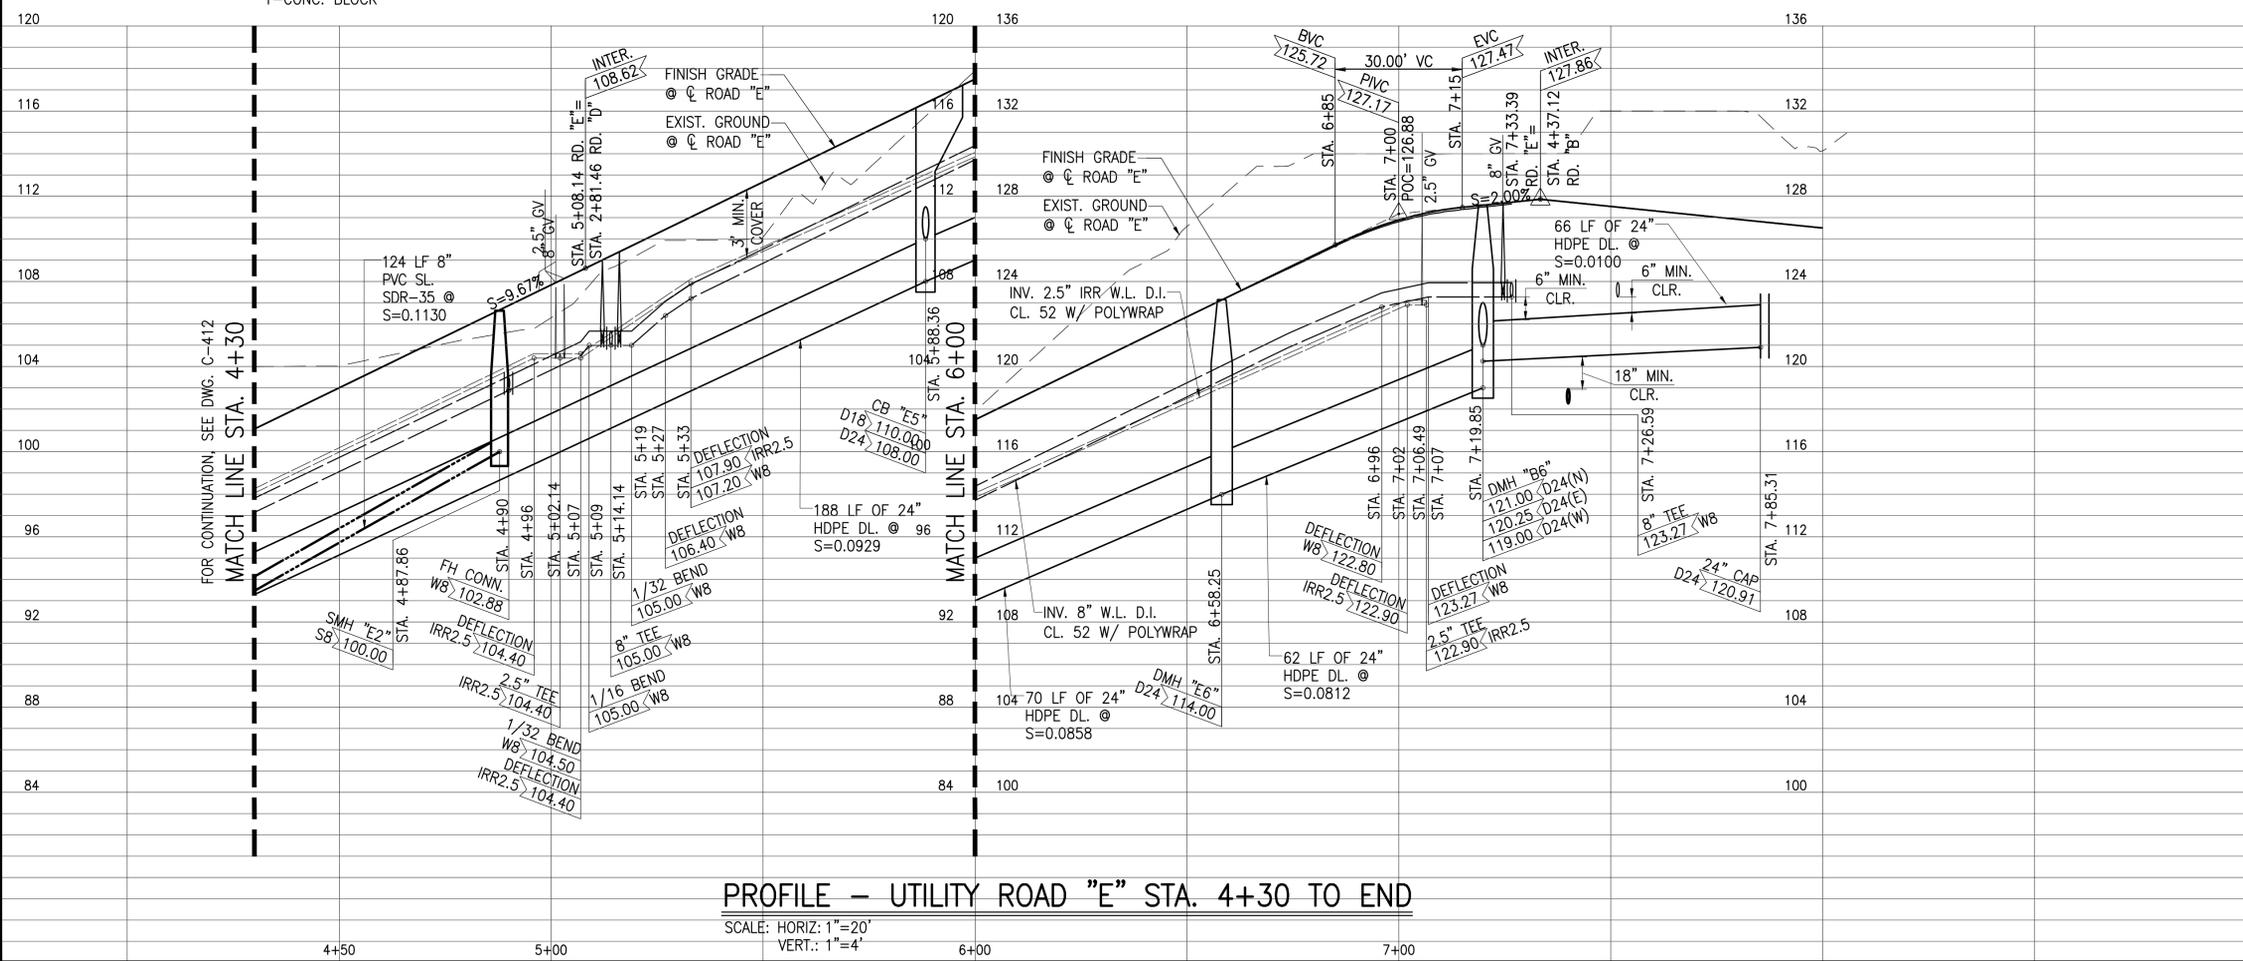

PROFILE - UTILITY ROAD "E" STA. 4+30 TO END
SCALE: HORIZ: 1"=20'
VERT.: 1"=4'

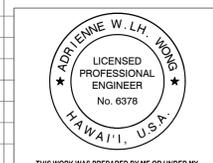

THIS WORK WAS PREPARED BY ME OR UNDER MY SUPERVISION AND CONSTRUCTION OF THIS PROJECT WILL BE UNDER MY OBSERVATION AS DEFINED IN SECTION 16-115-2, HAWAII ADMINISTRATIVE RULES, DEPARTMENT OF COMMERCE AND CONSUMER AFFAIRS, STATE OF HAWAII. PROFESSIONAL ENGINEER, ARCHITECT, SURVEYORS AND LANDSCAPE ARCHITECTS.


LICENSE EXPIRES: APRIL 30, 2024

0 1 2
LINE IS 2 INCHES AT FULL SIZE
(IF NOT 2-INCHES : Scale Accordingly)


DWG. NO. **C-413**
SHEET 35 OF

| REVISION | DATE | BRIEF | MADE BY | APPROVED | |
|-------------------------------------------------------------------------------------------------------------------------------------------------------------------------------------------------------------------------------------------------------------------------------------------------------------------------------------|------|--------------|---------|------------|----|
| <p>ATA AUSTIN, TSUTSUMI & ASSOCIATES, INC. ENGINEERS, SURVEYORS • HONOLULU, WAILUKU, HAWAII</p> <p>DEPARTMENT OF HAWAIIAN HOME LANDS</p> <p>VILLAGES OF LEIALI'I, PHASE 1B TAX MAP KEY: (2) 4-5-21: 020 LAHAINA, MAUI, HAWAII</p> <p>PLAN AND PROFILE ROAD "E" UTILITY STA 4+00 TO END</p> | | | | | |
| DESIGNED BY | KM | DRAWN BY | ATA | CHECKED BY | AW |
| APPROVED BY | | SUBMITTED BY | | | |
| DATE | | FIRM NUMBER | | DATE | |

A:\2018\18-522\p01\dwg\C-413 PLAN AND PROFILE ROAD "E" UTILITY STA 4+30 TO END.dwg

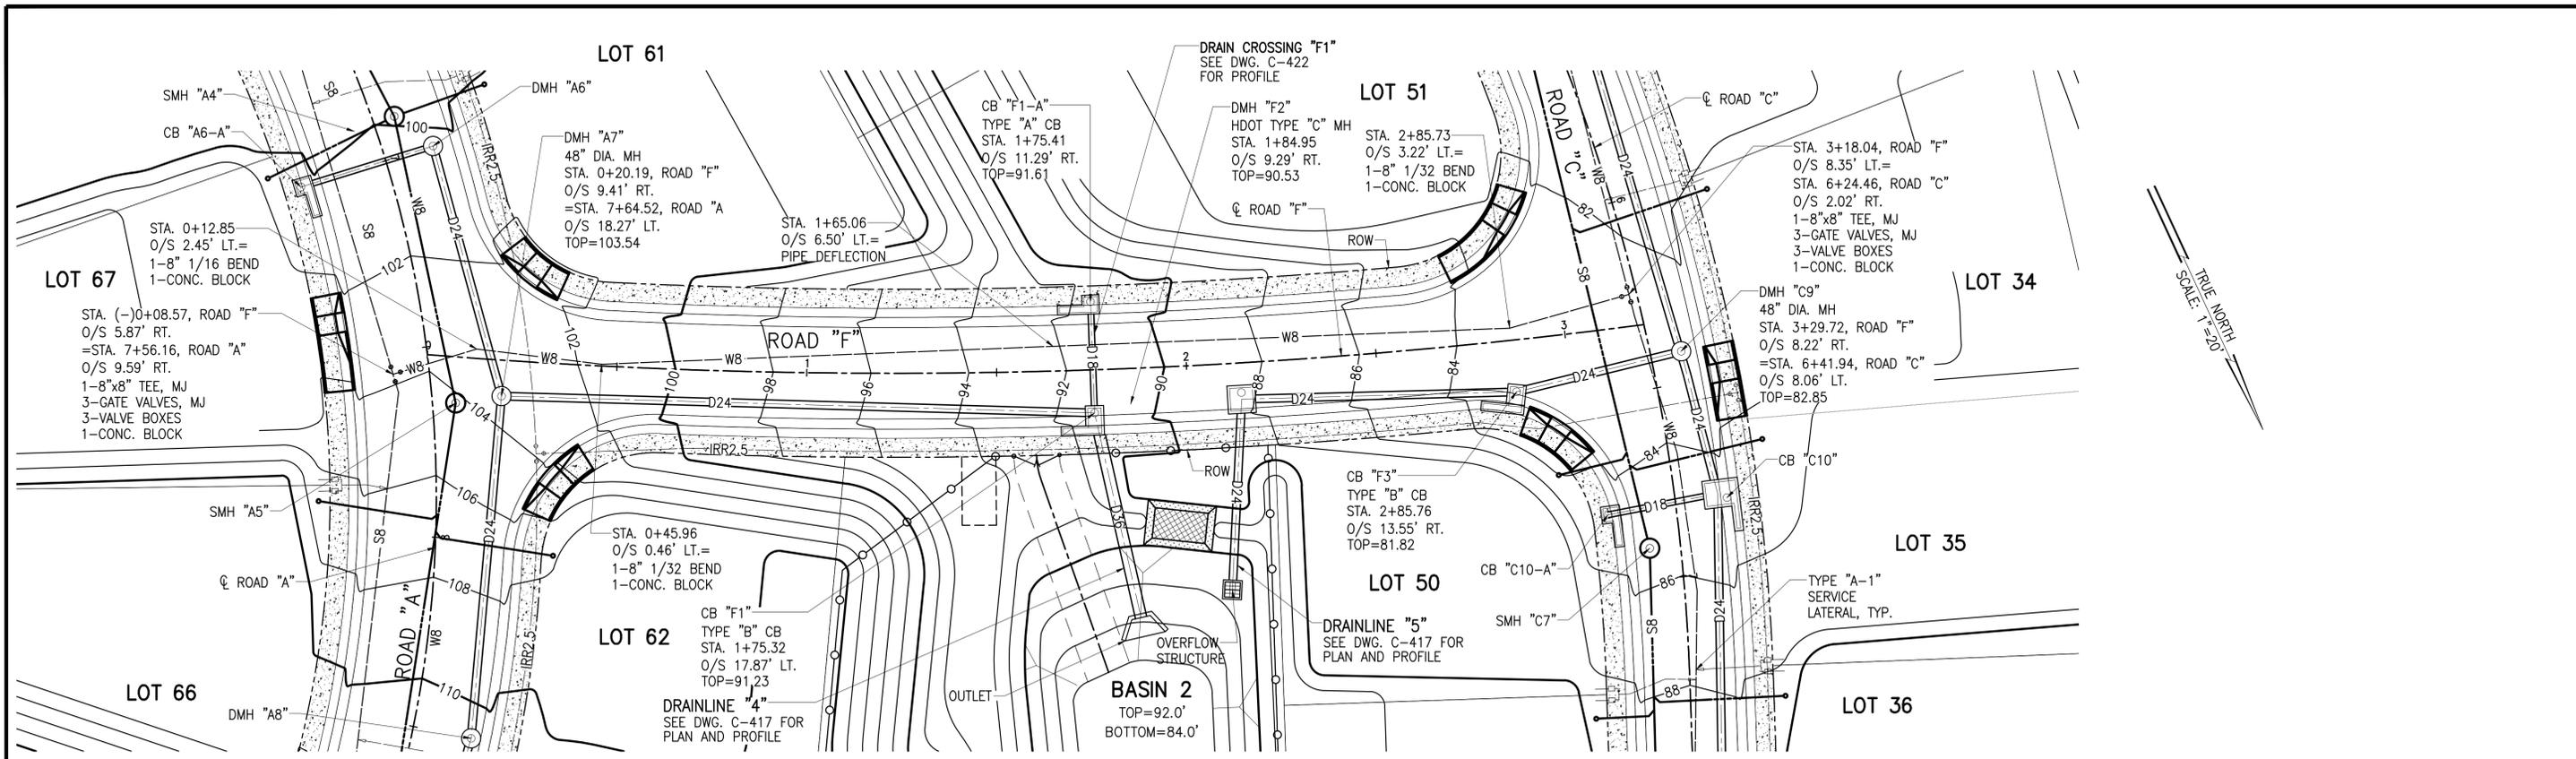

PLAN - UTILITY ROAD "F" STA. 0+00 TO END
SCALE: 1"=20'

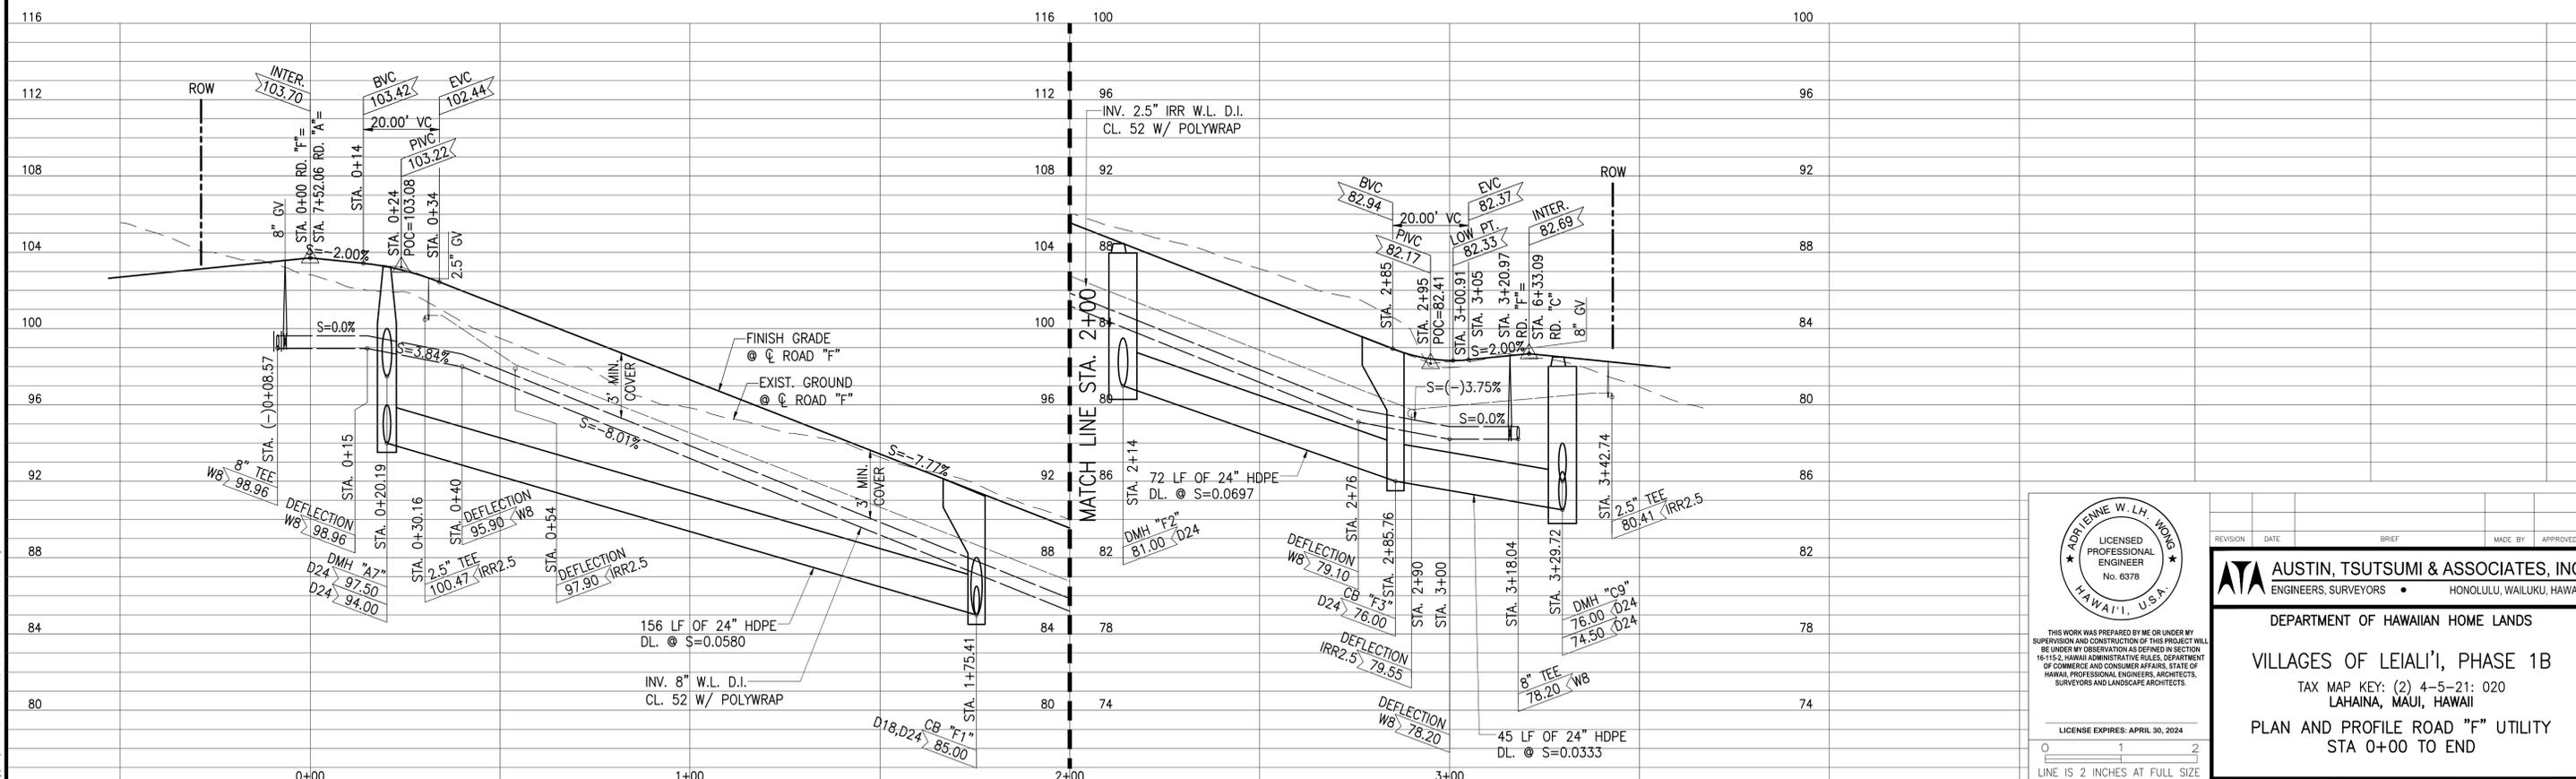

PROFILE - UTILITY ROAD "F" STA. 0+00 TO END
SCALE: HORIZ: 1"=20'
VERT.: 1"=4'



THIS WORK WAS PREPARED BY ME OR UNDER MY SUPERVISION AND CONSTRUCTION OF THIS PROJECT WILL BE UNDER MY OBSERVATION AS DEFINED IN SECTION 16-115-2, HAWAII ADMINISTRATIVE RULES, DEPARTMENT OF COMMERCE AND CONSUMER AFFAIRS, STATE OF HAWAII. PROFESSIONAL ENGINEER, ARCHITECTS, SURVEYORS AND LANDSCAPE ARCHITECTS.


LICENSE EXPIRES: APRIL 30, 2024

LINE IS 2 INCHES AT FULL SIZE
(IF NOT 2-INCHES: SCALE ACCORDINGLY)


DWG. NO. **C-414**

SHEET 36 OF

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|--------------------------------------------------------------------------------------------------------------------------------------------------------------------------------------------------------------|------|--------------|---------|------------|
| REVISION | DATE | BRIEF | MADE BY | APPROVED |
| ATA AUSTIN, TSUTSUMI & ASSOCIATES, INC. ENGINEERS, SURVEYORS • HONOLULU, WAILUKU, HAWAII | | | | |
| DEPARTMENT OF HAWAIIAN HOME LANDS VILLAGES OF LEIALI'I, PHASE 1B TAX MAP KEY: (2) 4-5-21: 020 LAHAINA, MAUI, HAWAII PLAN AND PROFILE ROAD "F" UTILITY STA 0+00 TO END | | | | |
| DESIGNED BY | KM | DRAWN BY | ATA | CHECKED BY |
| APPROVED BY | | SUBMITTED BY | AW | |
| DATE | | FILE NUMBER | | DATE |

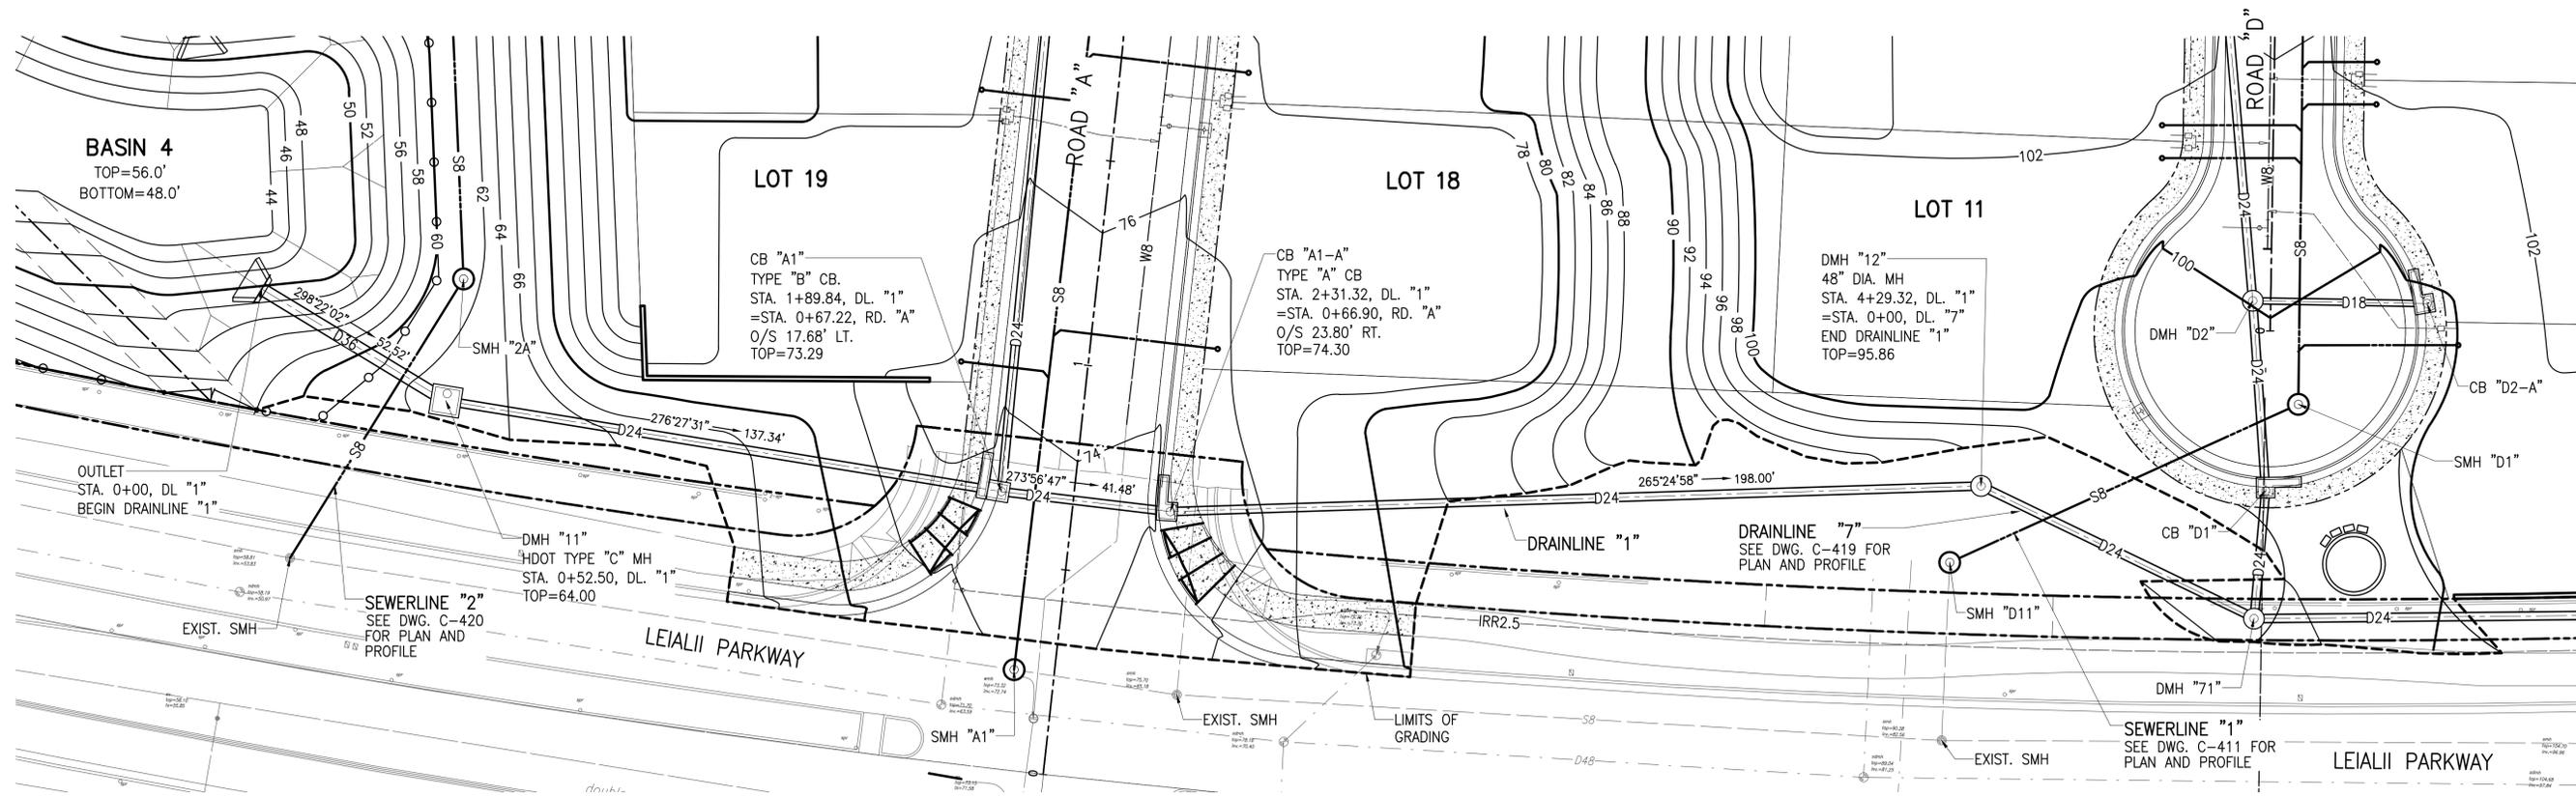

PLAN - DRAINLINE "1"
SCALE: 1"=20'

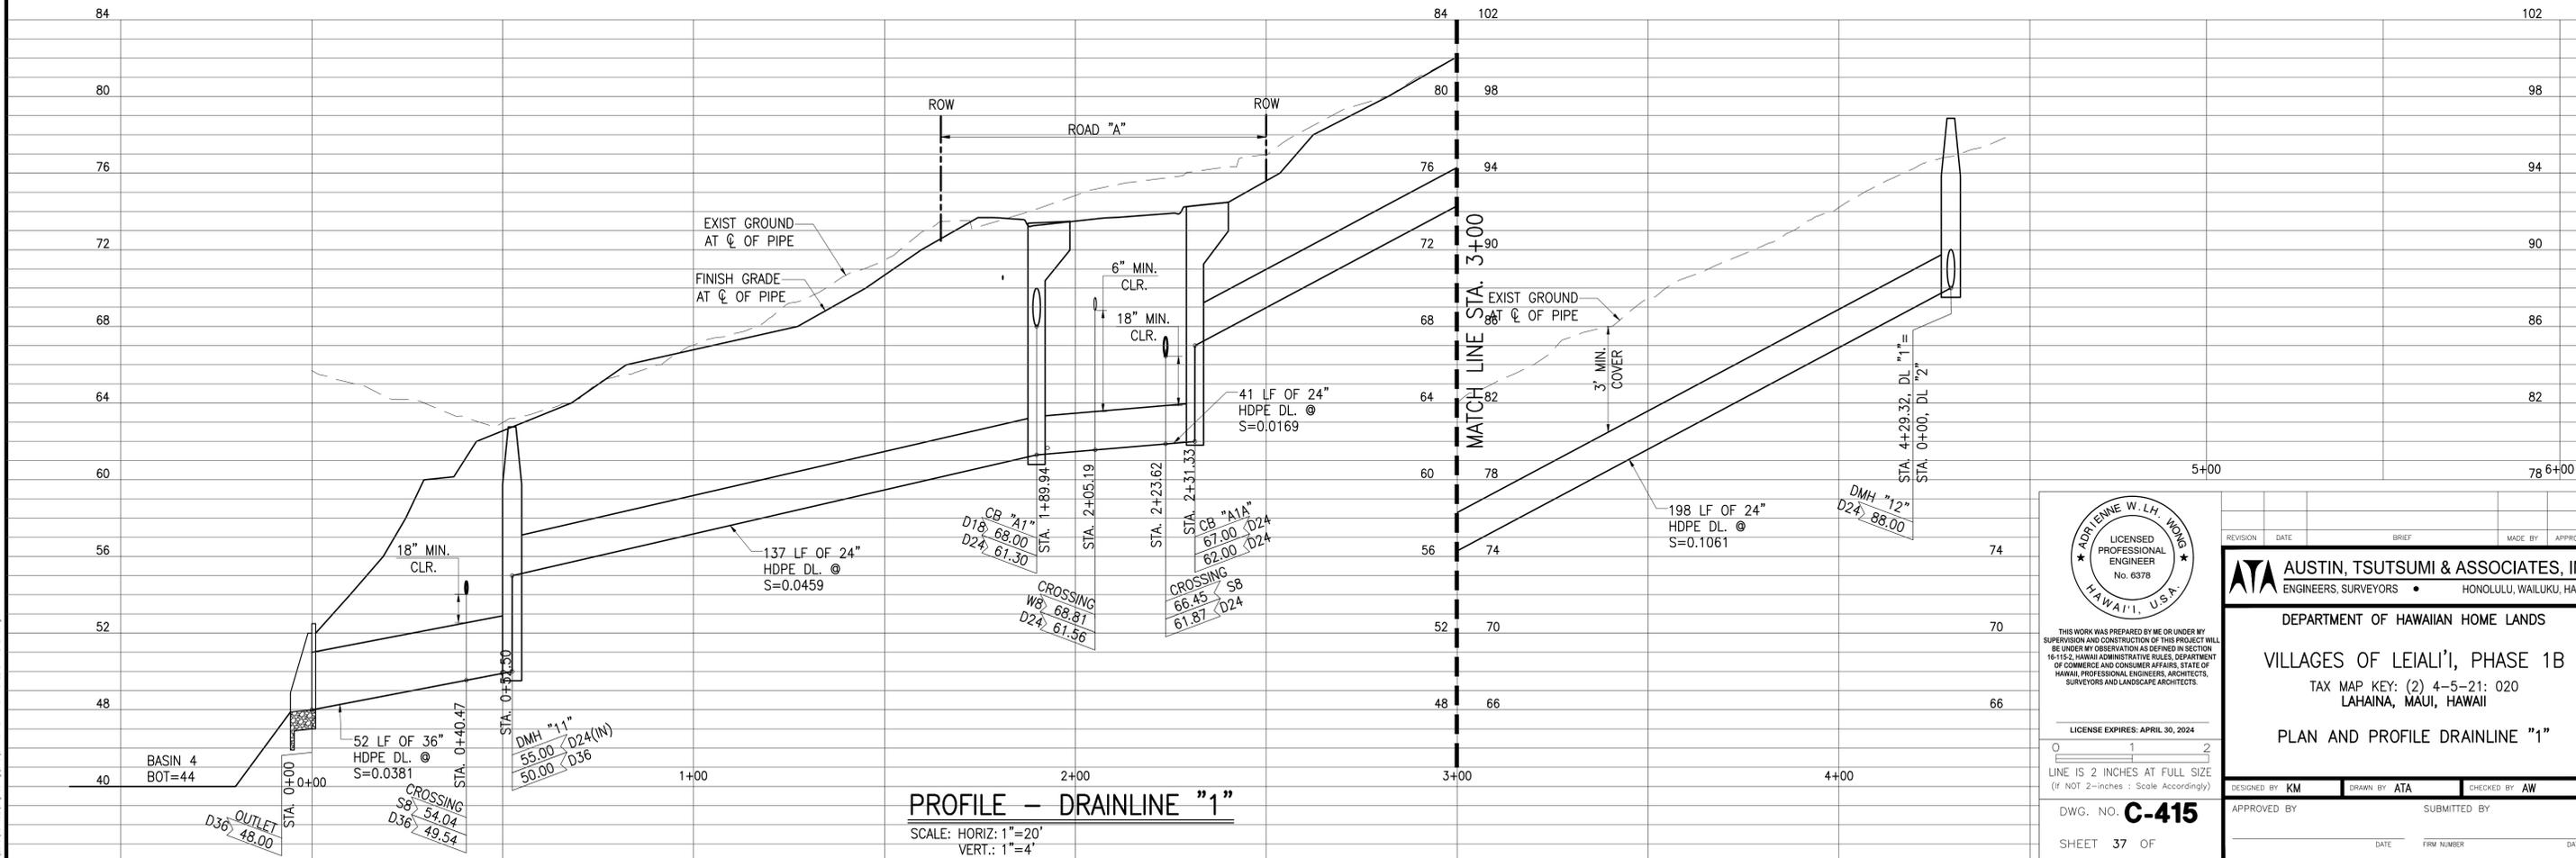

PROFILE - DRAINLINE "1"
SCALE: HORIZ.: 1"=20'
VERT.: 1"=4'

ADRIENNE W. L.H. HOOG
LICENSED PROFESSIONAL ENGINEER
No. 6378
HAWAII, U.S.A.

LICENSE EXPIRES: APRIL 30, 2024

THIS WORK WAS PREPARED BY ME OR UNDER MY SUPERVISION AND CONSTRUCTION OF THIS PROJECT WILL BE UNDER MY OBSERVATION AS DEFINED IN SECTION 16-115-2, HAWAII ADMINISTRATIVE RULES, DEPARTMENT OF COMMERCE AND CONSUMER AFFAIRS, STATE OF HAWAII, PROFESSIONAL ENGINEERS, ARCHITECTS, SURVEYORS AND LANDSCAPE ARCHITECTS.

LINE IS 2 INCHES AT FULL SIZE
(If NOT 2-inches : Scale Accordingly)

DWG. NO. **C-415**

SHEET 37 OF

| REVISION | DATE | BRIEF | MADE BY | APPROVED |
|----------|------|-------|---------|----------|
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ATA AUSTIN, TSUTSUMI & ASSOCIATES, INC.
ENGINEERS, SURVEYORS • HONOLULU, WAILUKU, HAWAII

DEPARTMENT OF HAWAIIAN HOME LANDS

VILLAGES OF LEIALI'I, PHASE 1B



TAX MAP KEY: (2) 4-5-21: 020
LAHAINA, MAUI, HAWAII

PLAN AND PROFILE DRAINLINE "1"

DESIGNED BY: **KM** DRAWN BY: **ATA** CHECKED BY: **AW**



APPROVED BY: _____ SUBMITTED BY: _____

DATE: _____ FIRM NUMBER: _____ DATE: _____

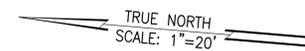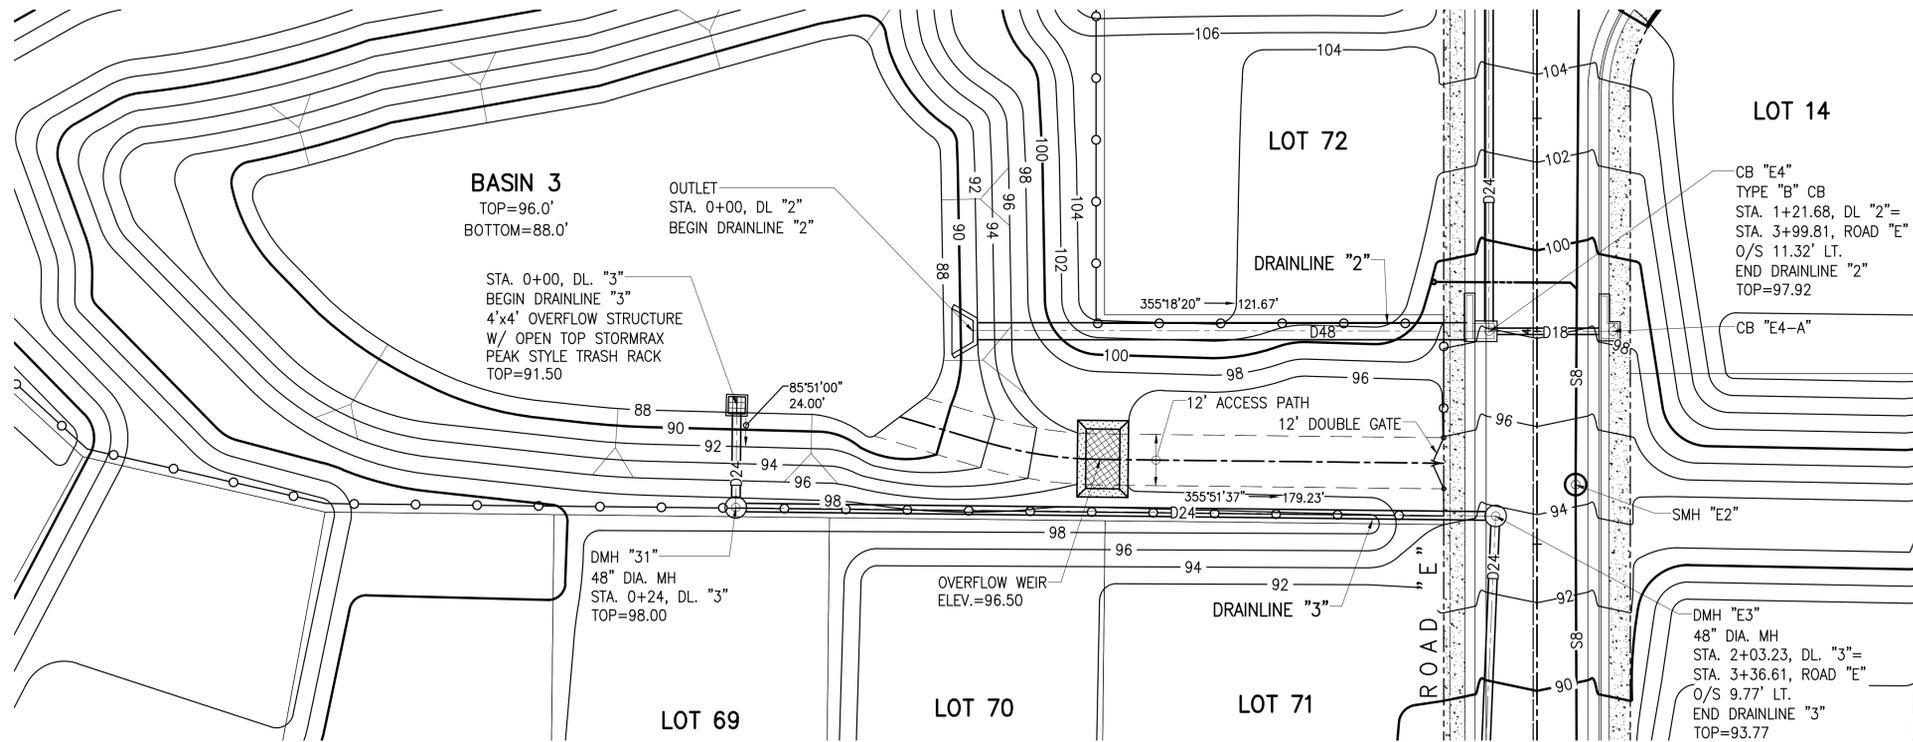

PLAN - DRAINLINE "2" & "3"

SCALE: 1"=20'

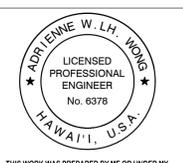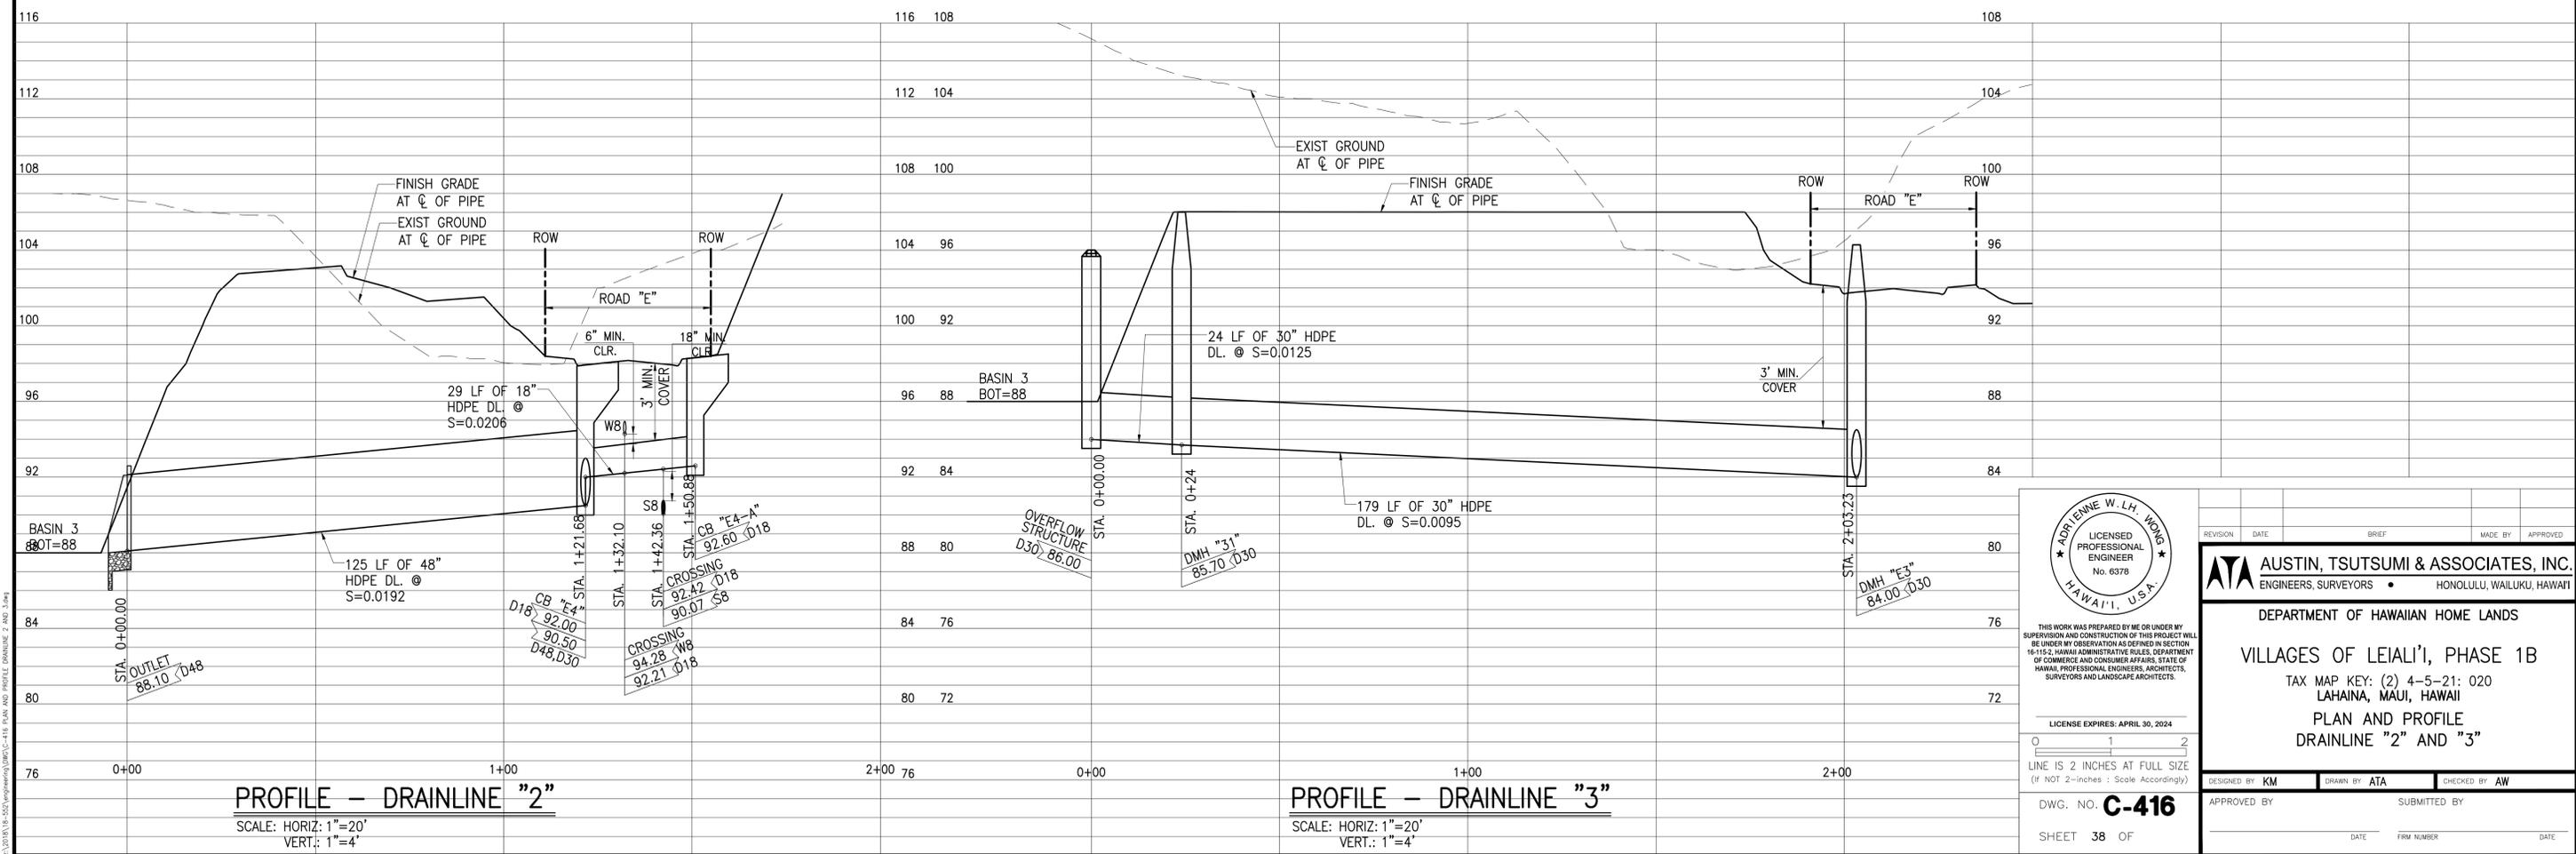

THIS WORK WAS PREPARED BY ME OR UNDER MY SUPERVISION AND CONSTRUCTION OF THIS PROJECT WILL BE UNDER MY OBSERVATION AS DEFINED IN SECTION 16-115-2, HAWAII ADMINISTRATIVE RULES, DEPARTMENT OF COMMERCE AND CONSUMER AFFAIRS, STATE OF HAWAII, PROFESSIONAL ENGINEERS, ARCHITECTS, SURVEYORS AND LANDSCAPE ARCHITECTS.


LICENSE EXPIRES: APRIL 30, 2024

LINE IS 2 INCHES AT FULL SIZE (IF NOT 2-INCHES: SCALE ACCORDINGLY)


DWG. NO. **C-416**

SHEET 38 OF


| | | | | |
|------------------------------------------------------------------------------------------------------------------------------------------------------------------------------------------------|------|--------------|-------------|------------|
| REVISION | DATE | BRIEF | MADE BY | APPROVED |
| ATA AUSTIN, TSUTSUMI & ASSOCIATES, INC. ENGINEERS, SURVEYORS • HONOLULU, WAILUKU, HAWAII | | | | |
| DEPARTMENT OF HAWAIIAN HOME LANDS VILLAGES OF LEIALI'I, PHASE 1B TAX MAP KEY: (2) 4-5-21: 020 LAHAINA, MAUI, HAWAII PLAN AND PROFILE DRAINLINE "2" AND "3" | | | | |
| DESIGNED BY | DATE | DRAWN BY | FIRM NUMBER | CHECKED BY |
| APPROVED BY | DATE | SUBMITTED BY | FIRM NUMBER | DATE |

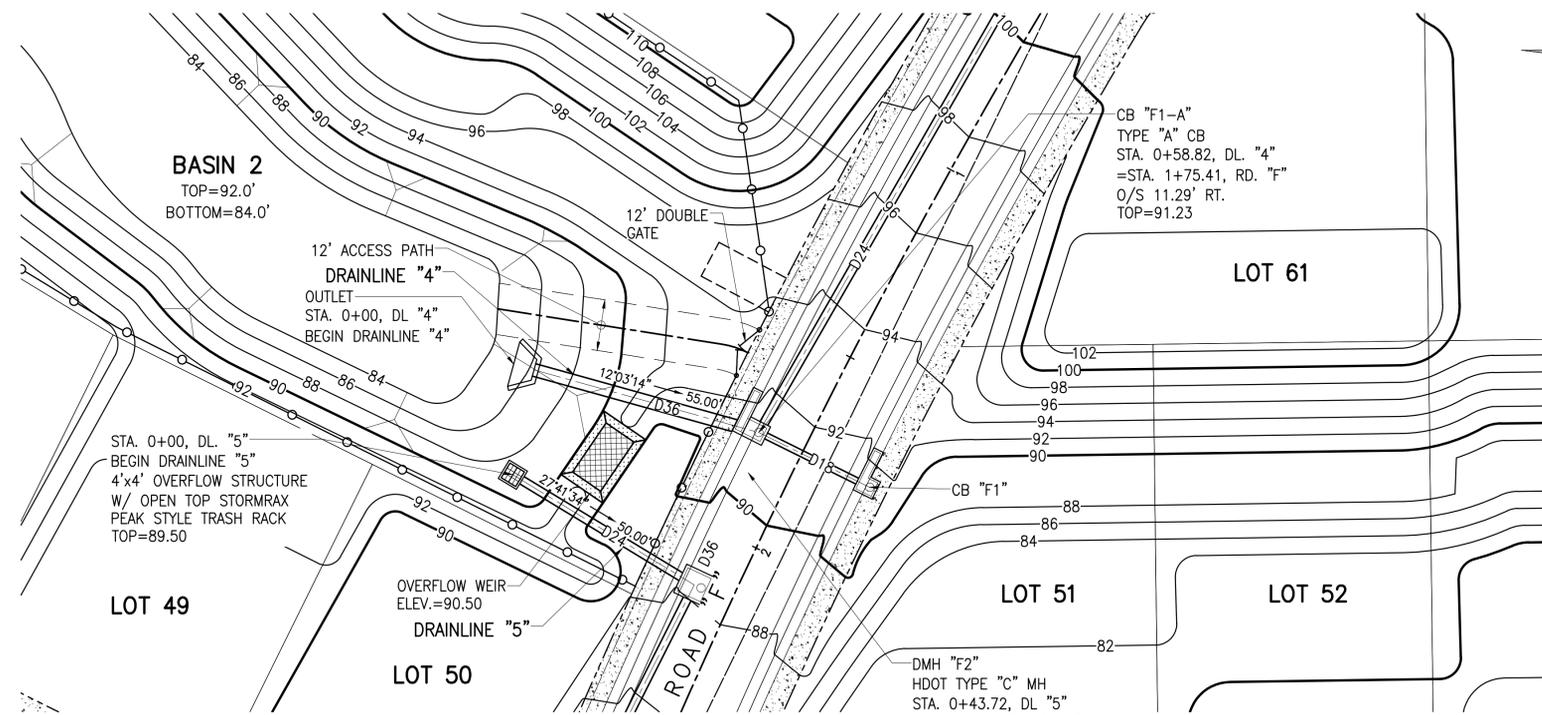


PLAN - DRAINLINE "4" & "5"
SCALE: 1"=20'

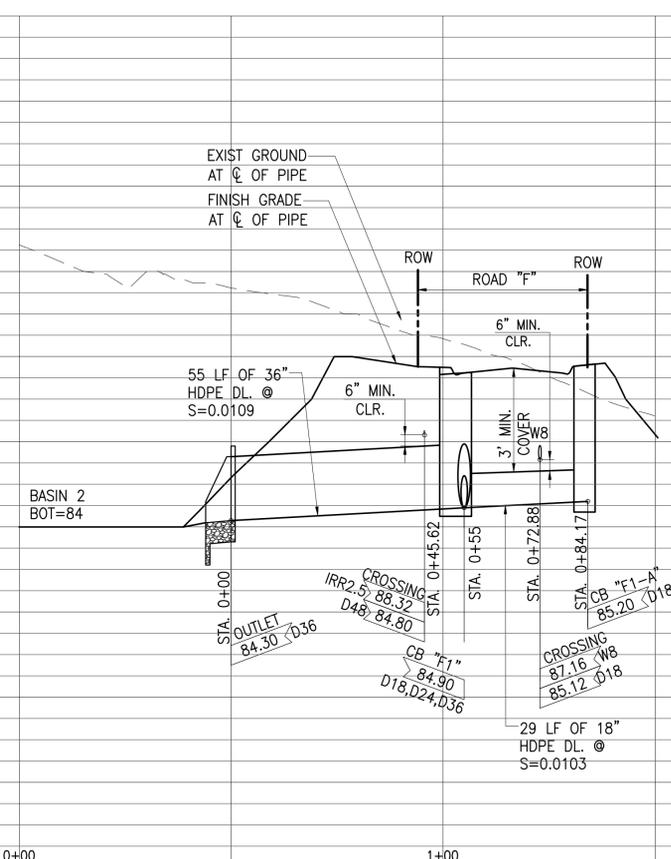

PROFILE - DRAINLINE "4"
SCALE: HORIZ: 1"=20'
VERT.: 1"=4'

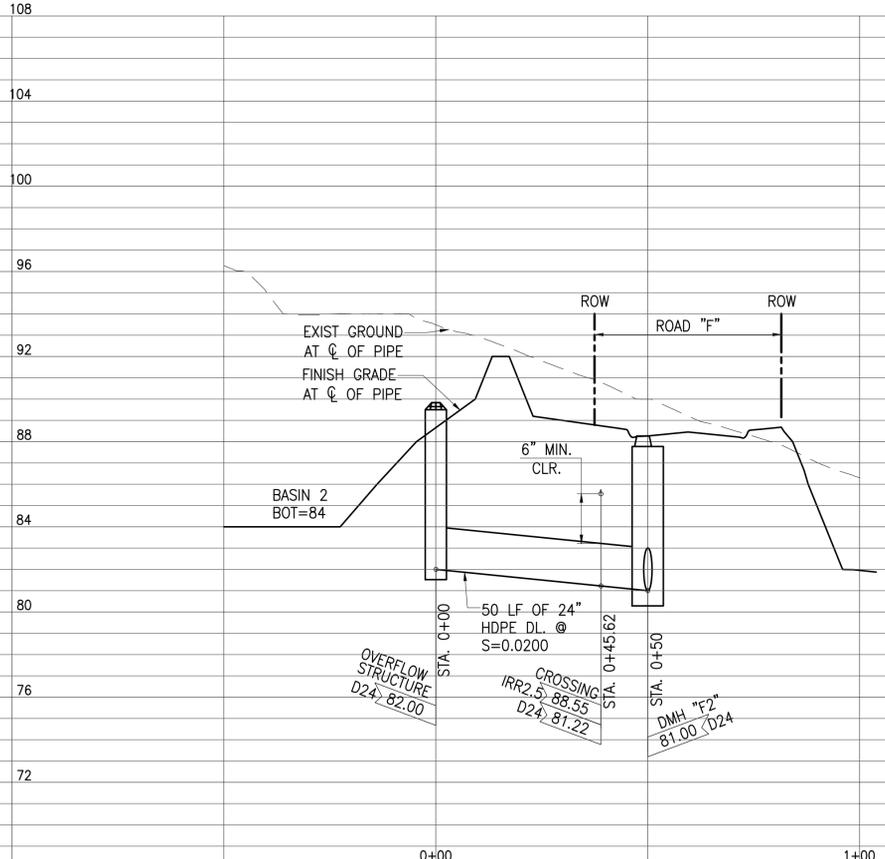

PROFILE - DRAINLINE "5"
SCALE: HORIZ: 1"=20'
VERT.: 1"=4'

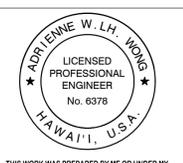

THIS WORK WAS PREPARED BY ME OR UNDER MY SUPERVISION AND CONSTRUCTION OF THIS PROJECT WILL BE UNDER MY OBSERVATION AS DEFINED IN SECTION 16-115-2, HAWAII ADMINISTRATIVE RULES, DEPARTMENT OF COMMERCE AND CONSUMER AFFAIRS, STATE OF HAWAII, PROFESSIONAL ENGINEERS, ARCHITECTS, SURVEYORS AND LANDSCAPE ARCHITECTS.

LICENSE EXPIRES: APRIL 30, 2024


0 1 2
LINE IS 2 INCHES AT FULL SIZE
(IF NOT 2-INCHES : Scale Accordingly)

DWG. NO. **C-417**

SHEET 39 OF


| | | | | |
|------------------------------------------------------------------------------------------------------------------------------------------------------------------------------------------------|---------------------|----------------------|--------------------------------------|----------|
| REVISION | DATE | BRIEF | MADE BY | APPROVED |
| ATA AUSTIN, TSUTSUMI & ASSOCIATES, INC. ENGINEERS, SURVEYORS • HONOLULU, WAILUKU, HAWAII | | | | |
| DEPARTMENT OF HAWAIIAN HOME LANDS VILLAGES OF LEIALI'I, PHASE 1B TAX MAP KEY: (2) 4-5-21: 020 LAHAINA, MAUI, HAWAII PLAN AND PROFILE DRAINLINE "4" AND "5" | | | | |
| DESIGNED BY KM | DRAWN BY ATA | CHECKED BY AW | APPROVED BY _____ SUBMITTED BY _____ | |
| DATE _____ | FIRM NUMBER _____ | DATE _____ | DATE _____ | |

A:\2023\18-522\DWG\C-417.DWG AND REVISIONS.DWG, J AND S.dwg

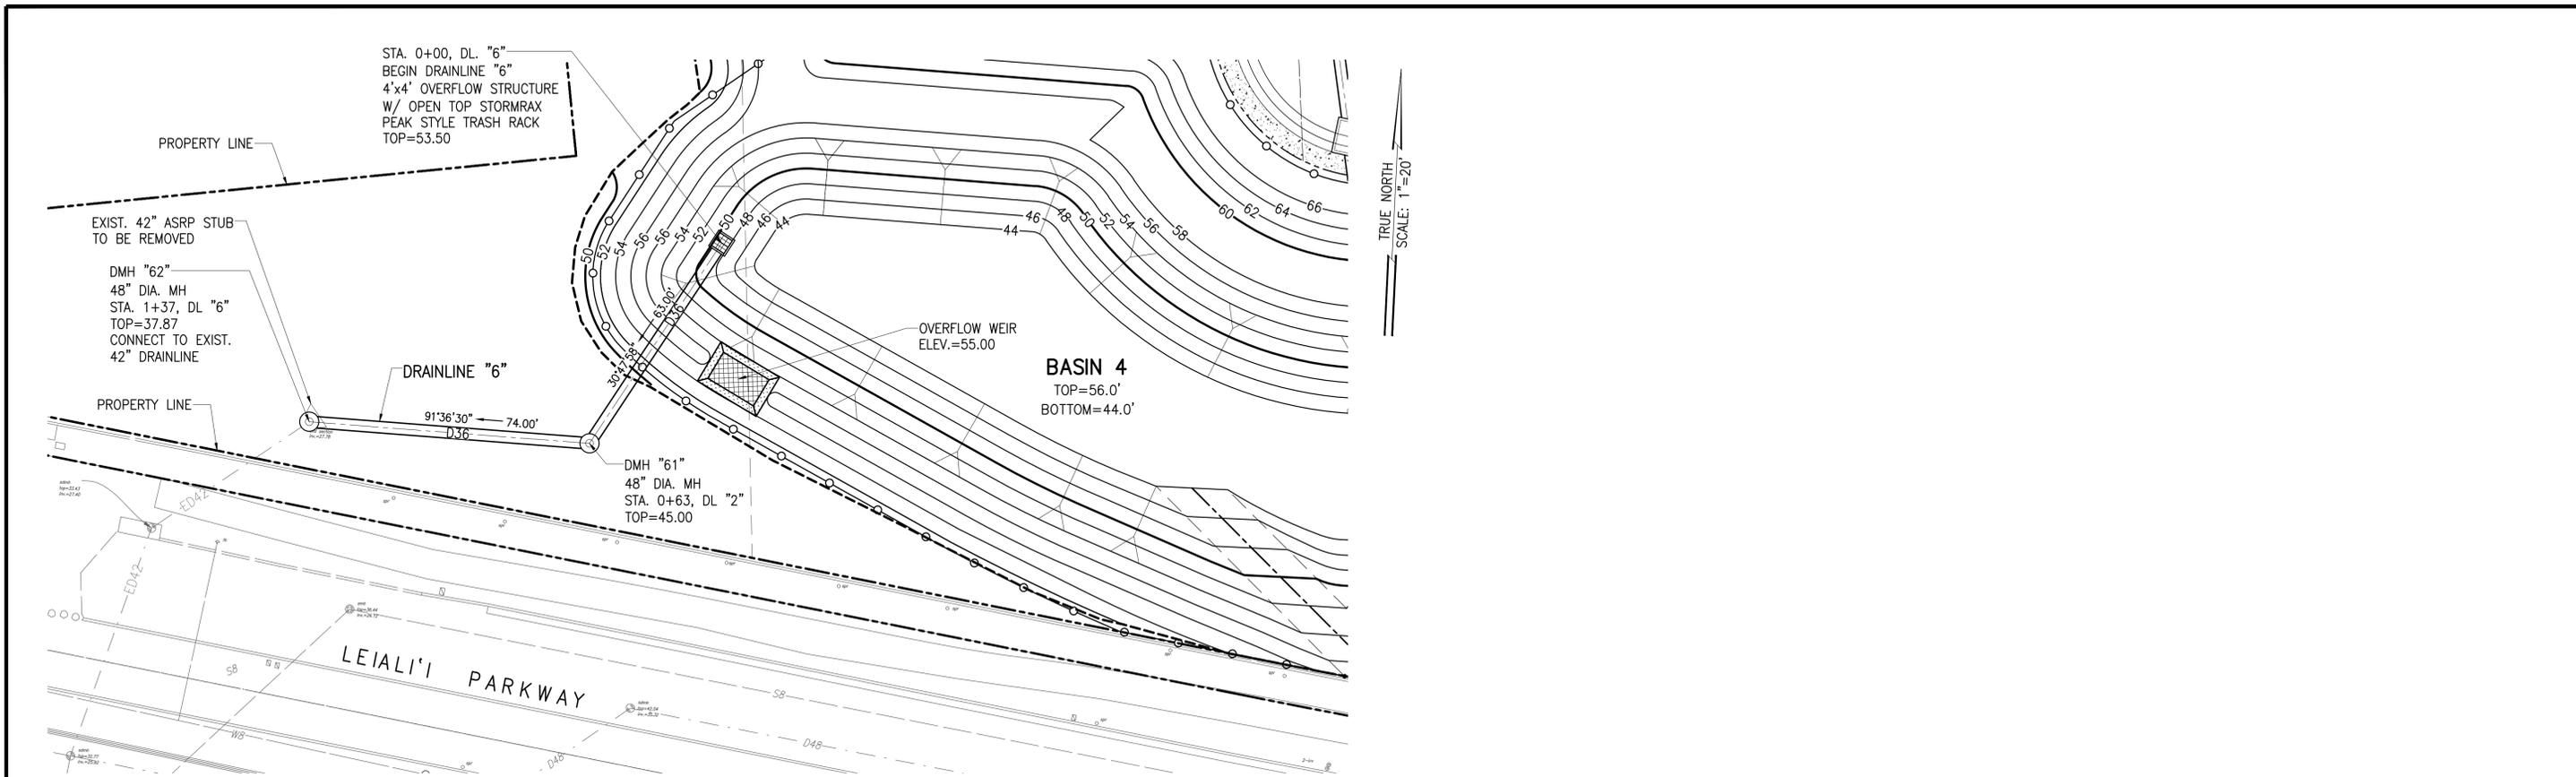

PLAN - DRAINLINE "6"

SCALE: 1"=20'

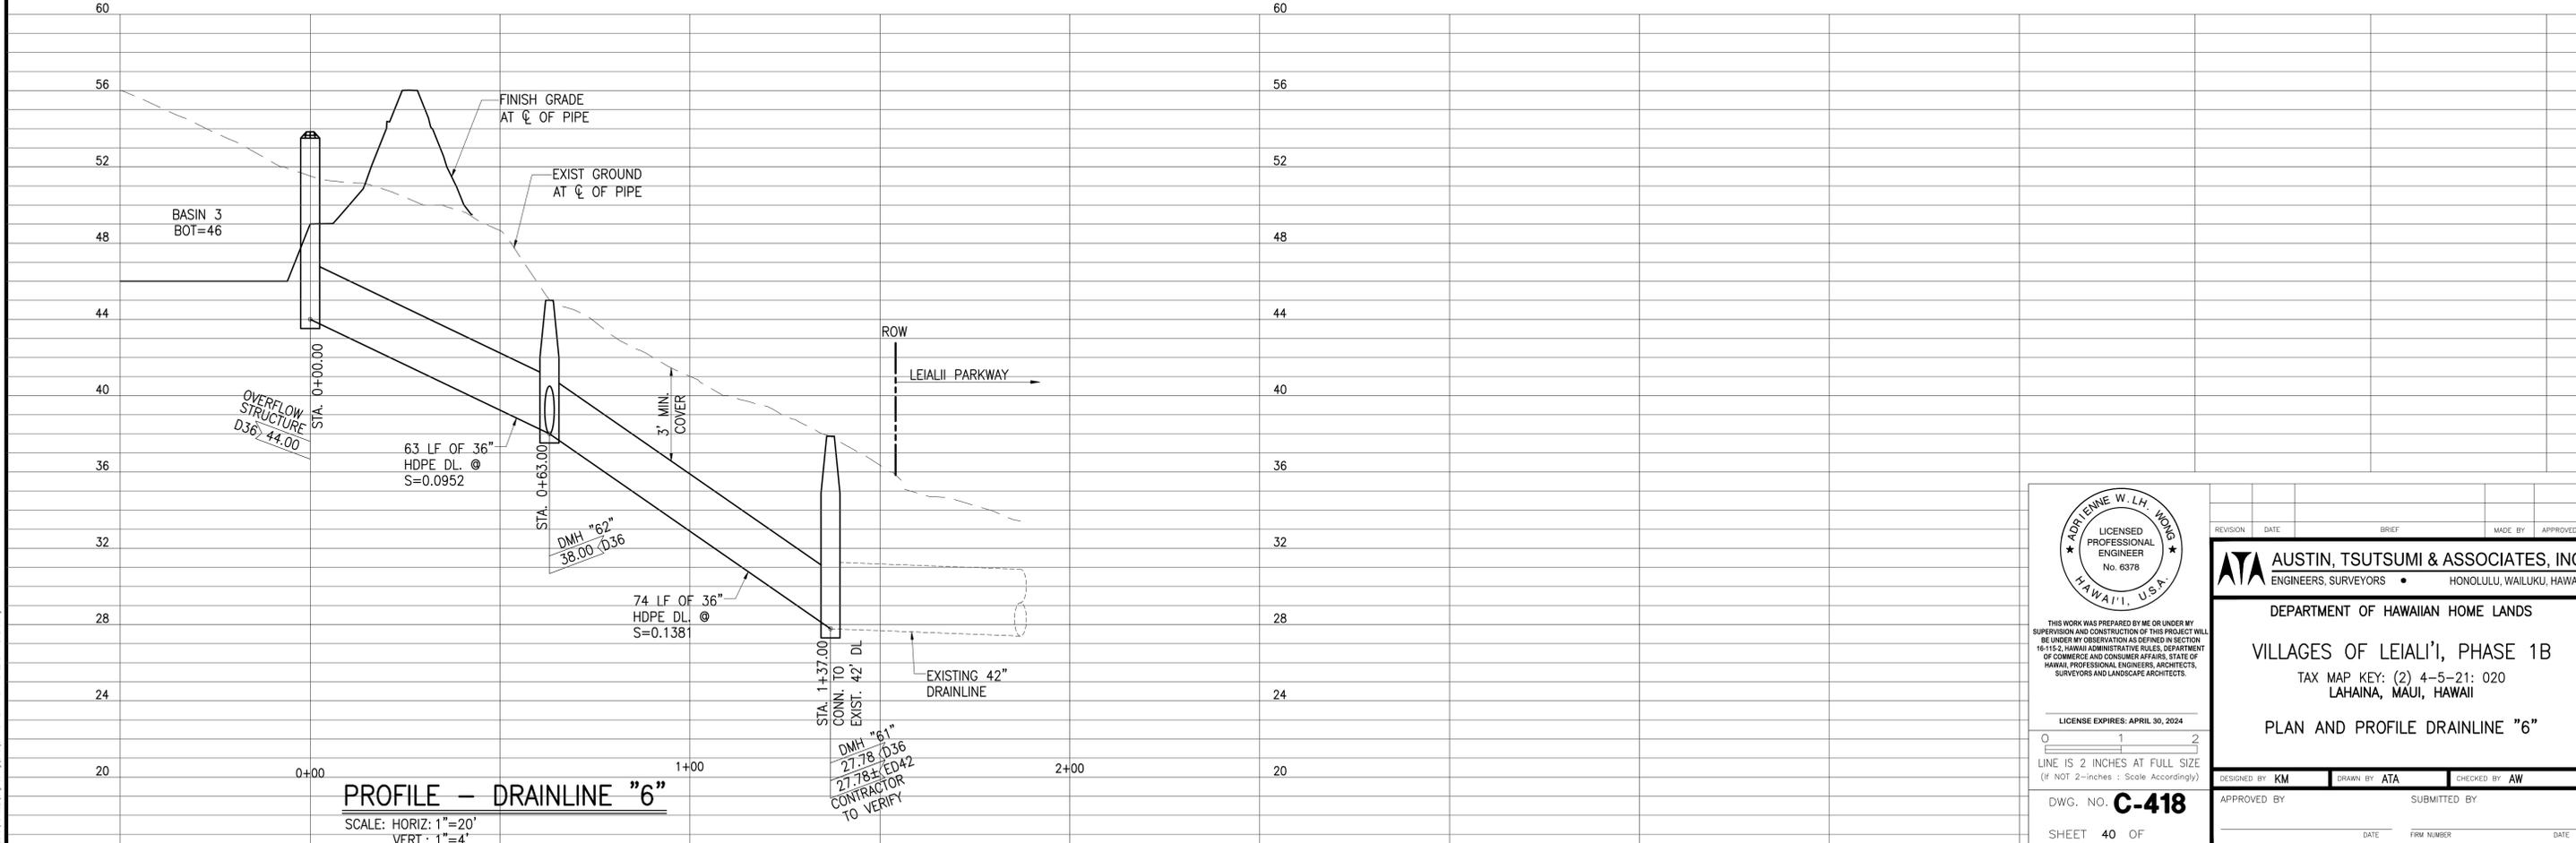

PROFILE - DRAINLINE "6"

SCALE: HORIZ: 1"=20'
VERT.: 1"=4'



THIS WORK WAS PREPARED BY ME OR UNDER MY SUPERVISION AND CONSTRUCTION OF THIS PROJECT WILL BE UNDER MY OBSERVATION AS DEFINED IN SECTION 16-115-2, HAWAII ADMINISTRATIVE RULES, DEPARTMENT OF COMMERCE AND CONSUMER AFFAIRS, STATE OF HAWAII, PROFESSIONAL ENGINEERS, ARCHITECTS, SURVEYORS AND LANDSCAPE ARCHITECTS.

LICENSE EXPIRES: APRIL 30, 2024


0 1 2

LINE IS 2 INCHES AT FULL SIZE
(IF NOT 2-INCHES : SCALE ACCORDINGLY)

DWG. NO. **C-418**


SHEET 40 OF

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|------------------------------------------------------------------------------------------------------------------------------------------------------------------------------|------|--------------|---------|------------|
| REVISION | DATE | BRIEF | MADE BY | APPROVED |
| AUSTIN, TSUTSUMI & ASSOCIATES, INC. ENGINEERS, SURVEYORS • HONOLULU, WAILUKU, HAWAII | | | | |
| DEPARTMENT OF HAWAIIAN HOME LANDS VILLAGES OF LEIALII', PHASE 1B TAX MAP KEY: (2) 4-5-21: 020 LAHAINA, MAUI, HAWAII PLAN AND PROFILE DRAINLINE "6" | | | | |
| DESIGNED BY | KM | DRAWN BY | ATA | CHECKED BY |
| APPROVED BY | | SUBMITTED BY | AW | |
| DATE | | FIRM NUMBER | | DATE |

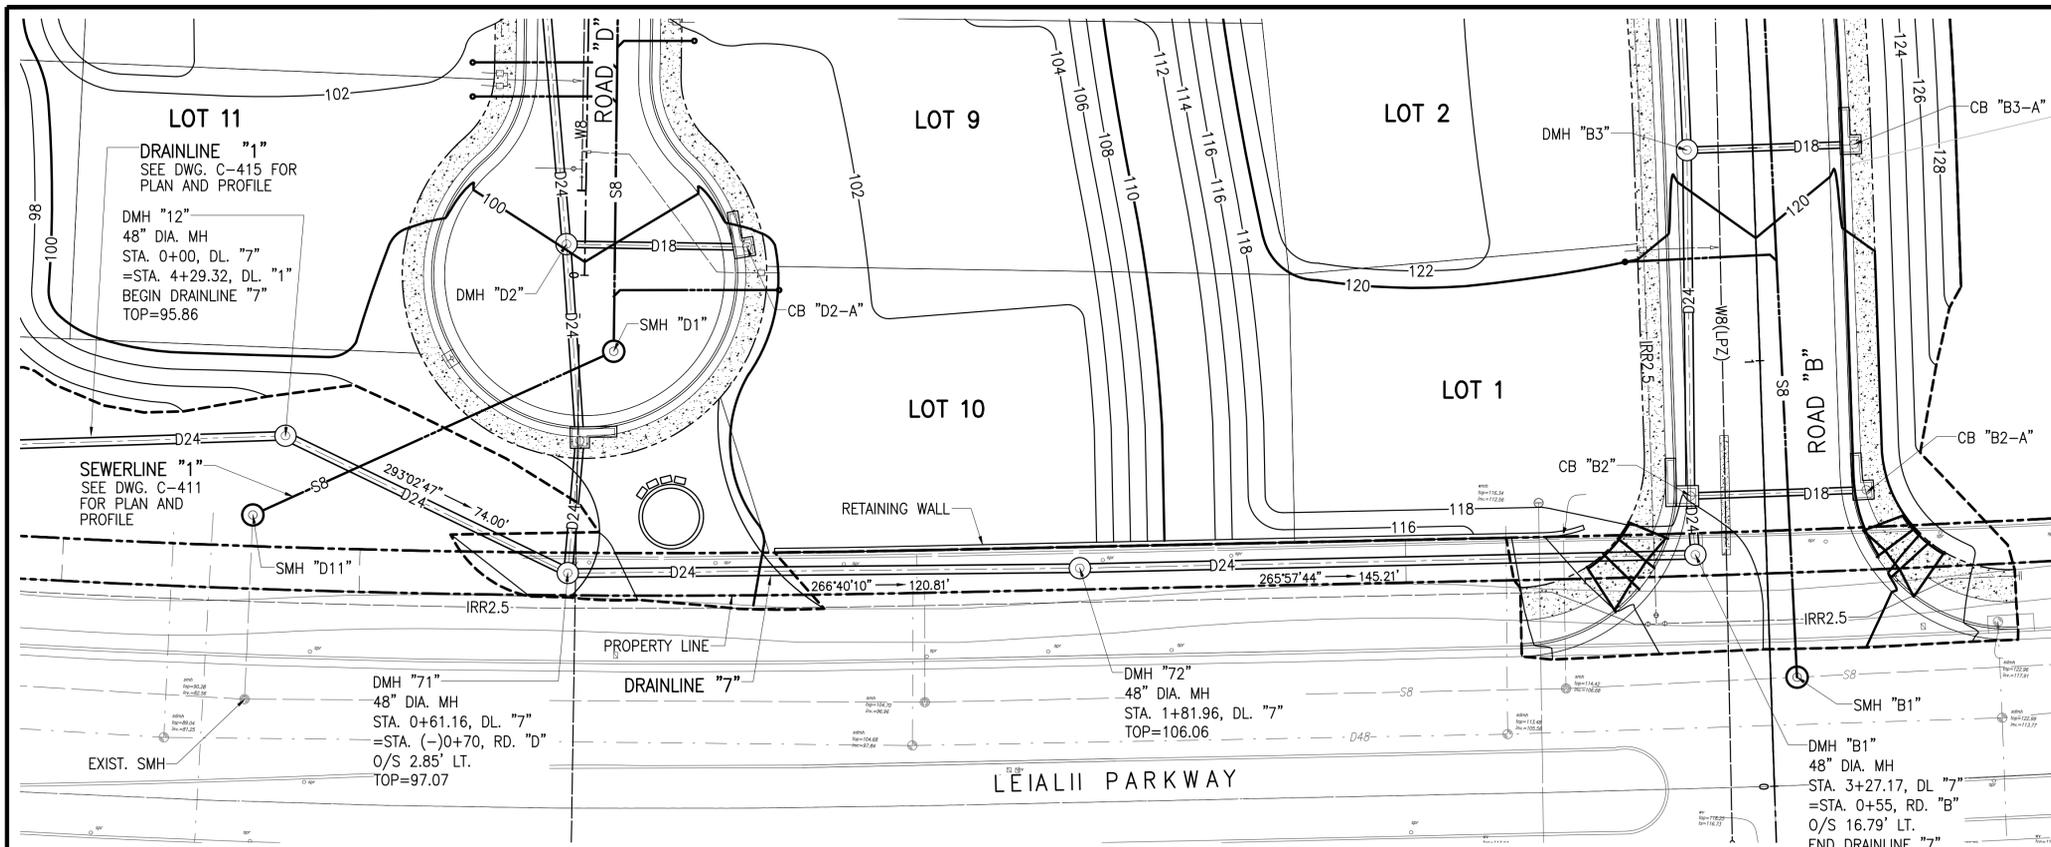

TRUE NORTH
SCALE: 1"=20'

PLAN - DRAINLINE "7"
SCALE: 1"=20'

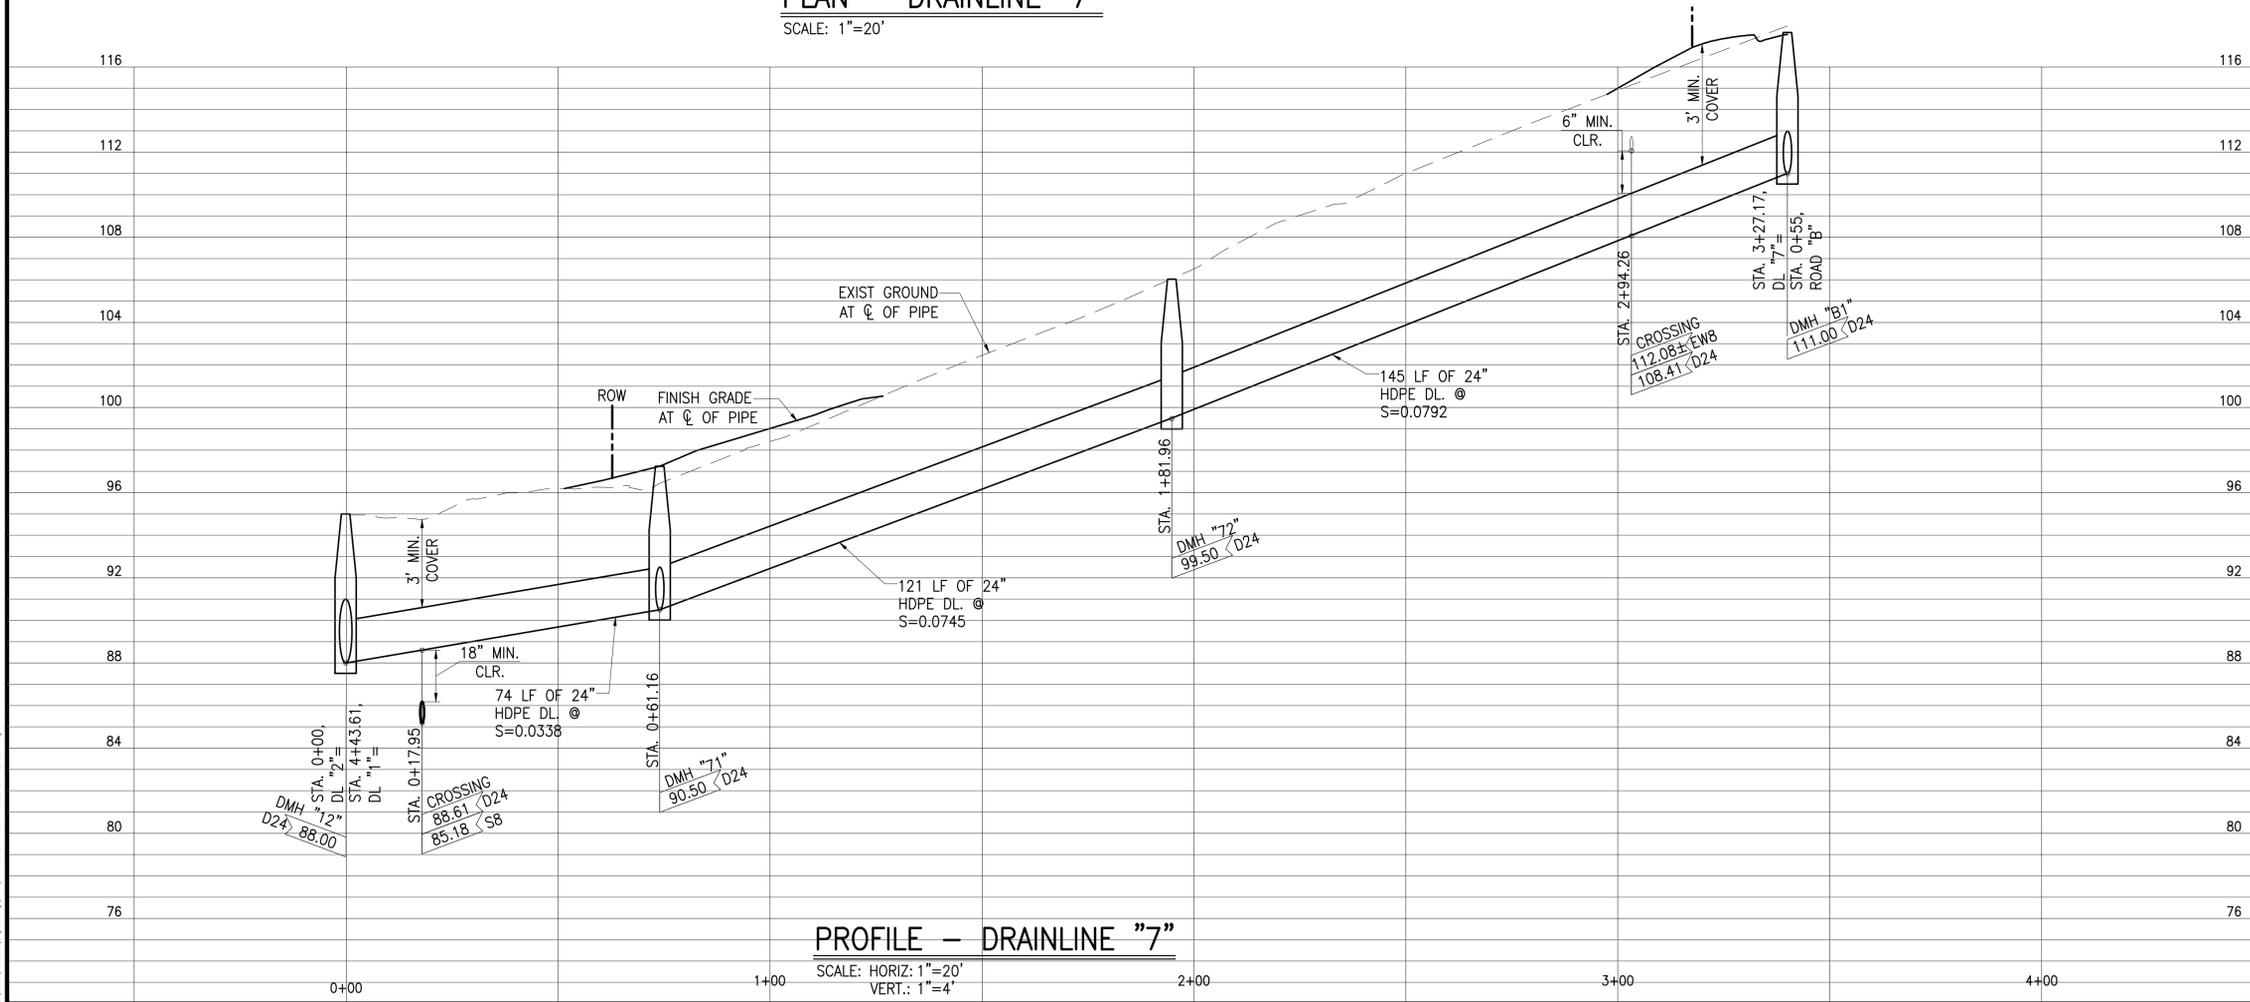

PROFILE - DRAINLINE "7"
SCALE: HORIZ: 1"=20'
VERT.: 1"=4'




THIS WORK WAS PREPARED BY ME OR UNDER MY SUPERVISION AND CONSTRUCTION OF THIS PROJECT WILL BE UNDER MY OBSERVATION AS DEFINED IN SECTION 16-115-2, HAWAII ADMINISTRATIVE RULES, DEPARTMENT OF COMMERCE AND CONSUMER AFFAIRS, STATE OF HAWAII, PROFESSIONAL ENGINEERS, ARCHITECTS, SURVEYORS AND LANDSCAPE ARCHITECTS.

LICENSE EXPIRES: APRIL 30, 2024

0 1 2
LINE IS 2 INCHES AT FULL SIZE
(IF NOT 2-INCHES : SCALE ACCORDINGLY)


DWG. NO. **C-419**
SHEET 41 OF

| REVISION | DATE | BRIEF | MADE BY | APPROVED |
|------------------------------------------------------------------------------------------------------------------------------------------------------------------------------|------|--------------|---------|------------|
| ATA AUSTIN, TSUTSUMI & ASSOCIATES, INC. ENGINEERS, SURVEYORS • HONOLULU, WAILUKU, HAWAII | | | | |
| DEPARTMENT OF HAWAIIAN HOME LANDS VILLAGES OF LEIALI'I, PHASE 1B TAX MAP KEY: (2) 4-5-21: 020 LAHAINA, MAUI, HAWAII PLAN AND PROFILE DRAINLINE "7" | | | | |
| DESIGNED BY | KM | DRAWN BY | ATA | CHECKED BY |
| APPROVED BY | | SUBMITTED BY | AW | |
| DATE | | FIRM NUMBER | | DATE |

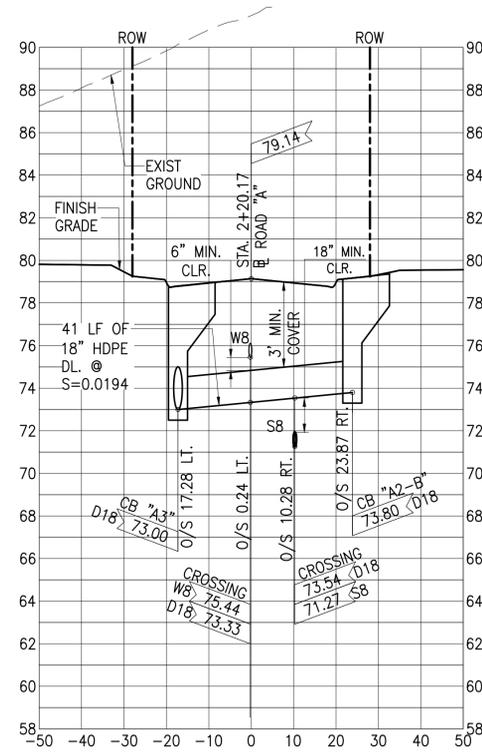


DRAIN CROSSING "A2" - STA. 2+20.17 ROAD "A"

SCALE: HORIZ: 1"=20'
VERT.: 1"=4'

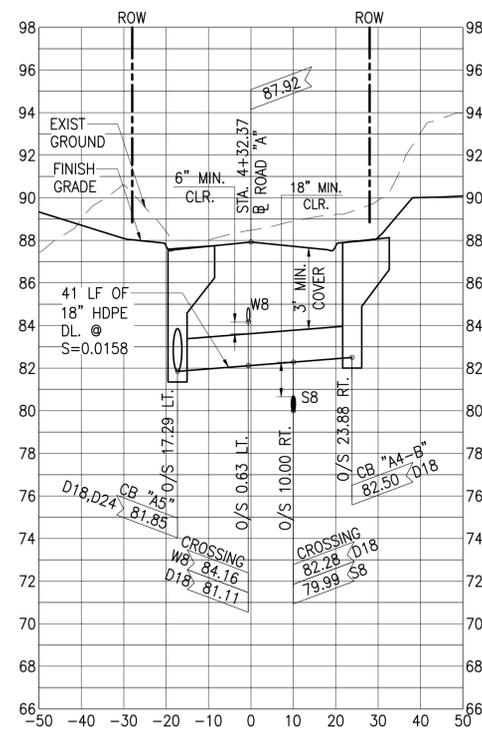


DRAIN CROSSING "A4" - STA. 4+32.37 ROAD "A"

SCALE: HORIZ: 1"=20'
VERT.: 1"=4'

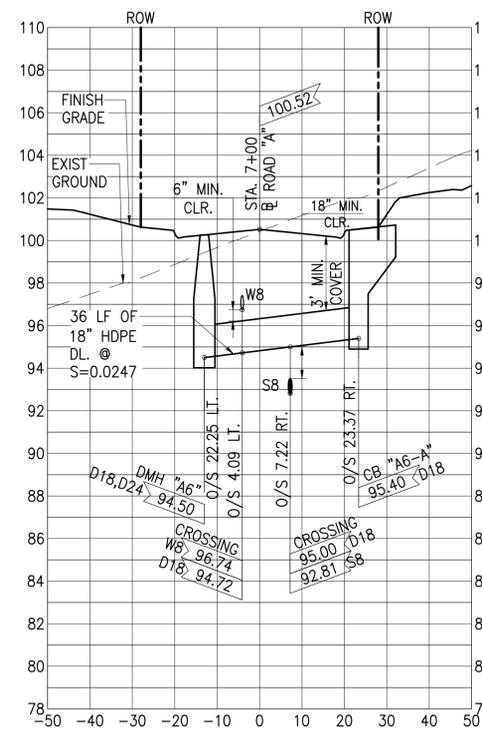


DRAIN CROSSING "A5" - STA. 7+00 ROAD "A"

SCALE: HORIZ: 1"=20'
VERT.: 1"=4'

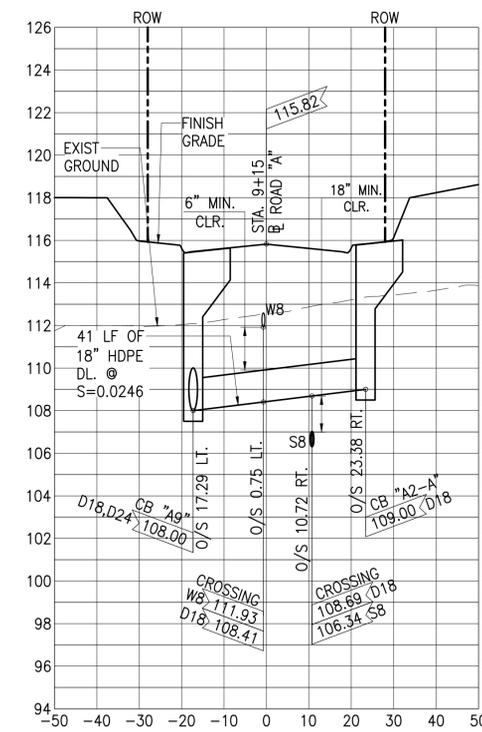


DRAIN CROSSING "A8" - STA. 9+15 ROAD "A"

SCALE: HORIZ: 1"=20'
VERT.: 1"=4'

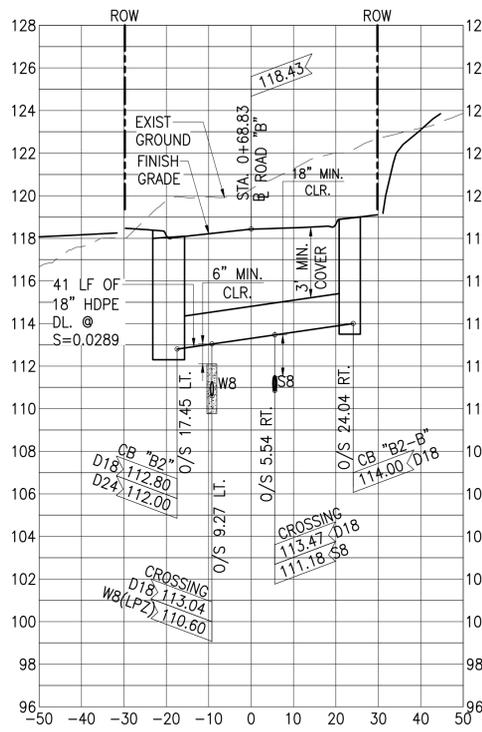


DRAIN CROSSING "B2" - STA. 0+68.58 ROAD "B"

SCALE: HORIZ: 1"=20'
VERT.: 1"=4'

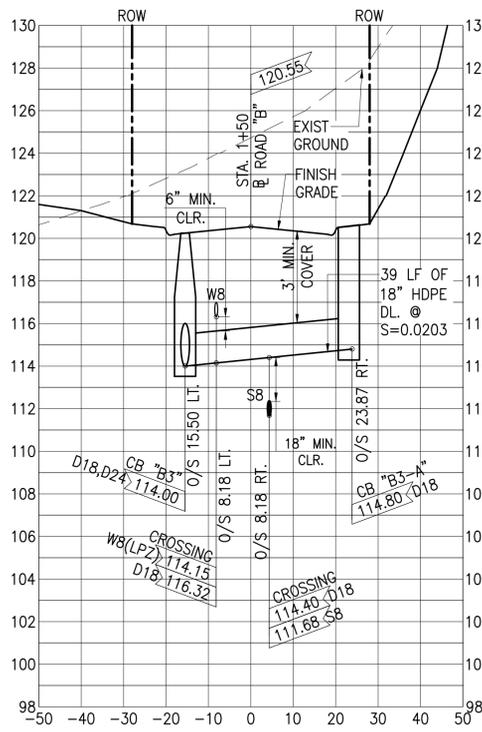


DRAIN CROSSING "B3" - STA. 1+50 ROAD "B"

SCALE: HORIZ: 1"=20'
VERT.: 1"=4'

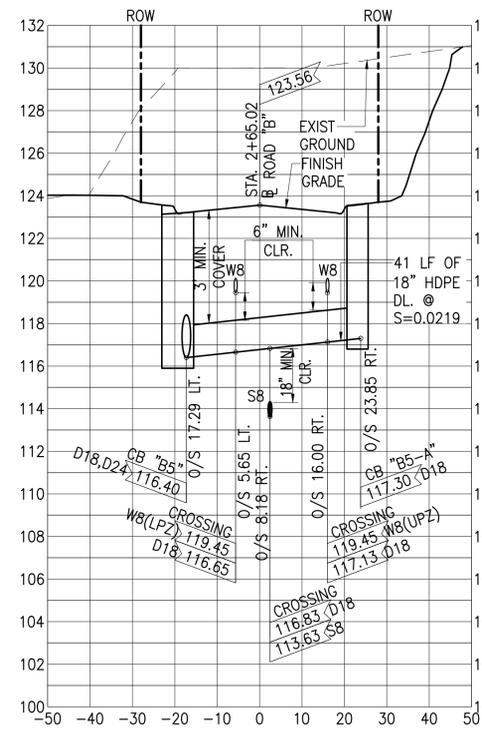

DRAIN CROSSING "B5" - STA. 2+65.02 ROAD "B"

SCALE: HORIZ: 1"=20'
VERT.: 1"=4'

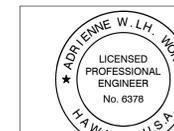

THIS WORK WAS PREPARED BY ME OR UNDER MY SUPERVISION AND CONSTRUCTION OF THIS PROJECT WILL BE UNDER MY OBSERVATION AS DEFINED IN SECTION 16-115-2, HAWAII ADMINISTRATIVE RULES, DEPARTMENT OF COMMERCE AND CONSUMER AFFAIRS, STATE OF HAWAII, PROFESSIONAL ENGINEERS, ARCHITECTS, SURVEYORS AND LANDSCAPE ARCHITECTS.


LICENSE EXPIRES: APRIL 30, 2024
0 1 2
LINE IS 2 INCHES AT FULL SIZE
(IF NOT 2-INCHES : SCALE ACCORDINGLY)

DWG. NO. **C-421**

SHEET 43 OF


| REVISION | DATE | BRIEF | MADE BY | APPROVED |
|--------------------------------------------------------------------------------------------------------------------------------------------------------------------------------------------------------------------------------------------------------------------------------|--------------|---------------|--------------|----------------|
| ATA AUSTIN, TSUTSUMI & ASSOCIATES, INC. ENGINEERS, SURVEYORS • HONOLULU, WAILUKU, HAWAII DEPARTMENT OF HAWAIIAN HOME LANDS VILLAGES OF LEIALI'I, PHASE 1B TAX MAP KEY: (2) 4-5-21: 020 LAHAINA, MAUI, HAWAII DRAIN CROSSING - 1 | | | | |
| DESIGNED BY: KM | | DRAWN BY: ATA | | CHECKED BY: AW |
| APPROVED BY: | | SUBMITTED BY: | | |
| DATE: | FILE NUMBER: | DATE: | FILE NUMBER: | DATE: |

DATE: SEPTEMBER 2023

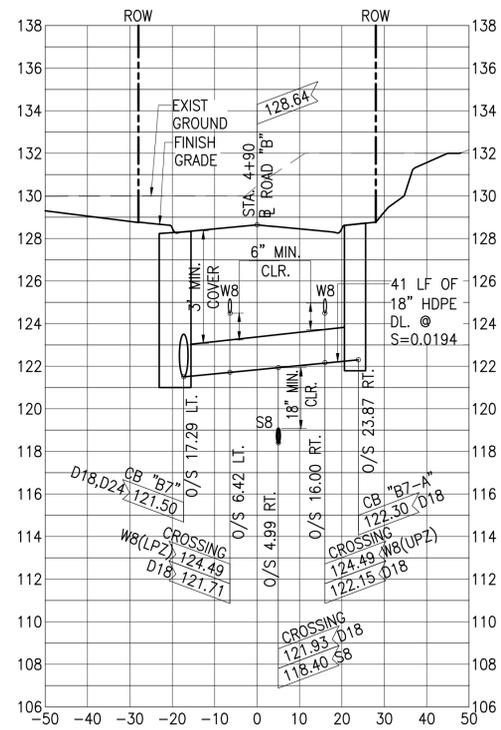


DRAIN CROSSING "B7" - STA. 4+90 ROAD "B"

SCALE: HORIZ: 1"=20'
VERT.: 1"=4'

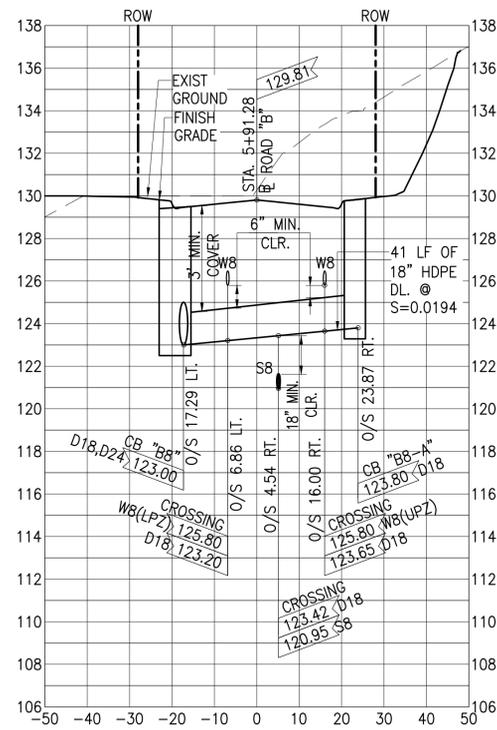


DRAIN CROSSING "B8" - STA. 5+91.28 ROAD "B"

SCALE: HORIZ: 1"=20'
VERT.: 1"=4'

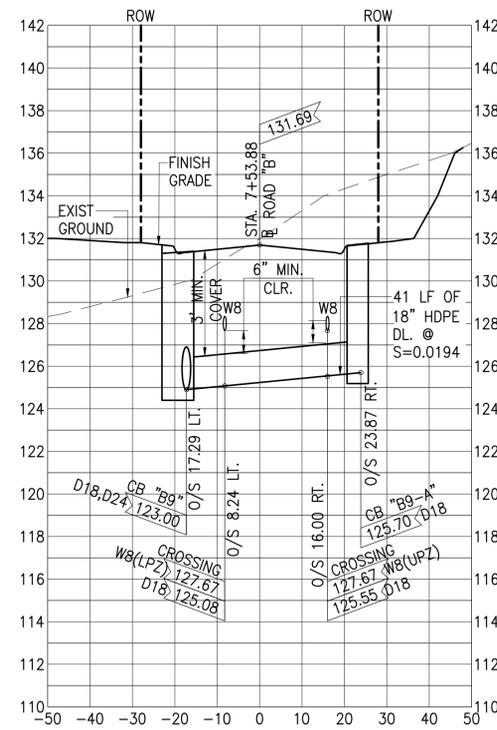


DRAIN CROSSING "B9" - STA. 7+53.88 ROAD "B"

SCALE: HORIZ: 1"=20'
VERT.: 1"=4'

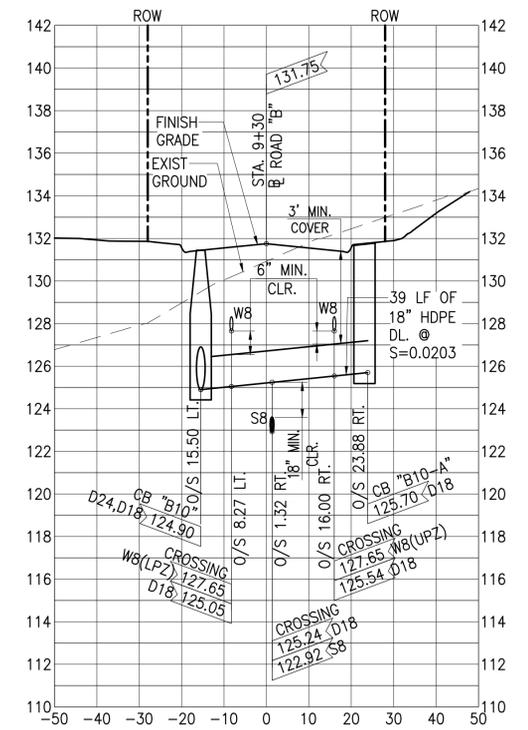


DRAIN CROSSING "B10" - STA. 9+30 ROAD "B"

SCALE: HORIZ: 1"=20'
VERT.: 1"=4'

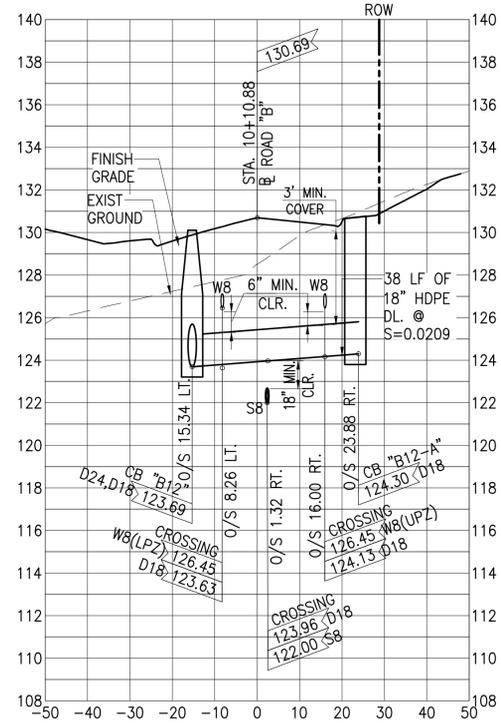


DRAIN CROSSING "B12" - STA. 10+22.60 ROAD "B"

SCALE: HORIZ: 1"=20'
VERT.: 1"=4'

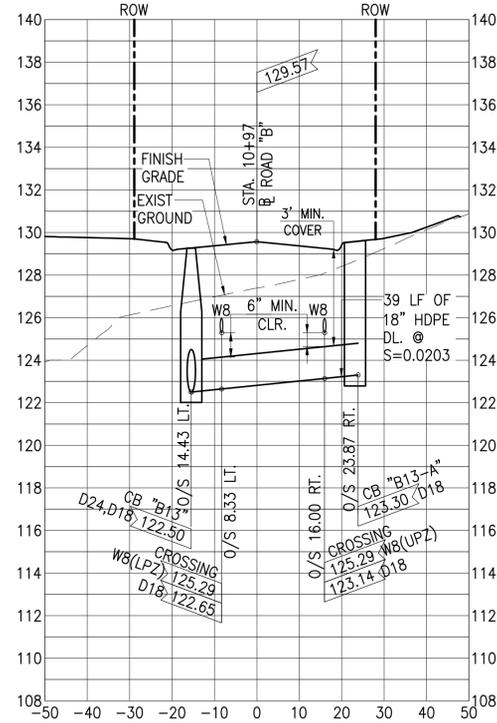


DRAIN CROSSING "B13" - STA. 10+97 ROAD "B"

SCALE: HORIZ: 1"=20'
VERT.: 1"=4'

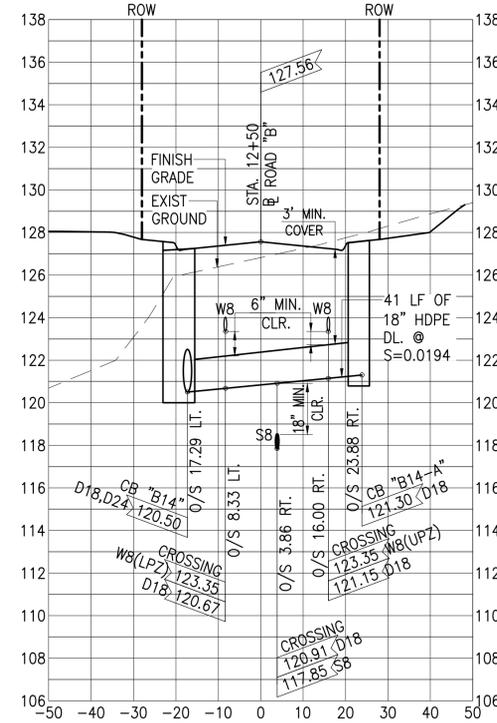

DRAIN CROSSING "B14" - STA. 12+50 ROAD "B"

SCALE: HORIZ: 1"=20'
VERT.: 1"=4'

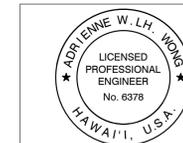

THIS WORK WAS PREPARED BY ME OR UNDER MY SUPERVISION AND CONSTRUCTION OF THIS PROJECT WILL BE UNDER MY OBSERVATION AS DEFINED IN SECTION 16-115-2, HAWAII ADMINISTRATIVE RULES, DEPARTMENT OF COMMERCE AND CONSUMER AFFAIRS, STATE OF HAWAII, PROFESSIONAL ENGINEERS, ARCHITECTS, SURVEYORS AND LANDSCAPE ARCHITECTS.

LICENSE EXPIRES: APRIL 30, 2024
LINE IS 2 INCHES AT FULL SIZE
(IF NOT 2-INCHES : SCALE ACCORDINGLY)


DWG. NO. **C-422**
SHEET 45 OF

| REVISION | DATE | BRIEF | MADE BY | APPROVED |
|----------------------------------------------------------------------------------------------------------------------------------------------------------------------------------------------------------------------------------------------------------------------------|------|---------------|---------|----------------|
| ATA AUSTIN, TSUTSUMI & ASSOCIATES, INC. ENGINEERS, SURVEYORS • HONOLULU, WAILUKU, HAWAII DEPARTMENT OF HAWAIIAN HOME LANDS VILLAGES OF LEIALI'I, PHASE 1B TAX MAP KEY: (2) 4-5-21: 020 LAHAINA, MAUI, HAWAII DRAIN CROSSING - 2 | | | | |
| DESIGNED BY: KM | | DRAWN BY: ATA | | CHECKED BY: AW |
| APPROVED BY: | | SUBMITTED BY: | | |
| DATE: | | FIRM NUMBER: | | DATE: |

DATE: SEPTEMBER 2023


| FILE | POCKET | FOLDER | NO. |
|------|--------|--------|-----|
| | | | |

A:\2018\18-522\DWG\C-422 DRAIN CROSSING - 2.dwg

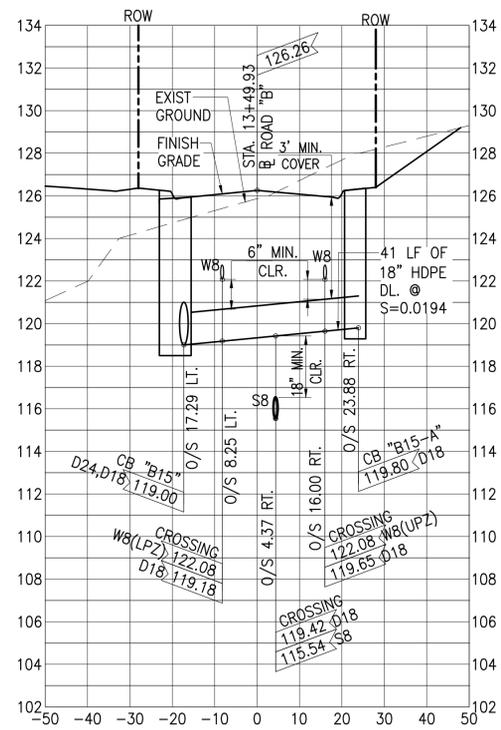


DRAIN CROSSING "B15" - STA. 13+49.93 ROAD "B"

SCALE: HORIZ: 1"=20'
VERT.: 1"=4'

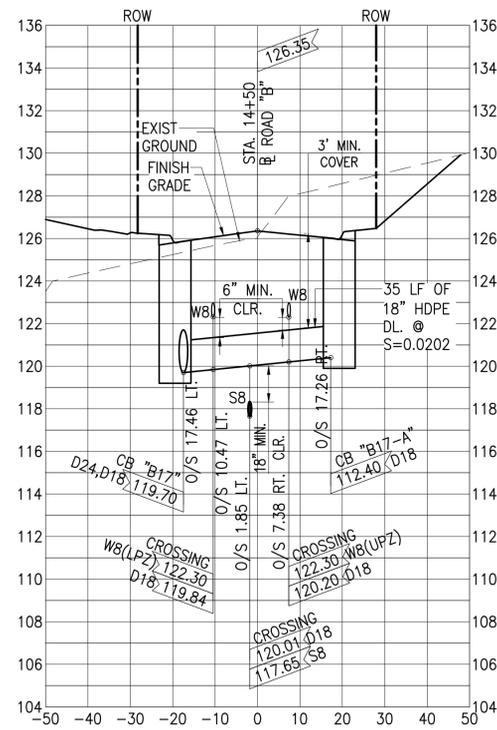


DRAIN CROSSING "B17" - STA. 14+50 ROAD "B"

SCALE: HORIZ: 1"=20'
VERT.: 1"=4'

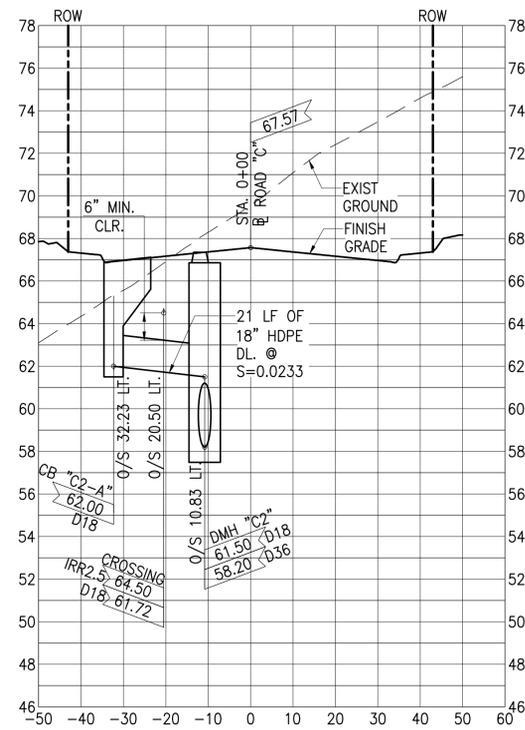


DRAIN CROSSING "C2" - STA. 0+00 ROAD "C"

SCALE: HORIZ: 1"=20'
VERT.: 1"=4'

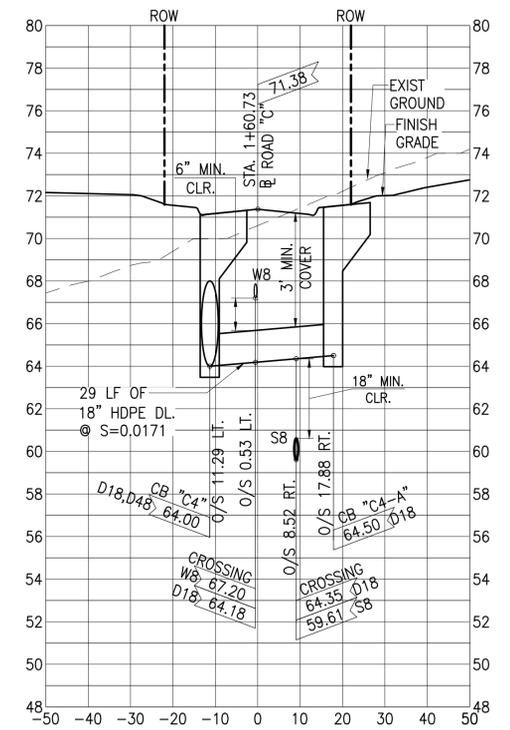


DRAIN CROSSING "C4" - STA. 1+60.73 ROAD "C"

SCALE: HORIZ: 1"=20'
VERT.: 1"=4'

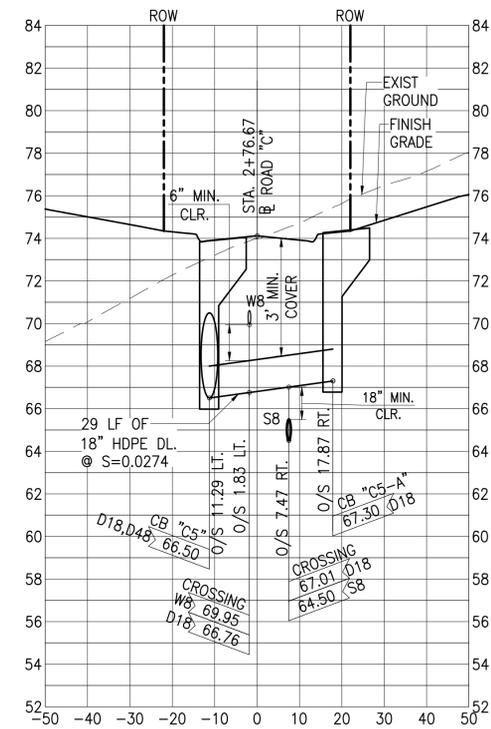


DRAIN CROSSING "C5" - STA. 2+76.67 ROAD "C"

SCALE: HORIZ: 1"=20'
VERT.: 1"=4'

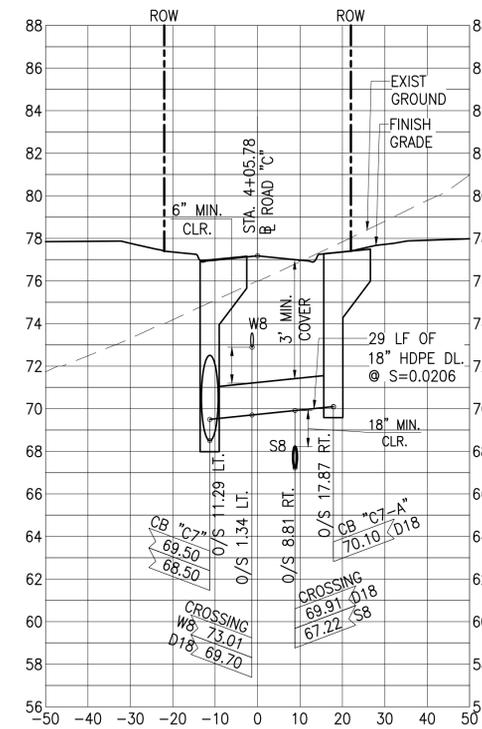

DRAIN CROSSING "C7" - STA. 4+05.78 ROAD "C"

SCALE: HORIZ: 1"=20'
VERT.: 1"=4'

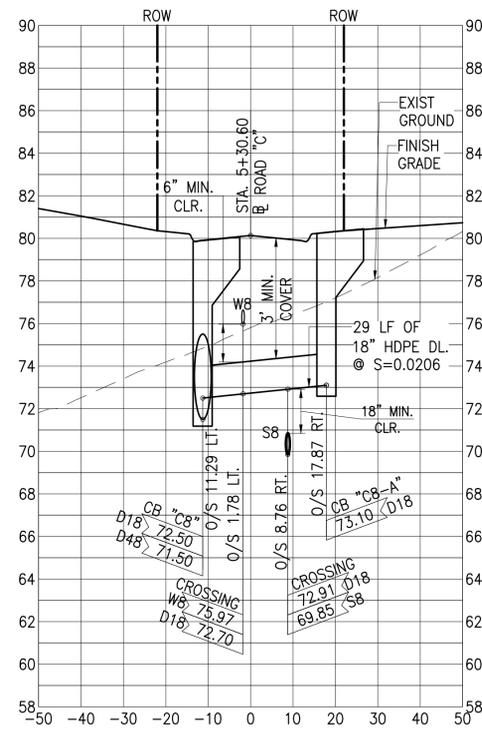

DRAIN CROSSING "C8" - STA. 5+30.60 ROAD "C"

SCALE: HORIZ: 1"=20'
VERT.: 1"=4'



THIS WORK WAS PREPARED BY ME OR UNDER MY SUPERVISION AND CONSTRUCTION OF THIS PROJECT WILL BE UNDER MY OBSERVATION AS DEFINED IN SECTION 16-115-2, HAWAII ADMINISTRATIVE RULES, DEPARTMENT OF COMMERCE AND CONSUMER AFFAIRS, STATE OF HAWAII, PROFESSIONAL ENGINEERS, ARCHITECTS, SURVEYORS AND LANDSCAPE ARCHITECTS.

LICENSE EXPIRES: APRIL 30, 2024

0 1 2

LINE IS 2 INCHES AT FULL SIZE

(IF NOT 2-INCHES : SCALE ACCORDINGLY)


DWG. NO. **C-423**

SHEET 46 OF

| REVISION | DATE | BRIEF | MADE BY | APPROVED |
|--------------------------------------------------------------------------------------------------------------------------------------------------------------------------------------------------------------------------------------------------------------------------------|--------------|---------------|---------|----------------|
| ATA AUSTIN, TSUTSUMI & ASSOCIATES, INC. ENGINEERS, SURVEYORS • HONOLULU, WAILUKU, HAWAII DEPARTMENT OF HAWAIIAN HOME LANDS VILLAGES OF LEIALI'I, PHASE 1B TAX MAP KEY: (2) 4-5-21: 020 LAHAINA, MAUI, HAWAII DRAIN CROSSING - 3 | | | | |
| DESIGNED BY: KM | | DRAWN BY: ATA | | CHECKED BY: AW |
| APPROVED BY: | | SUBMITTED BY: | | |
| DATE: | FILE NUMBER: | DATE: | | |


DATE: SEPTEMBER 2023

| FILE | POCKET | FOLDER | NO. |
|------|--------|--------|-----|
| | | | |

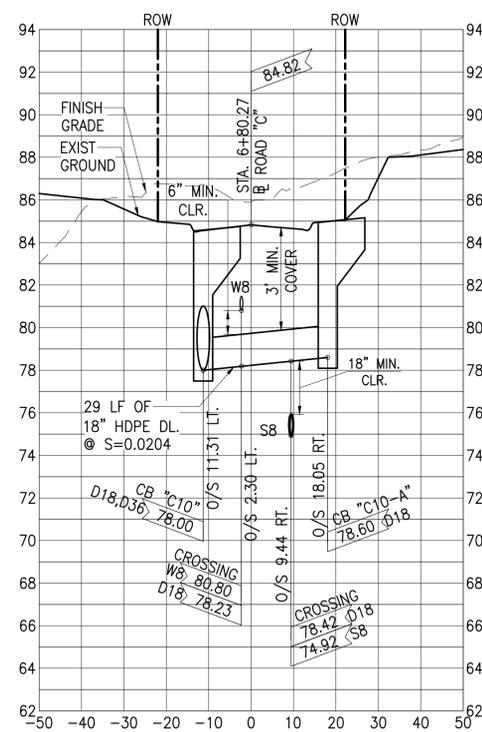


DRAIN CROSSING "C10" - STA. 6+80.24 ROAD "C"

SCALE: HORIZ: 1"=20'
VERT.: 1"=4'

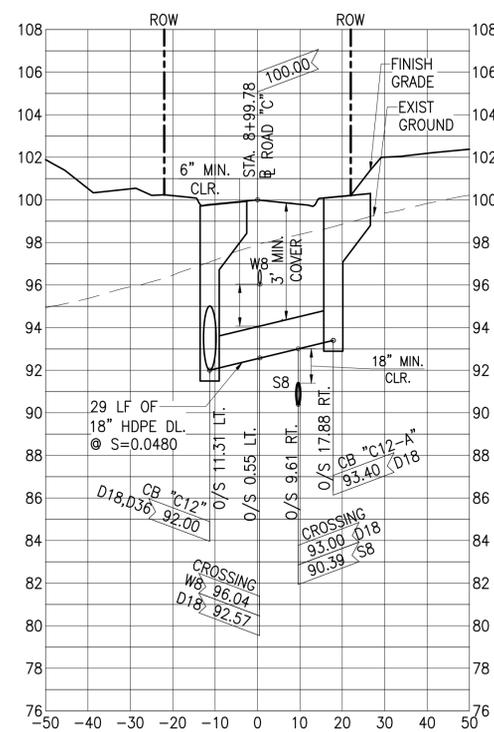


DRAIN CROSSING "C12" - STA. 8+99.78 ROAD "C"

SCALE: HORIZ: 1"=20'
VERT.: 1"=4'

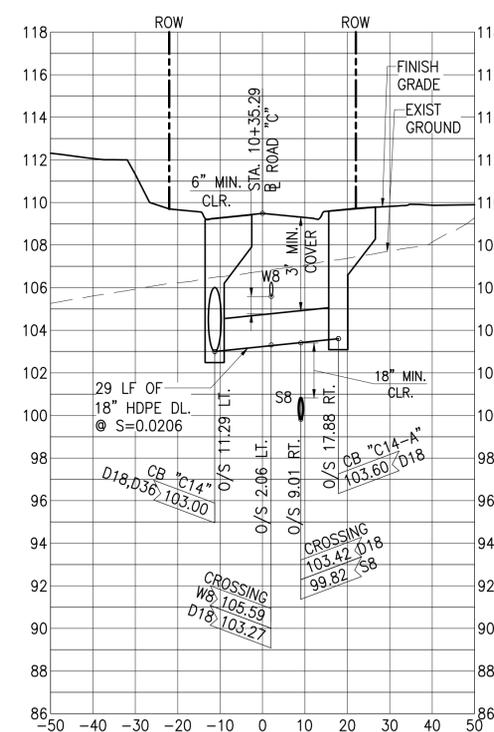


DRAIN CROSSING "C14" - STA. 10+35.29 ROAD "C"

SCALE: HORIZ: 1"=20'
VERT.: 1"=4'

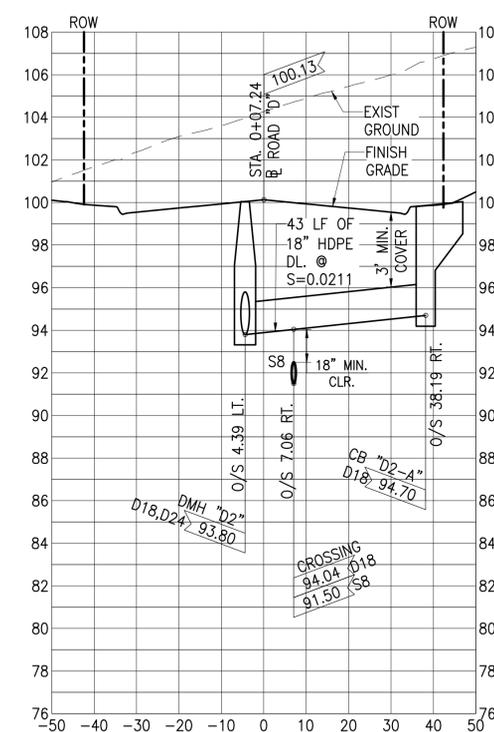


DRAIN CROSSING "D2" - STA. 0+07.24 ROAD "D"

SCALE: HORIZ: 1"=20'
VERT.: 1"=4'

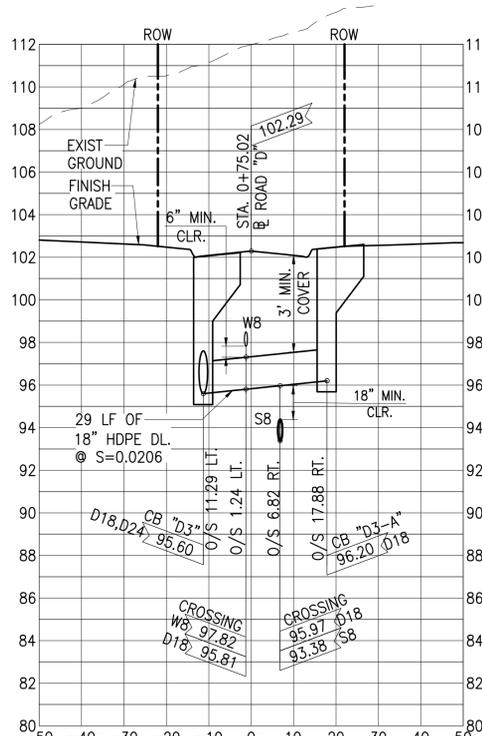


DRAIN CROSSING "D3" - STA. 0+75.02 ROAD "D"

SCALE: HORIZ: 1"=20'
VERT.: 1"=4'

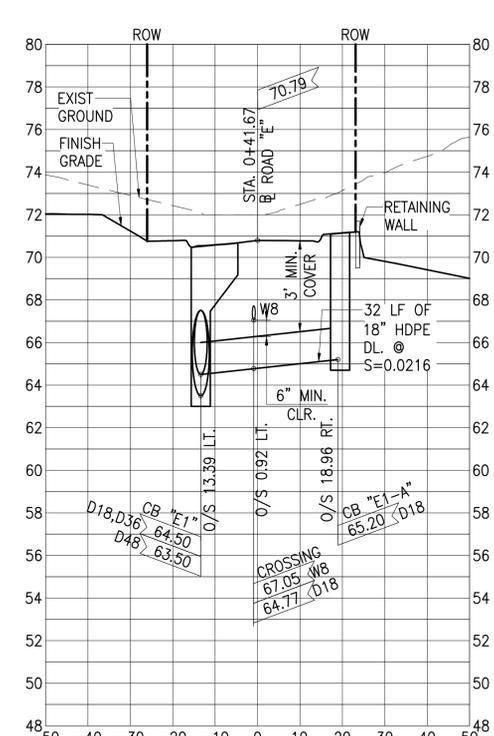

DRAIN CROSSING "E1" - STA. 0+41.67 ROAD "E"

SCALE: HORIZ: 1"=20'
VERT.: 1"=4'

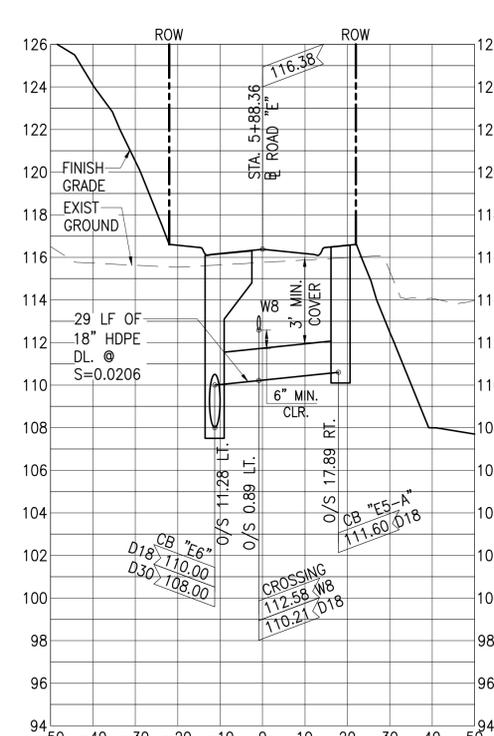


DRAIN CROSSING "E5" - STA. 5+88.36 ROAD "E"


SCALE: HORIZ: 1"=20'
VERT.: 1"=4'

| <p>ADRIENNE W. L.H. HOAG LICENSED PROFESSIONAL ENGINEER No. 6378 HAWAII, U.S.A.</p> <p>THIS WORK WAS PREPARED BY ME OR UNDER MY SUPERVISION AND CONSTRUCTION OF THIS PROJECT WILL BE UNDER MY OBSERVATION AS DEFINED IN SECTION 16-115-2, HAWAII ADMINISTRATIVE RULES, DEPARTMENT OF COMMERCE AND CONSUMER AFFAIRS, STATE OF HAWAII, PROFESSIONAL ENGINEERS, ARCHITECTS, SURVEYORS AND LANDSCAPE ARCHITECTS.</p> <p>LICENSE EXPIRES: APRIL 30, 2024</p> <p>0 1 2 LINE IS 2 INCHES AT FULL SIZE (IF NOT 2-INCHES : SCALE ACCORDINGLY)</p> <p>DWG. NO. C-424</p> <p>SHEET 47 OF</p> | <table border="1"> <tr> <th>REVISION</th> <th>DATE</th> <th>BRIEF</th> <th>MADE BY</th> <th>APPROVED</th> </tr> <tr> <td> </td> <td> </td> <td> </td> <td> </td> <td> </td> </tr> </table> | REVISION | DATE | BRIEF | MADE BY | APPROVED | | | | | |
|--------------------------------------------------------------------------------------------------------------------------------------------------------------------------------------------------------------------------------------------------------------------------------------------------------------------------------------------------------------------------------------------------------------------------------------------------------------------------------------------------------------------------------------------------------------------------------------------------------------|-----------------------------------------------------------------------------------------------------------------------------------------------------------------------------------------------------------------------------------------------------------------------------------------------------|----------|-------|---------|----------|----------|--|--|--|--|--|
| | REVISION | DATE | BRIEF | MADE BY | APPROVED | | | | | | |
| | | | | | | | | | | | |
| | <p>ATA AUSTIN, TSUTSUMI & ASSOCIATES, INC. ENGINEERS, SURVEYORS • HONOLULU, WAILUKU, HAWAII</p> <p>DEPARTMENT OF HAWAIIAN HOME LANDS</p> <p>VILLAGES OF LEIALI'I, PHASE 1B</p> <p>TAX MAP KEY: (2) 4-5-21: 020 LAHAINA, MAUI, HAWAII</p> <p>DRAIN CROSSING - 4</p> | | | | | | | | | | |
| <p>DESIGNED BY: KM DRAWN BY: ATA CHECKED BY: AW</p> <p>APPROVED BY: _____ SUBMITTED BY: _____</p> <p>DATE: _____ FIRM NUMBER: _____ DATE: _____</p> | | | | | | | | | | | |


A:\2018\18-522\Drawings\1805-C-47-DRAIN CROSSING - 4.dwg

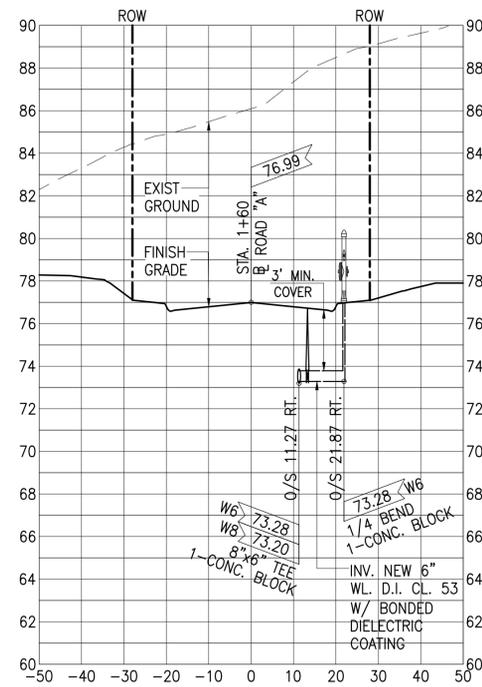


PROFILE - FIRE HYDRANT "A1"

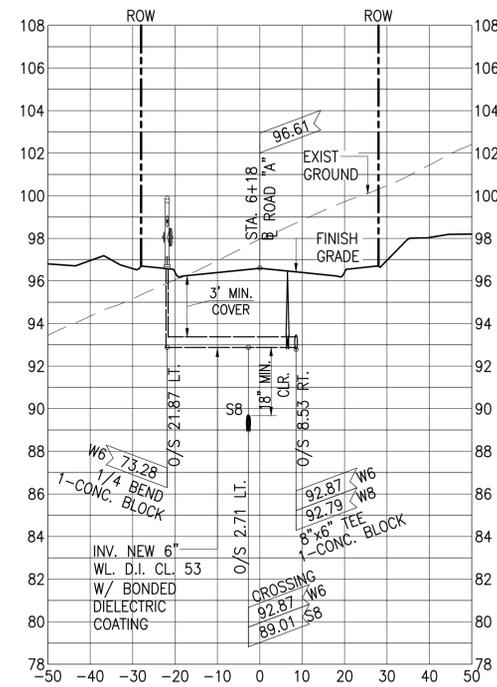


PROFILE - FIRE HYDRANT "A2"

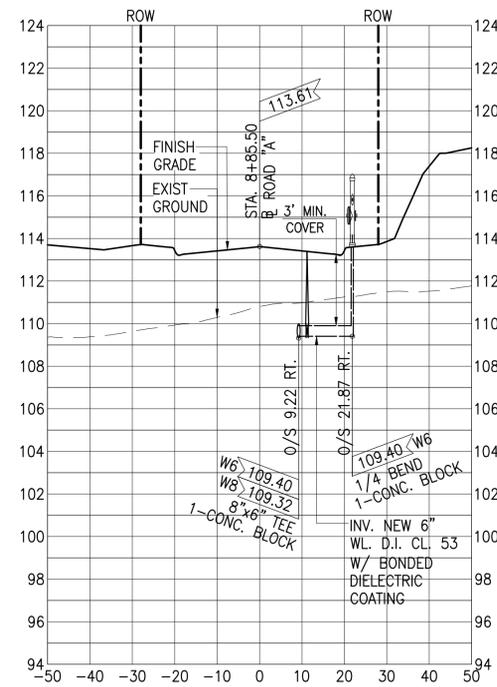


PROFILE - FIRE HYDRANT "A3"

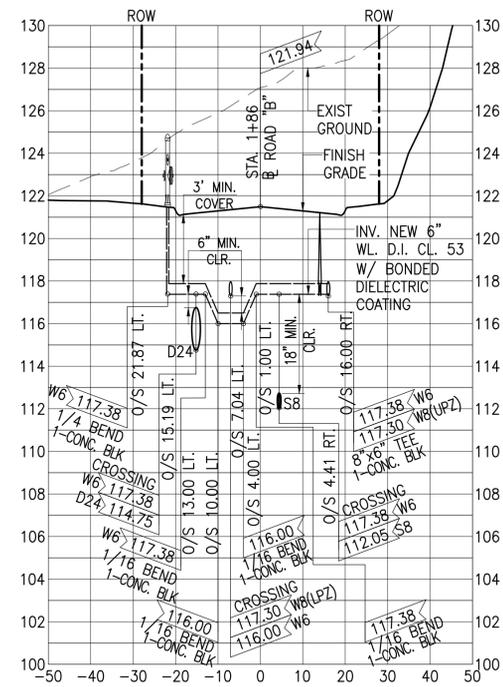


PROFILE - FIRE HYDRANT "B1"

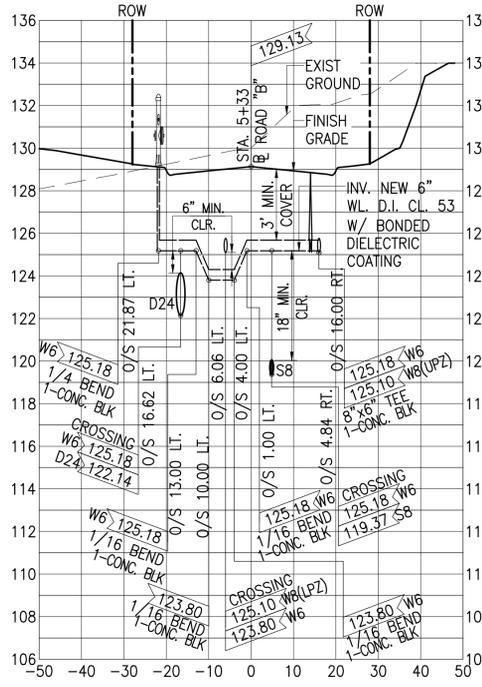

PROFILE - FIRE HYDRANT "B2"

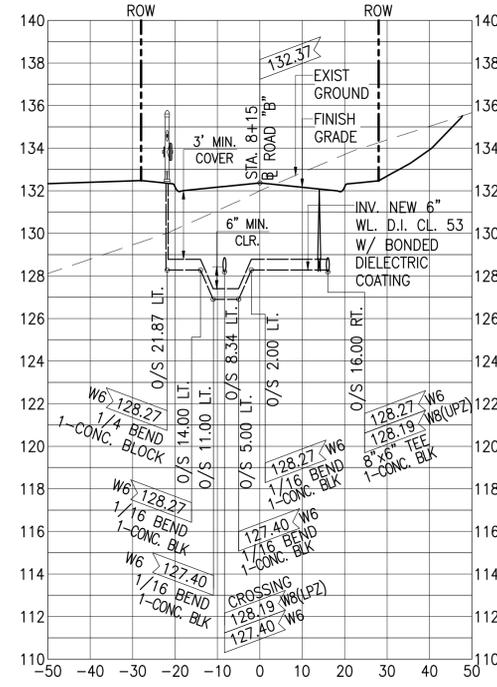

PROFILE - FIRE HYDRANT "B3"

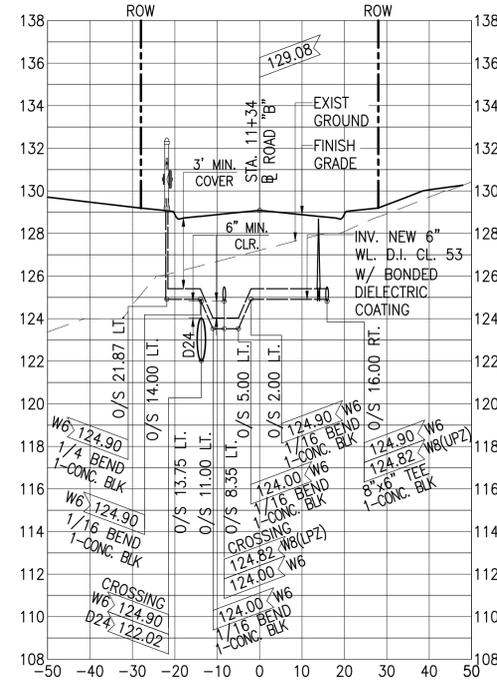


PROFILE - FIRE HYDRANT "B4"

FIRE HYDRANT CONNECTION PROFILES - 1


SCALE: HORIZ: 1"=20'
VERT.: 1"=4'

| | | | | | |
|-----------------------------------------------------------------------------------------------------------------------------------------------------------------------------------|----------|--------------------------------------------------------------------------------------|-------|---------|----------|
| | REVISION | DATE | BRIEF | MADE BY | APPROVED |
| | | | | | |
| <p>DEPARTMENT OF HAWAIIAN HOME LANDS</p> <p>VILLAGES OF LEIALI'I, PHASE 1B</p> <p>TAX MAP KEY: (2) 4-5-21: 020</p> <p>LAHAINA, MAUI, HAWAII</p> <p>FH CONNECTION PROFILES - 1</p> | | | | | |
| LICENSE EXPIRES: APRIL 30, 2024 0 1 2 LINE IS 2 INCHES AT FULL SIZE (IF NOT 2-INCHES : SCALE ACCORDINGLY) | | DWG. NO. C-425 SHEET 48 OF | | | |
| DESIGNED BY: KM DRAWN BY: ATA CHECKED BY: AW | | APPROVED BY: _____ SUBMITTED BY: _____ DATE: _____ FIRM NUMBER: _____ DATE: _____ | | | |


A:\2023\18-522\18-522.dwg

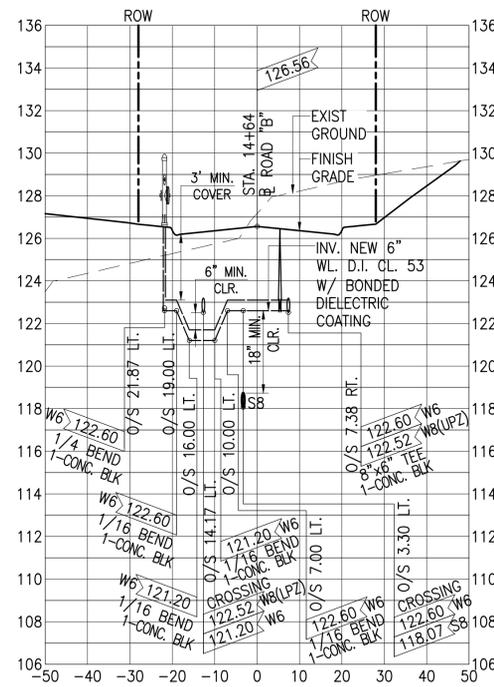


PROFILE - FIRE HYDRANT "B5"

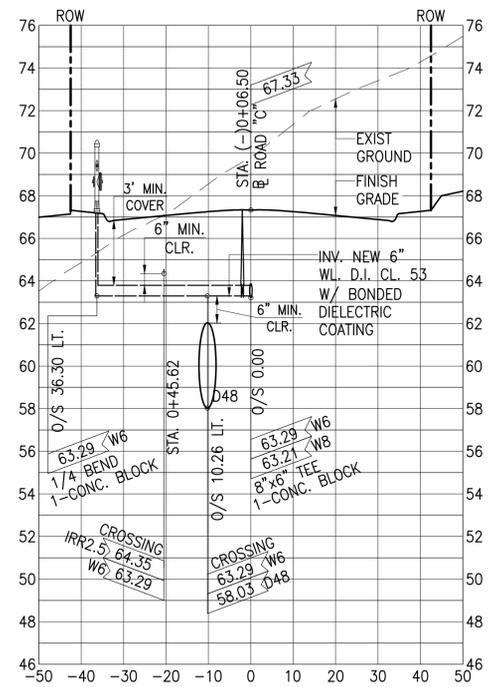


PROFILE - FIRE HYDRANT "C1"

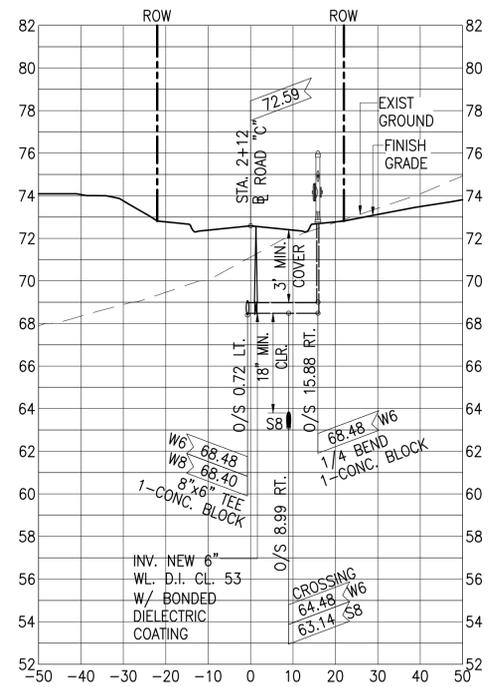


PROFILE - FIRE HYDRANT "C2"

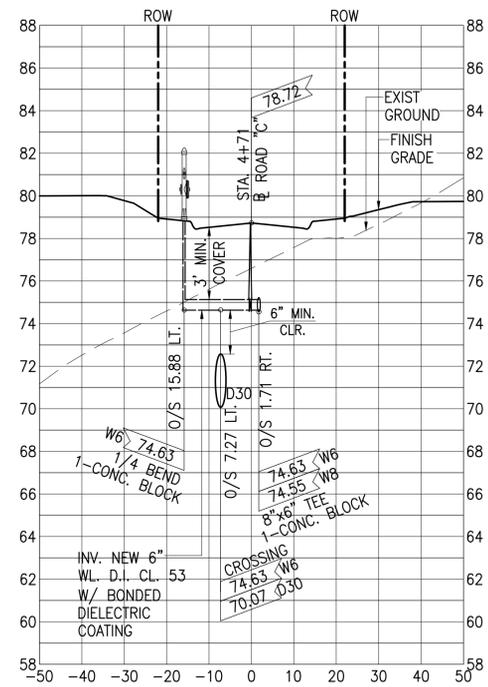


PROFILE - FIRE HYDRANT "C3"

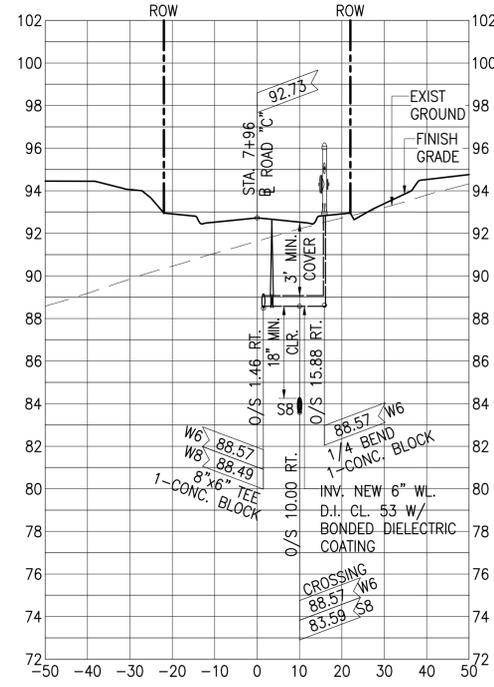

PROFILE - FIRE HYDRANT "C4"

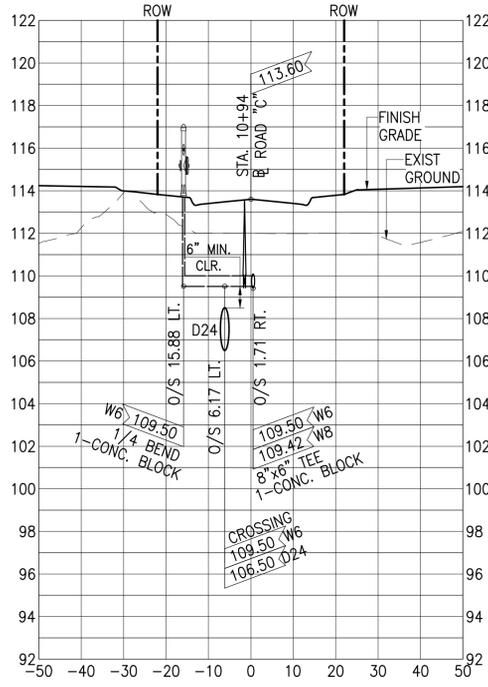

PROFILE - FIRE HYDRANT "C5"

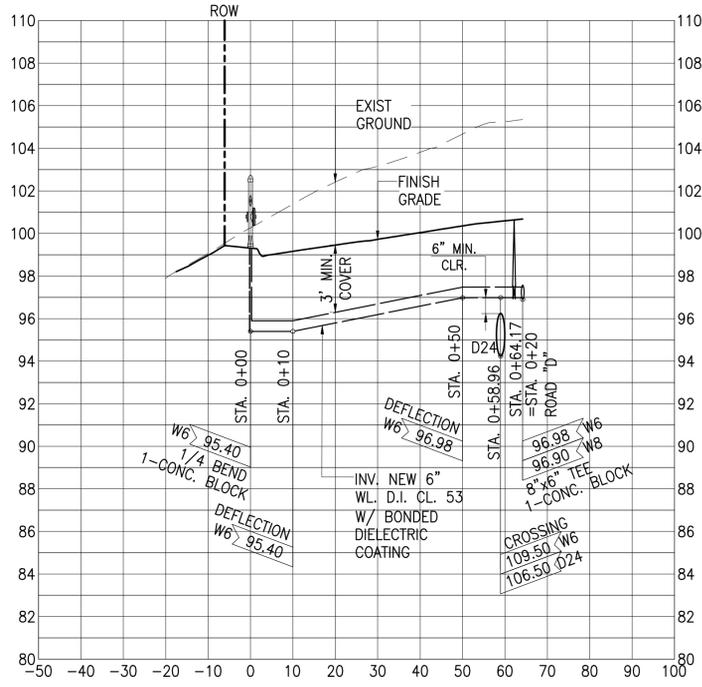


PROFILE - FIRE HYDRANT "D1"


FIRE HYDRANT CONNECTION PROFILES - 2
 SCALE: HORIZ: 1"=20'
 VERT.: 1"=4'

| | |
|--|-----------------------------------------------------------------------------------------------------------------------------------------------------------|
| | REVISION DATE BRIEF MADE BY APPROVED |
| | ATA AUSTIN, TSUTSUMI & ASSOCIATES, INC. ENGINEERS, SURVEYORS • HONOLULU, WAILUKU, HAWAII |
| | DEPARTMENT OF HAWAIIAN HOME LANDS VILLAGES OF LEIALI'I, PHASE 1B TAX MAP KEY: (2) 4-5-21: 020 LAHAINA, MAUI, HAWAII FH CONNECTION PROFILE - 2 |
| | LICENSE EXPIRES: APRIL 30, 2024 DWG. NO. C-426 SHEET 49 OF |

A:\2018\18-522\18-522.dwg (18-522) - 49

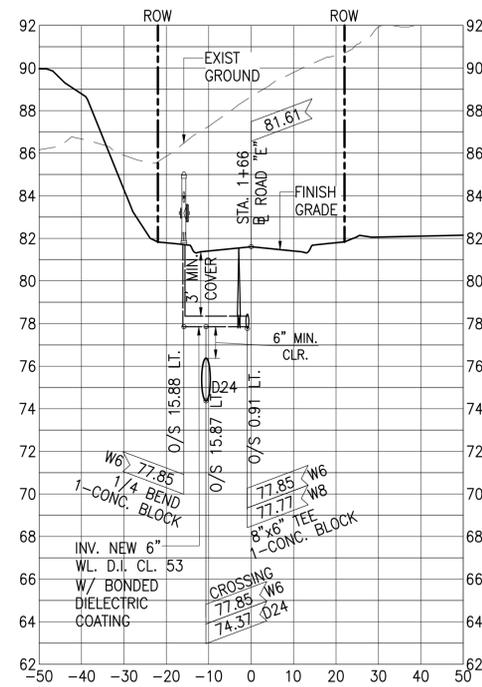

PROFILE – FIRE HYDRANT "E1"

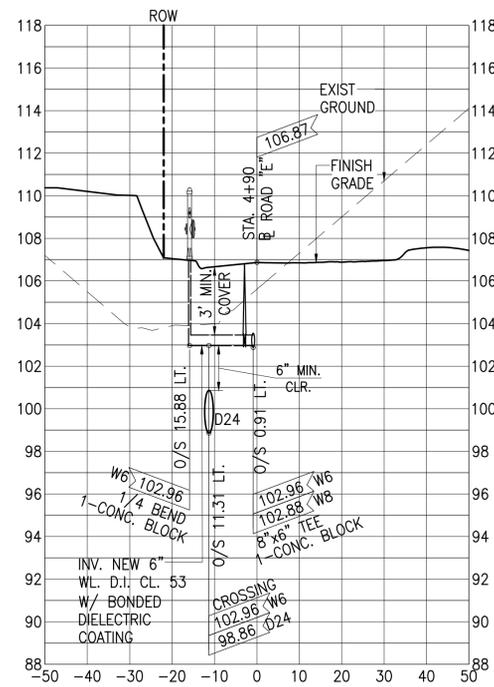

PROFILE – FIRE HYDRANT "E2"


FIRE HYDRANT CONNECTION PROFILES – 3

SCALE: HORIZ: 1"=20'
VERT.: 1"=4'


| | | | | | | |
|-------------------------------------------------------------------------------------------------------------------------------------------------------------------------------------------------------------------------------------------------------------------------------------------------------------------------------------------------------------------------------------------------------------------------------------------------------------------------------------------------------------------------------------------------------------------------------------------------------------|-----------------------------------------------------------------------------------------------------------------------------------------------------------------------------------------------------------------------------------------------------------------------------------------------|------|--------------|---------|------------|-------------|
| <p>ADRIENNE W.L.H. HOOG LICENSED PROFESSIONAL ENGINEER No. 6378 HAWAII, U.S.A.</p> <p>THIS WORK WAS PREPARED BY ME OR UNDER MY SUPERVISION AND CONSTRUCTION OF THIS PROJECT WILL BE UNDER MY OBSERVATION AS DEFINED IN SECTION 16-115-2, HAWAII ADMINISTRATIVE RULES, DEPARTMENT OF COMMERCE AND CONSUMER AFFAIRS, STATE OF HAWAII, PROFESSIONAL ENGINEERS, ARCHITECTS, SURVEYORS AND LANDSCAPE ARCHITECTS.</p> <p>LICENSE EXPIRES: APRIL 30, 2024</p> <p>0 1 2 LINE IS 2 INCHES AT FULL SIZE (If NOT 2-inches : Scale Accordingly)</p> <p>DWG. NO. C-427</p> <p>SHEET 50 OF</p> | REVISION | DATE | BRIEF | MADE BY | APPROVED | |
| | <p>ATA AUSTIN, TSUTSUMI & ASSOCIATES, INC. ENGINEERS, SURVEYORS • HONOLULU, WAILUKU, HAWAII</p> <p>DEPARTMENT OF HAWAIIAN HOME LANDS</p> <p>VILLAGES OF LEIALI'I, PHASE 1B</p> <p>TAX MAP KEY: (2) 4-5-21: 020 LAHAINA, MAUI, HAWAII</p> <p>FH CONNECTION PROFILES – 3</p> | | | | | |
| | DESIGNED BY | KM | DRAWN BY | ATA | CHECKED BY | AW |
| | APPROVED BY | | SUBMITTED BY | | DATE | FIRM NUMBER |

DATE: SEPTEMBER 2023


| | | | |
|------|--------|--------|-----|
| FILE | POCKET | FOLDER | NO. |
| | | | |

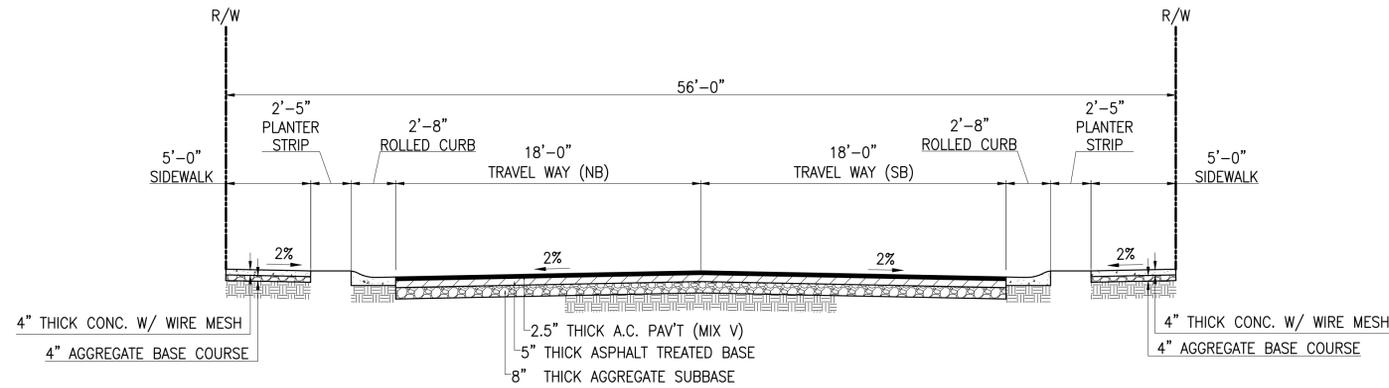

TYPICAL SECTION – COLLECTOR STREET
SCALE: 1" = 5'

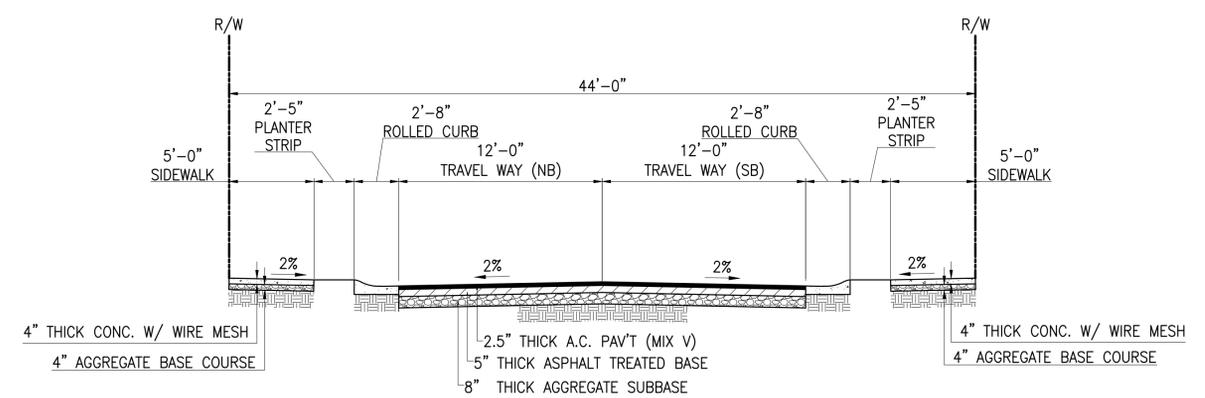

TYPICAL SECTION – MINOR STREET
SCALE: 1" = 5'

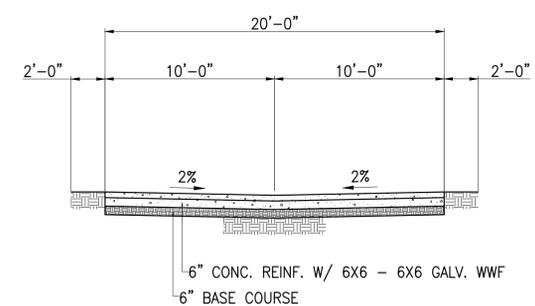


TYPICAL SECTION – DRIVEWAY
SCALE: 1" = 5'

| | | | | | | |
|--------------------------------------------------------------------------------------------------------------------------------------------------------------------------------------------------------------------------------------------------------------------------------------------------------------------------------------------------------------------------------------------------------------------------------------------------------------------------------------------------------------------------------------------------------------------------------------------------------------|---------------------------------------------------------------------------------------------------------------------------------------------------------------------------------------------------------------------------------------------------------------------------------------------|----------------------|-----------------------|--------------------|-------------|--|
| <p>ADRIENNE W. L.H. HOOG LICENSED PROFESSIONAL ENGINEER No. 6378 HAWAII, U.S.A.</p> <p>THIS WORK WAS PREPARED BY ME OR UNDER MY SUPERVISION AND CONSTRUCTION OF THIS PROJECT WILL BE UNDER MY OBSERVATION AS DEFINED IN SECTION 16-115-2, HAWAII ADMINISTRATIVE RULES, DEPARTMENT OF COMMERCE AND CONSUMER AFFAIRS, STATE OF HAWAII, PROFESSIONAL ENGINEERS, ARCHITECTS, SURVEYORS AND LANDSCAPE ARCHITECTS.</p> <p>LICENSE EXPIRES: APRIL 30, 2024</p> <p>0 1 2 LINE IS 2 INCHES AT FULL SIZE (If NOT 2-inches : Scale Accordingly)</p> <p>DWG. NO. C-427</p> <p>SHEET 52 OF</p> | REVISION | DATE | BRIEF | MADE BY | APPROVED | |
| | <p>ATA AUSTIN, TSUTSUMI & ASSOCIATES, INC. ENGINEERS, SURVEYORS • HONOLULU, WAILUKU, HAWAII</p> <p>DEPARTMENT OF HAWAIIAN HOME LANDS</p> <p>VILLAGES OF LEIALI'I, PHASE 1B</p> <p>TAX MAP KEY: (2) 4-5-21: 020 LAHAINA, MAUI, HAWAII</p> <p>TYPICAL ROADWAY SECTIONS</p> | | | | | |
| | DESIGNED BY: KM | DRAWN BY: ATA | CHECKED BY: AW | APPROVED BY: _____ | | |
| | DATE: _____ | | FIRM NUMBER: _____ | | DATE: _____ | |

| | |
|------------|-----------|
| Δ_7 | 73°12'29" |
| R | 38.96' |
| Lc | 49.78' |


| | |
|------------|-----------|
| Δ_8 | 89°20'27" |
| R | 38.96' |
| Lc | 60.75' |

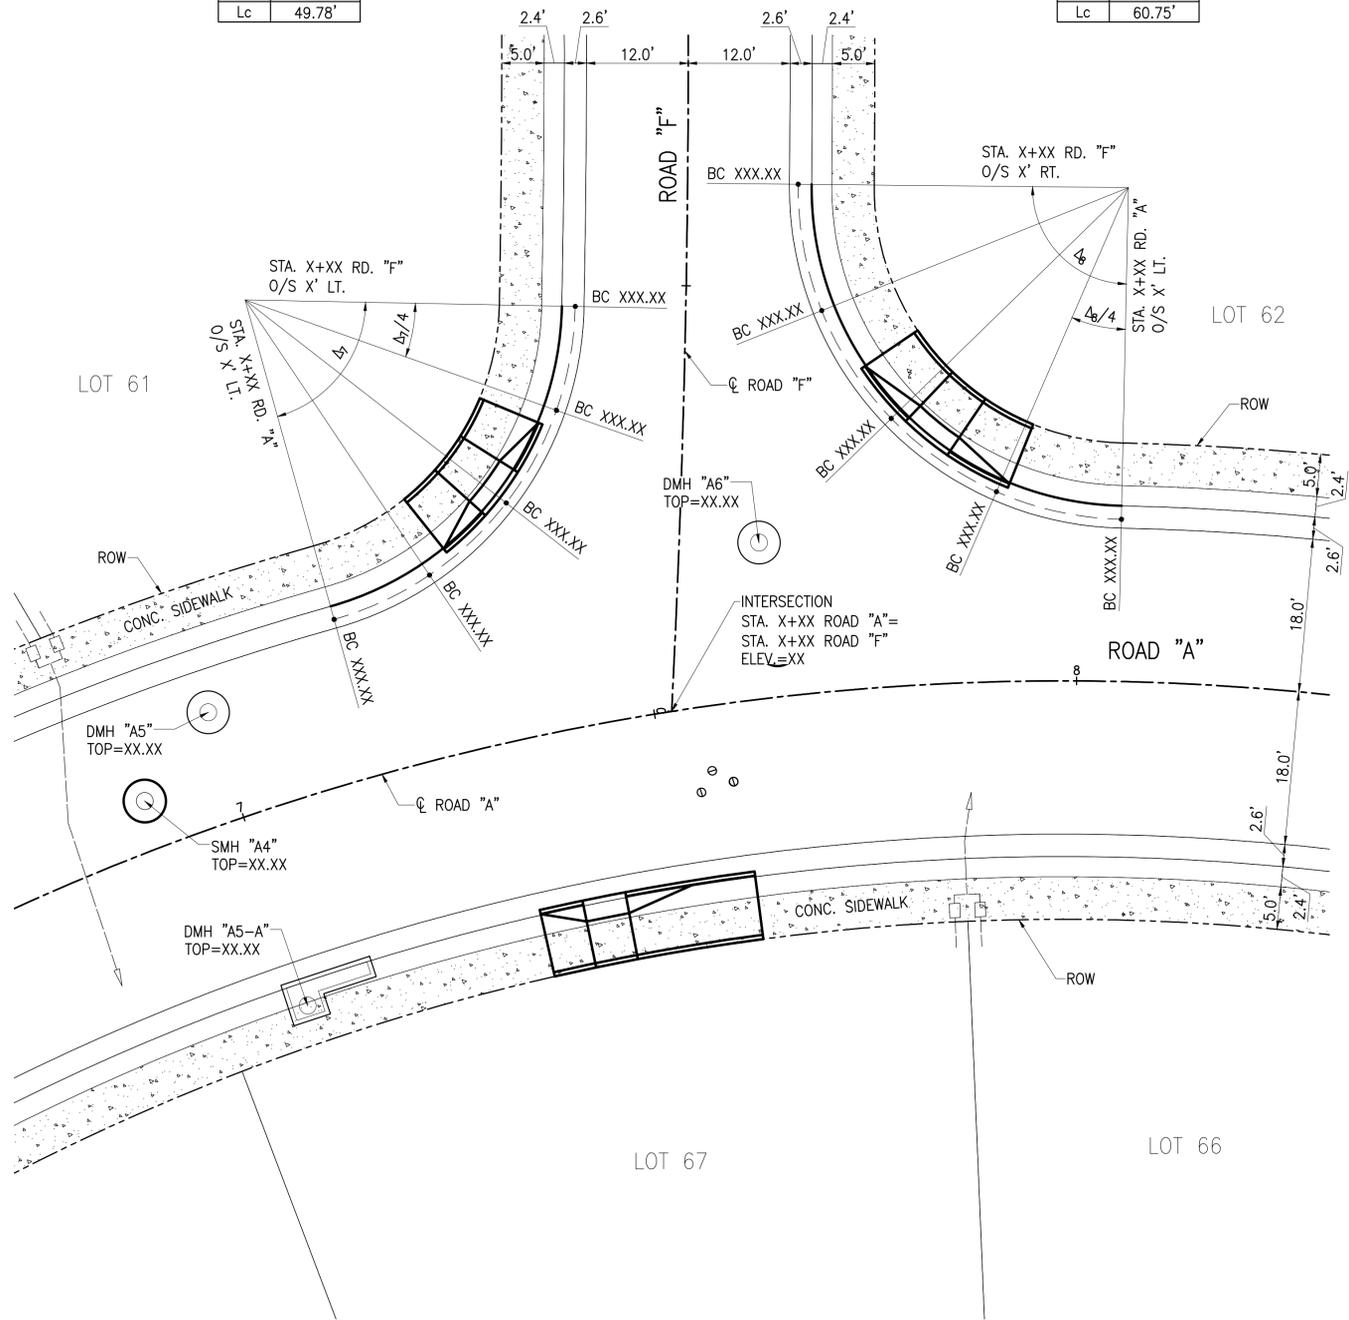

CURB RETURN 3 – ROAD "A" & ROAD "F"
SCALE: 1"=10'

| | |
|------------|-----------|
| Δ_9 | 89°20'27" |
| R | 38.96' |
| Lc | 60.75' |

| | |
|---------------|-----------|
| Δ_{10} | 93°37'10" |
| R | 18.95' |
| Lc | 30.98' |

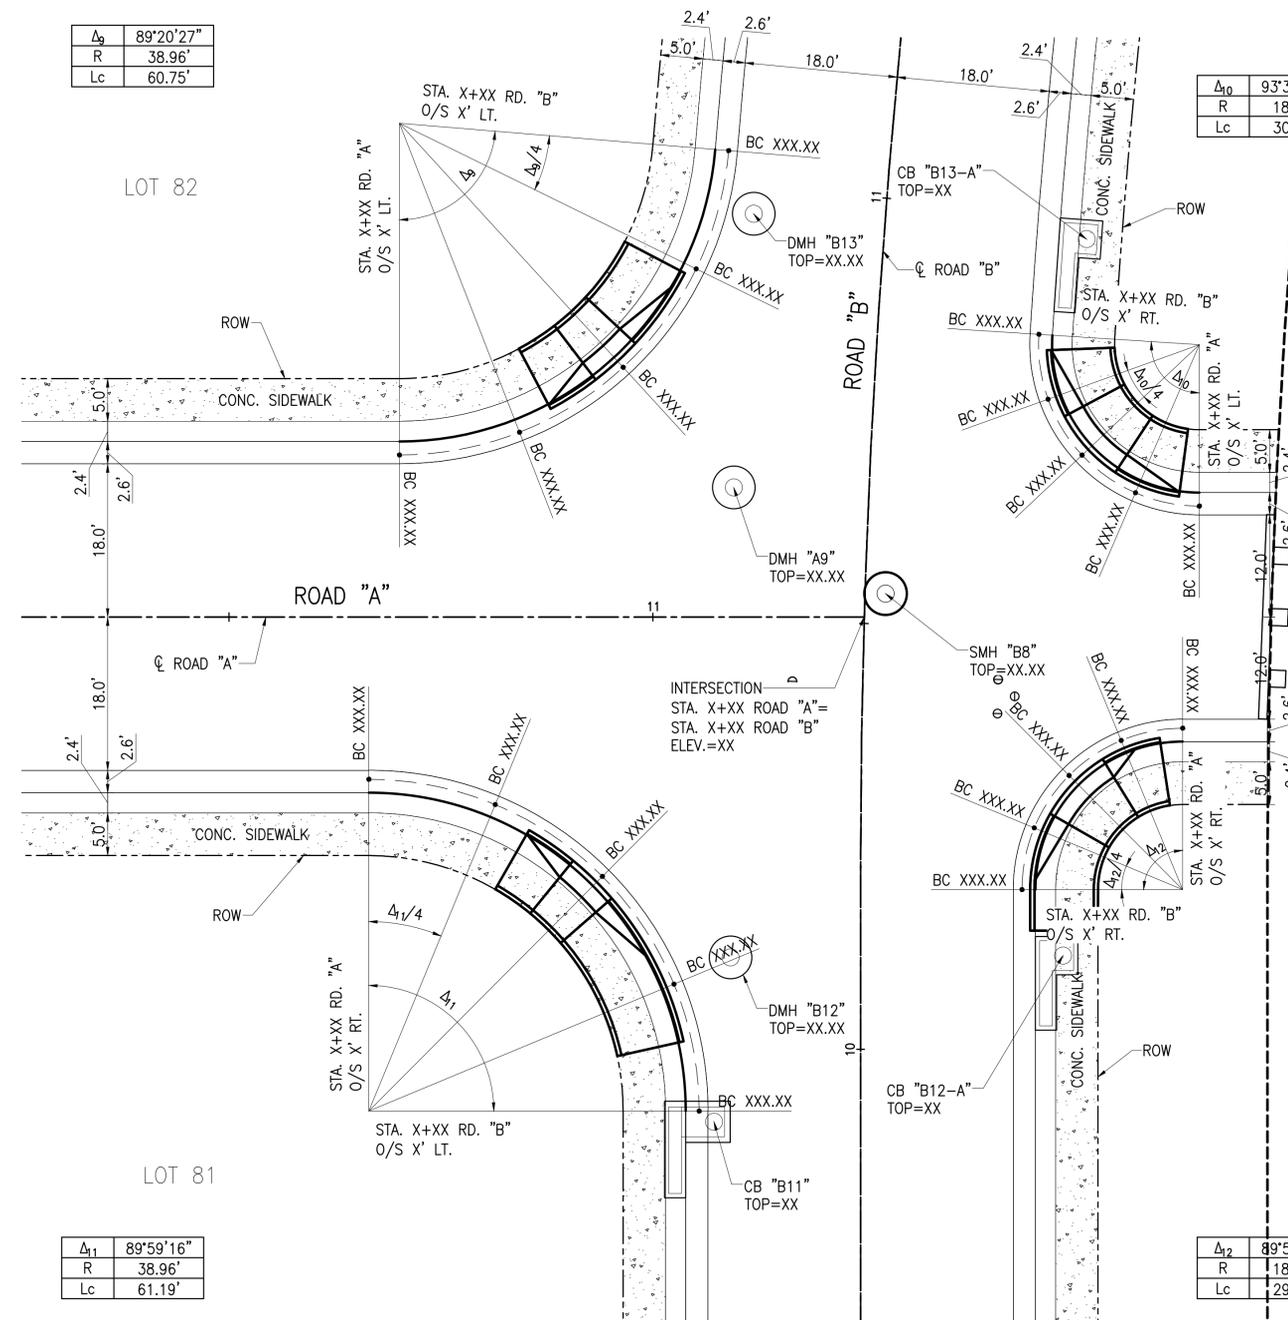

CURB RETURN 4 – ROAD "A" & ROAD "B"
SCALE: 1"=10'

| | |
|---------------|-----------|
| Δ_{11} | 89°59'16" |
| R | 38.96' |
| Lc | 61.19' |

| | |
|---------------|-----------|
| Δ_{12} | 89°57'46" |
| R | 18.96' |
| Lc | 29.77' |



THIS WORK WAS PREPARED BY ME OR UNDER MY SUPERVISION AND CONSTRUCTION OF THIS PROJECT WILL BE UNDER MY OBSERVATION AS DEFINED IN SECTION 16-115-2, HAWAII ADMINISTRATIVE RULES, DEPARTMENT OF COMMERCE AND CONSUMER AFFAIRS, STATE OF HAWAII. PROFESSIONAL ENGINEERS, ARCHITECTS, SURVEYORS AND LANDSCAPE ARCHITECTS.

LICENSE EXPIRES: APRIL 30, 2024

0 1 2

LINE IS 2 INCHES AT FULL SIZE (IF NOT 2-INCHES : SCALE ACCORDINGLY)


DWG. NO. **C-502**

SHEET 54 OF


| REVISION | DATE | BRIEF | MADE BY | APPROVED | |
|------------------------------------------------------------------------------------------------------------------------------------------------------------------------------------------------------------------------------------------------------------------------------------------------------|------|--------------|---------|------------|----|
| <p>ATA AUSTIN, TSUTSUMI & ASSOCIATES, INC. ENGINEERS, SURVEYORS • HONOLULU, WAILUKU, HAWAII</p> <p>DEPARTMENT OF HAWAIIAN HOME LANDS</p> <p>VILLAGES OF LEIALI'I, PHASE 1B</p> <p>TAX MAP KEY: (2) 4-5-21: 020 LAHAINA, MAUI, HAWAII</p> <p>CURB AND CURVE RETURN DETAILS – 2</p> | | | | | |
| DESIGNED BY | KM | DRAWN BY | ATA | CHECKED BY | AW |
| APPROVED BY | | SUBMITTED BY | | | |
| DATE | | FIRM NUMBER | | DATE | |

DATE: SEPTEMBER 2023

| FILE | POCKET | FOLDER | NO. |
|------|--------|--------|-----|
| | | | |

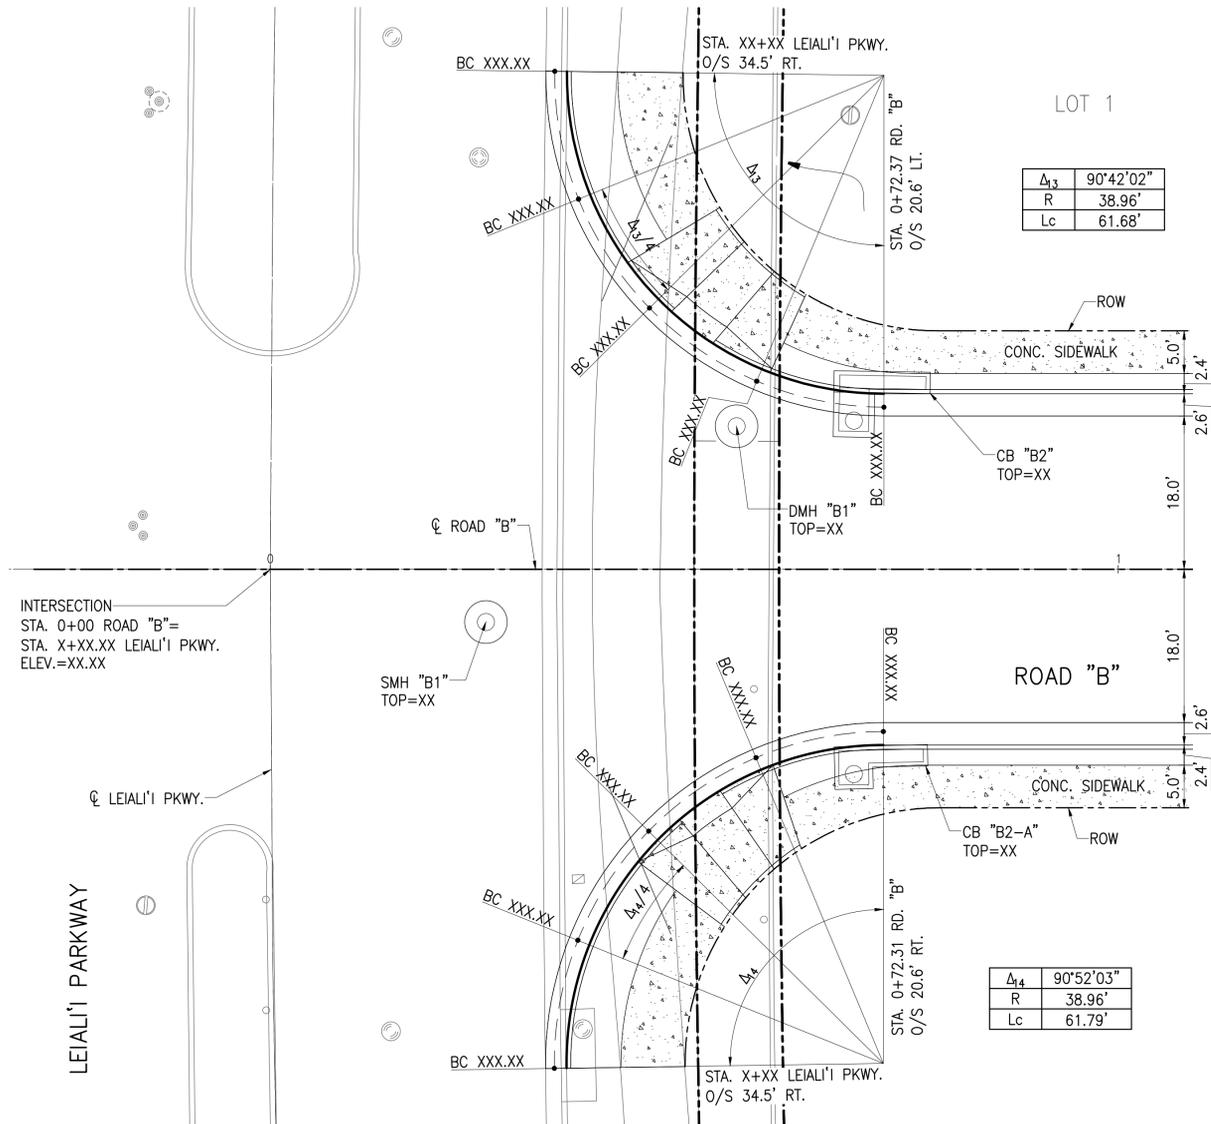

CURB RETURN X - ROAD "B" & LEIALI'I PARKWAY
SCALE: 1"=10'

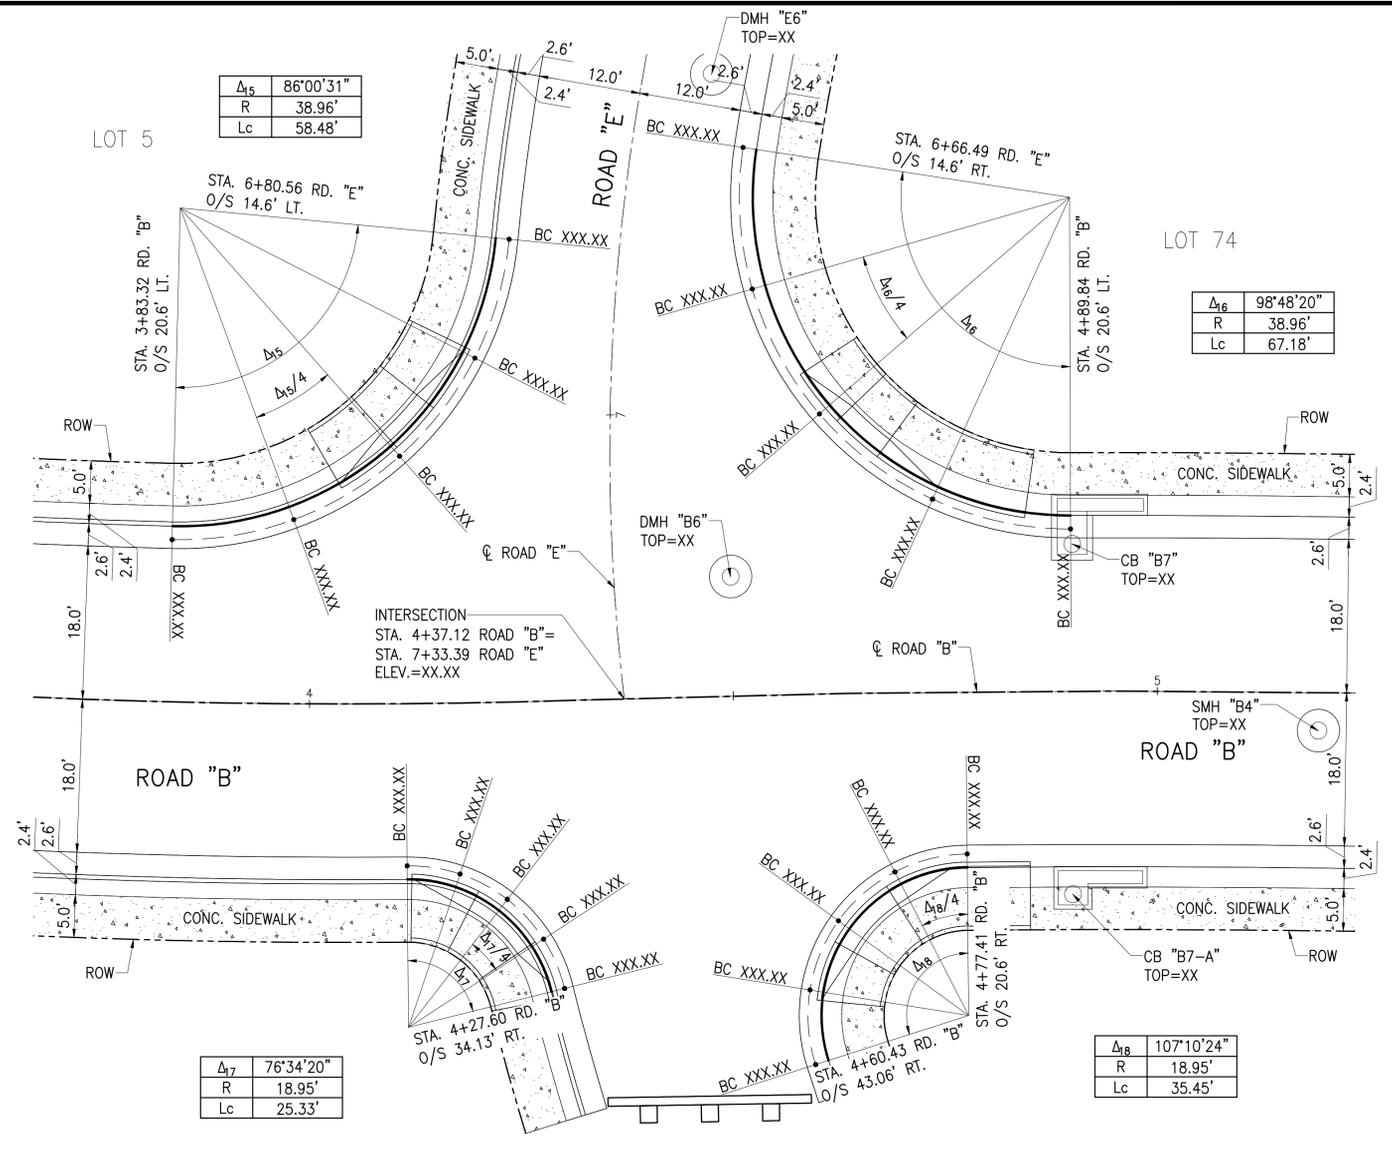

CURB RETURN X - ROAD "B" & ROAD "E"
SCALE: 1"=10'

ADRIENNE W. L.H. HOOG
LICENSED PROFESSIONAL ENGINEER
No. 6378
HAWAII, U.S.A.

THIS WORK WAS PREPARED BY ME OR UNDER MY SUPERVISION AND CONSTRUCTION OF THIS PROJECT WILL BE UNDER MY OBSERVATION AS DEFINED IN SECTION 16-115-2, HAWAII ADMINISTRATIVE RULES, DEPARTMENT OF COMMERCE AND CONSUMER AFFAIRS, STATE OF HAWAII. PROFESSIONAL ENGINEERS, ARCHITECTS, SURVEYORS AND LANDSCAPE ARCHITECTS.

LICENSE EXPIRES: APRIL 30, 2024

0 1 2
LINE IS 2 INCHES AT FULL SIZE
(IF NOT 2-INCHES : Scale Accordingly)

DWG. NO. **C-503**
SHEET 55 OF

| REVISION | DATE | BRIEF | MADE BY | APPROVED |
|----------|------|-------|---------|----------|
| | | | | |

ATA AUSTIN, TSUTSUMI & ASSOCIATES, INC.
ENGINEERS, SURVEYORS • HONOLULU, WAILUKU, HAWAII

DEPARTMENT OF HAWAIIAN HOME LANDS

VILLAGES OF LEIALI'I, PHASE 1B
TAX MAP KEY: (2) 4-5-21: 020
LAHAINA, MAUI, HAWAII


CURB AND CURVE RETURN DETAILS - 3

DESIGNED BY: **KM** DRAWN BY: **ATA** CHECKED BY: **AW**

APPROVED BY: _____ SUBMITTED BY: _____

DATE: _____ FIRM NUMBER: _____ DATE: _____


A:\2023\18-522\p02\p02.dwg CURB AND CURVE RETURN DETAILS - 3 - .dwg

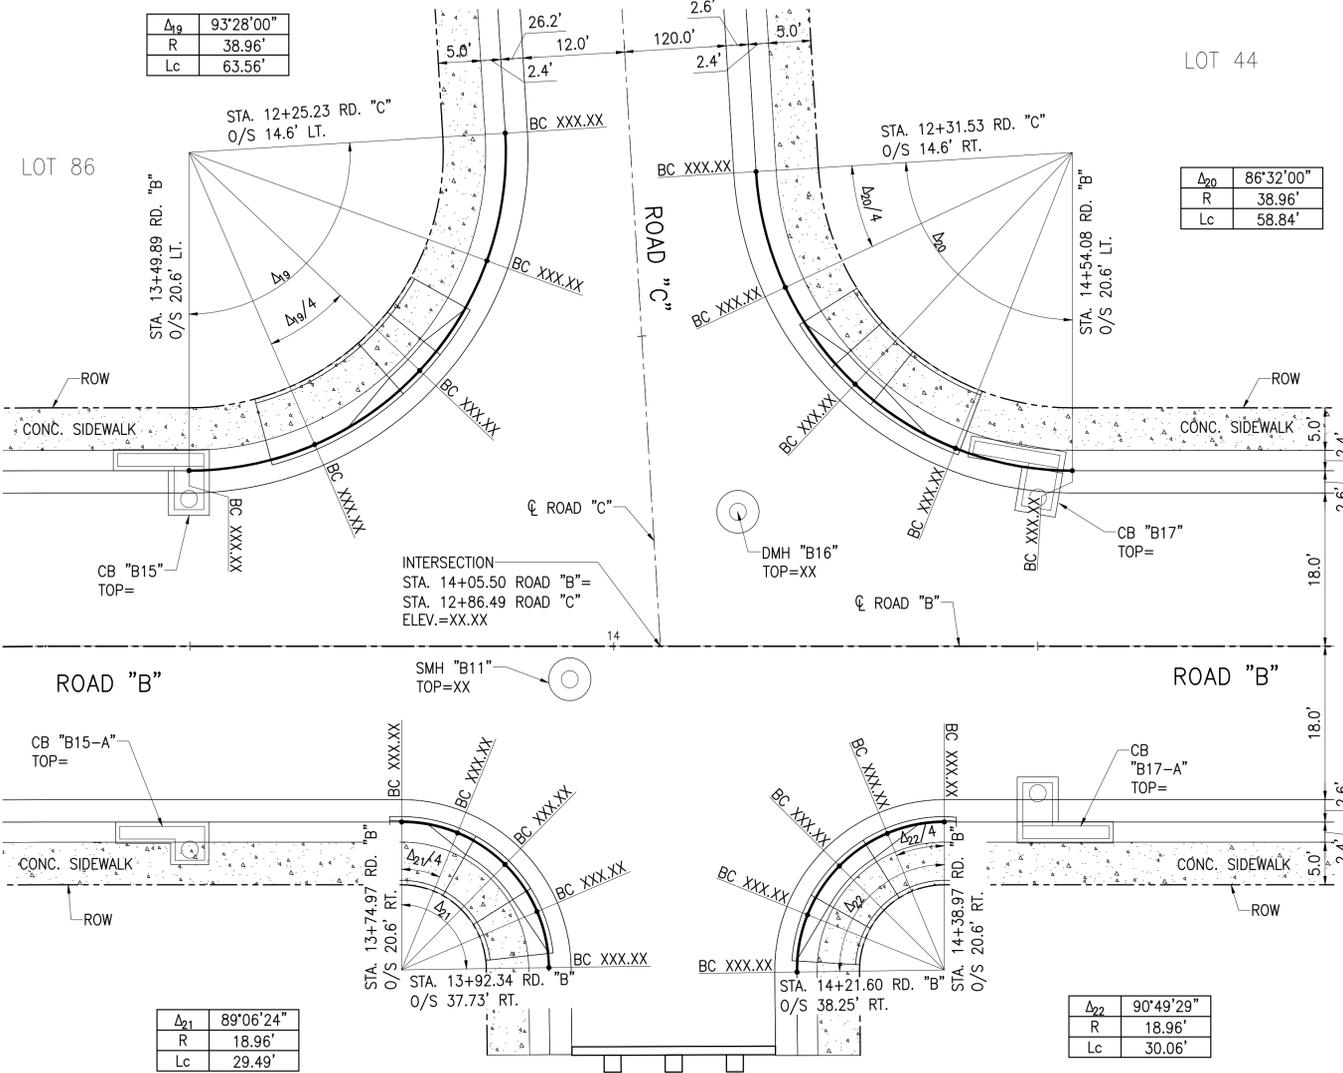

CURB RETURN X - ROAD "B" & ROAD "C"
SCALE: 1"=10'

LOT 44


| | |
|-----------------|-----------|
| Δ ₂₀ | 86°32'00" |
| R | 38.96' |
| Lc | 58.84' |

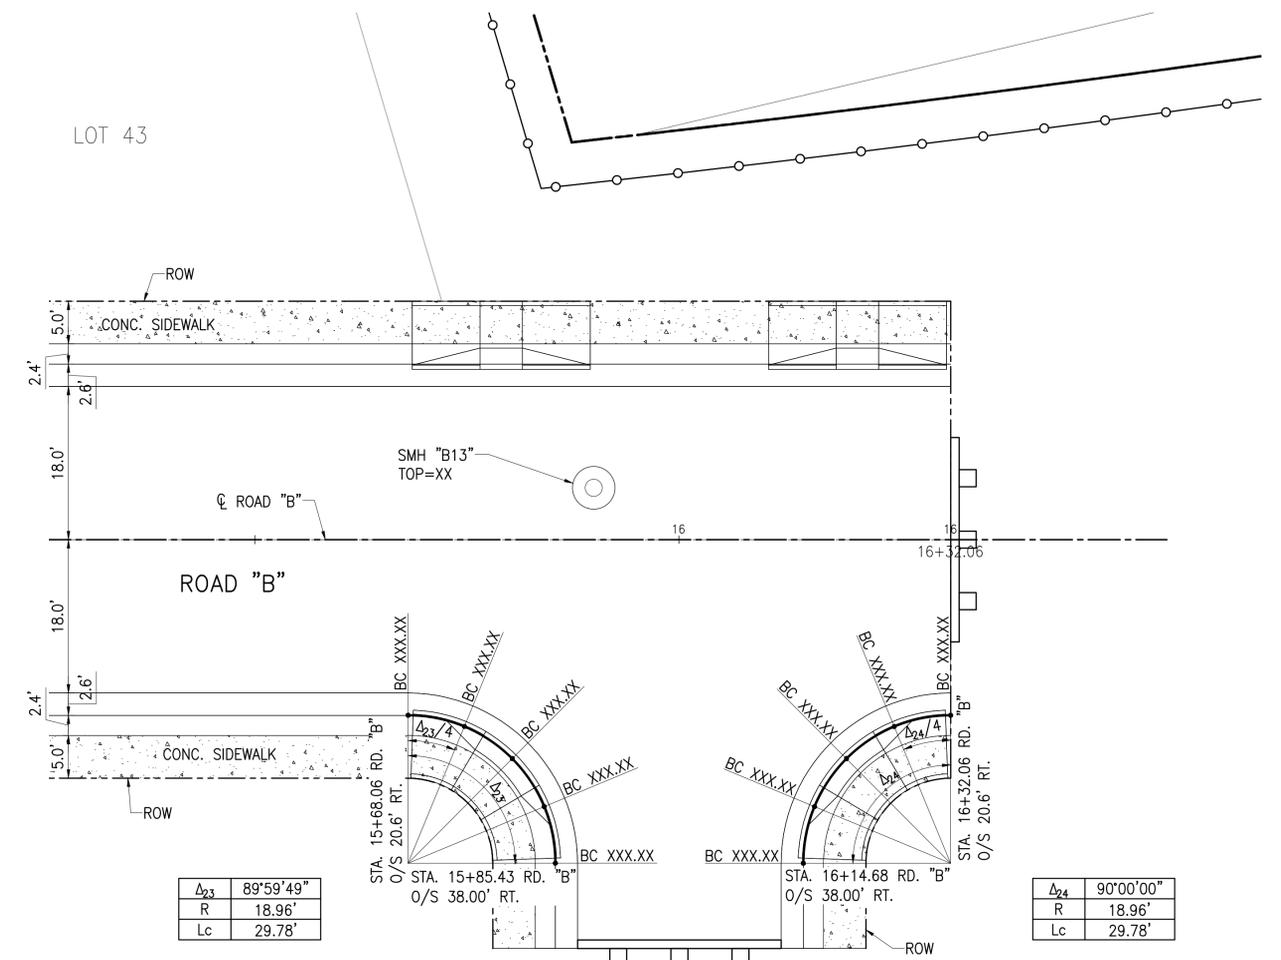


CURB RETURN X - ROAD "B" & ROAD "X"
SCALE: 1"=10'

A:\2024\18-522\DWG\CURB AND CURVE RETURN DETAILS - 4.dwg

| <p>ADRIENNE W. L.H. HOOG LICENSED PROFESSIONAL ENGINEER No. 6378 HAWAII, U.S.A.</p> <p>THIS WORK WAS PREPARED BY ME OR UNDER MY SUPERVISION AND CONSTRUCTION OF THIS PROJECT WILL BE UNDER MY OBSERVATION AS DEFINED IN SECTION 16-115-2, HAWAII ADMINISTRATIVE RULES, DEPARTMENT OF COMMERCE AND CONSUMER AFFAIRS, STATE OF HAWAII, PROFESSIONAL ENGINEERS, ARCHITECTS, SURVEYORS AND LANDSCAPE ARCHITECTS.</p> <p>LICENSE EXPIRES: APRIL 30, 2024</p> <p>0 1 2 LINE IS 2 INCHES AT FULL SIZE (If NOT 2-inches : Scale Accordingly)</p> <p>DWG. NO. C-504 SHEET 56 OF</p> | <table border="1"> <tr><th>REVISION</th><th>DATE</th><th>BRIEF</th><th>MADE BY</th><th>APPROVED</th></tr> <tr><td> </td><td> </td><td> </td><td> </td><td> </td></tr> </table> | REVISION | DATE | BRIEF | MADE BY | APPROVED | | | | | |
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| | REVISION | DATE | BRIEF | MADE BY | APPROVED | | | | | | |
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| <p>ATA AUSTIN, TSUTSUMI & ASSOCIATES, INC. ENGINEERS, SURVEYORS • HONOLULU, WAILUKU, HAWAII</p> <p>DEPARTMENT OF HAWAIIAN HOME LANDS</p> <p>VILLAGES OF LEIALI'I, PHASE 1B TAX MAP KEY: (2) 4-5-21: 020 LAHAINA, MAUI, HAWAII</p> <p>CURB AND CURVE RETURN DETAILS - 4</p> <p>DESIGNED BY: KM DRAWN BY: ATA CHECKED BY: AW</p> <p>APPROVED BY: _____ SUBMITTED BY: _____</p> <p>DATE: _____ FIRM NUMBER: _____ DATE: _____</p> | <table border="1"> <tr><th>FILE</th><th>POCKET</th><th>FOLDER</th><th>NO.</th></tr> <tr><td> </td><td> </td><td> </td><td> </td></tr> </table> | FILE | POCKET | FOLDER | NO. | | | | | | |
| FILE | POCKET | FOLDER | NO. | | | | | | | | |
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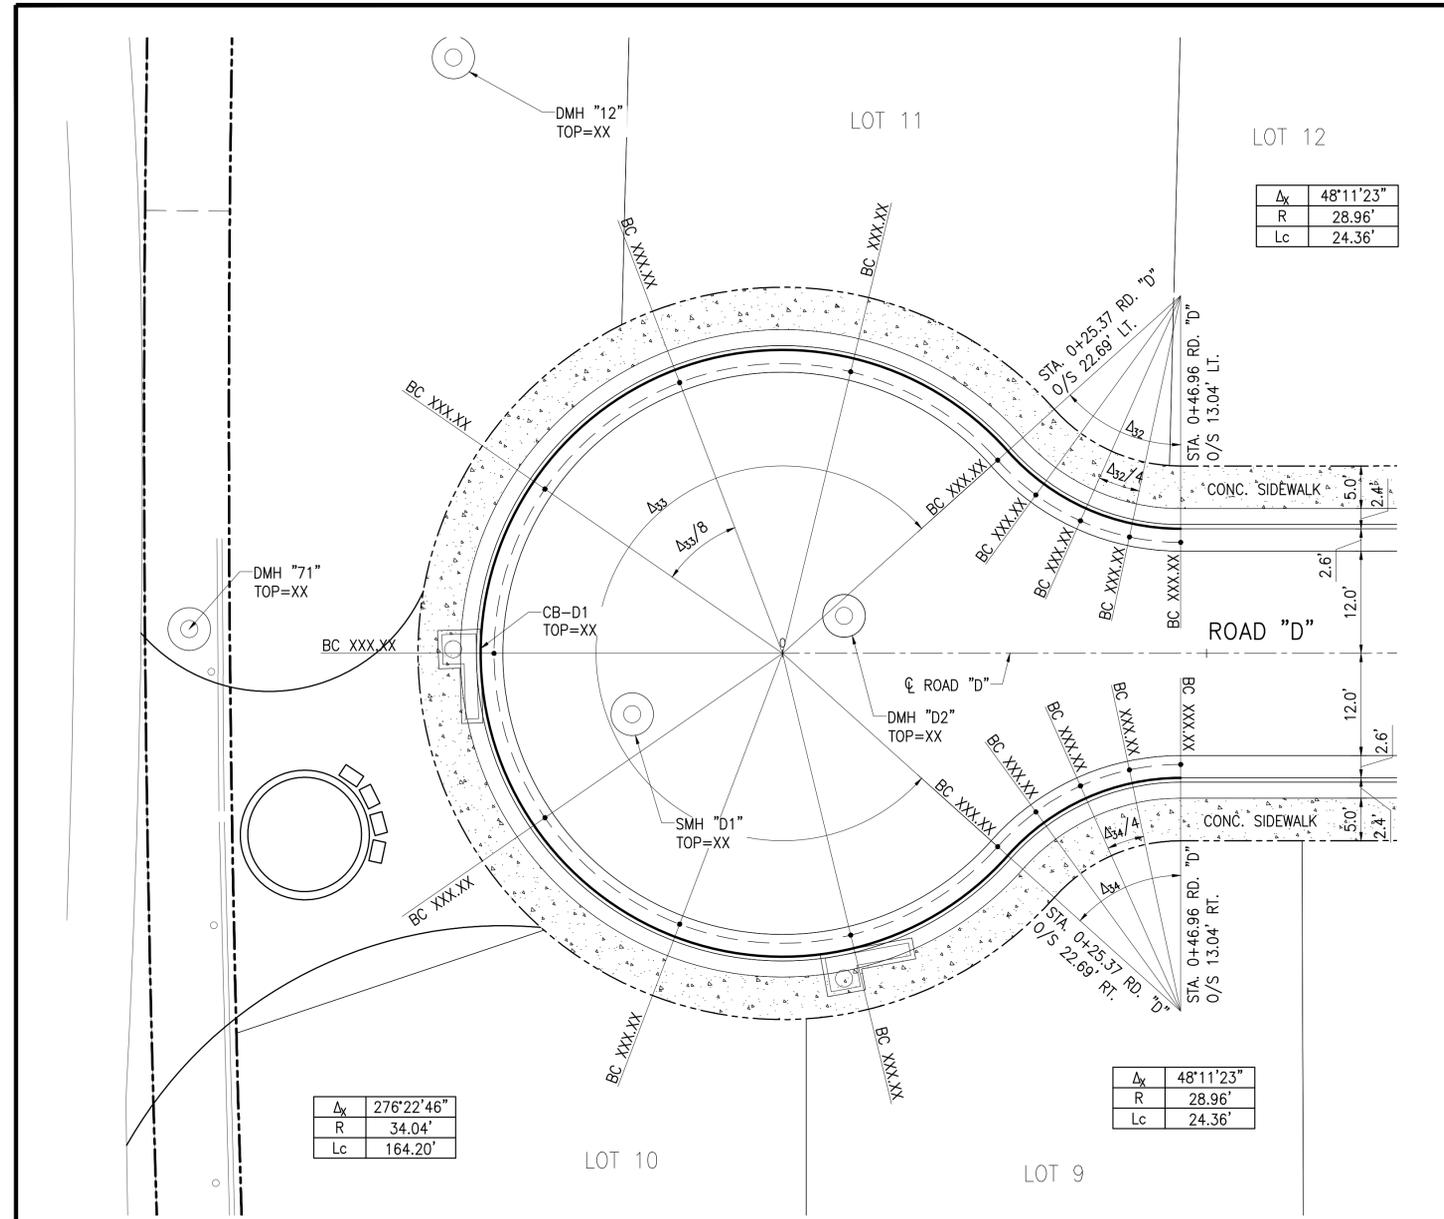
CURB RETURN X - CUL-DE-SAC ROAD "C"
SCALE: 1"=10'

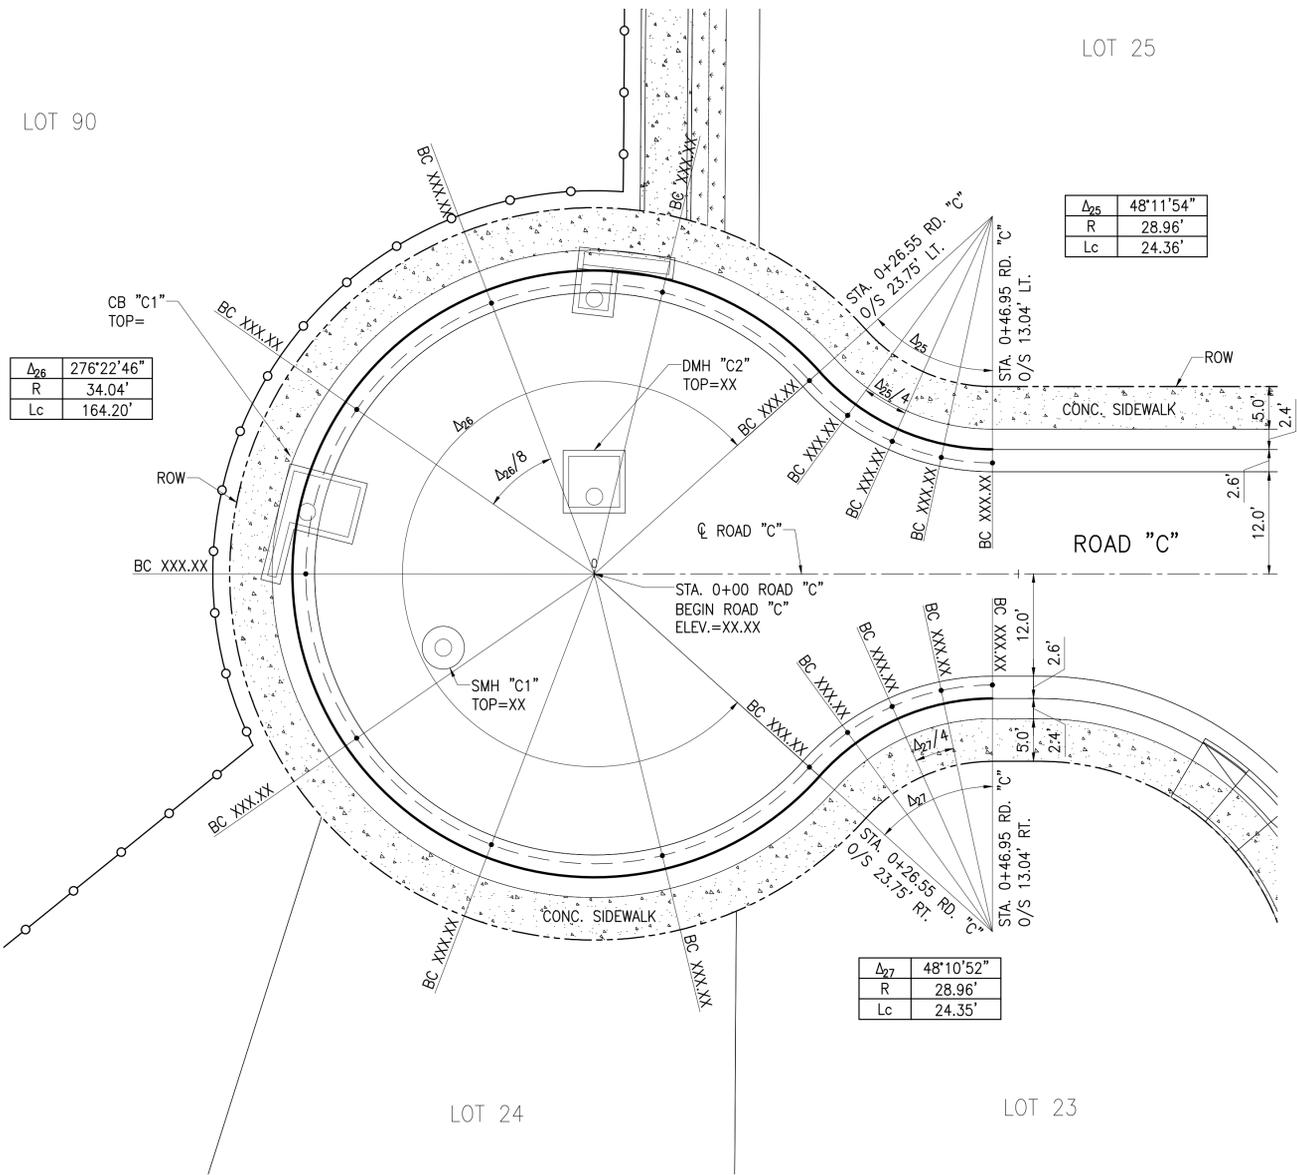


CURB RETURN X - ROAD "C" & ROAD "E"
SCALE: 1"=10'

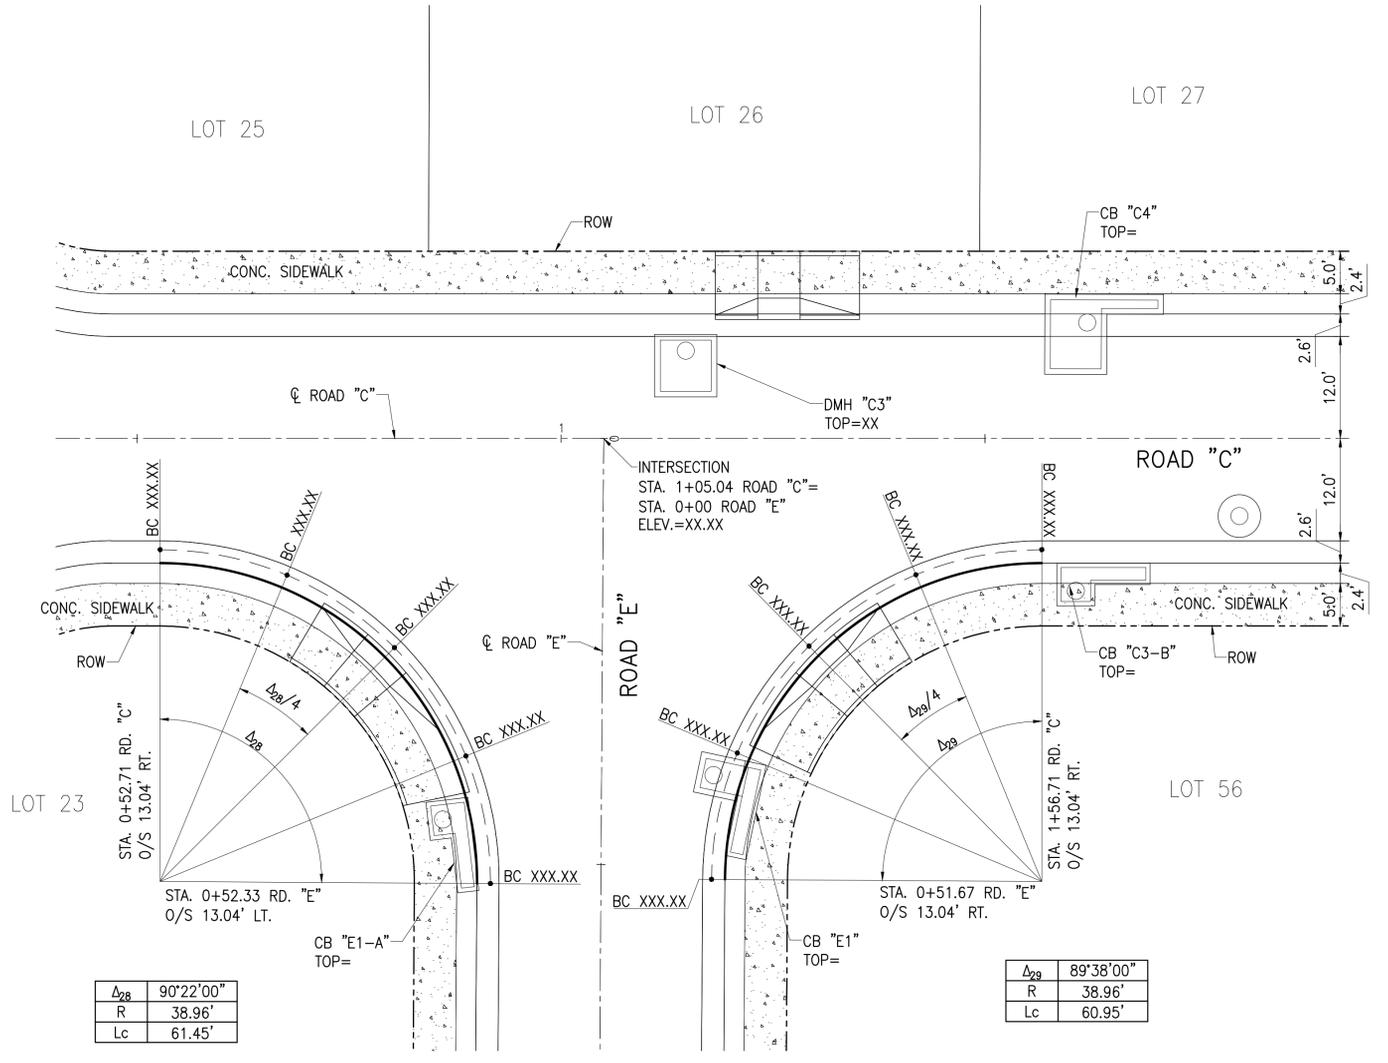A:\2018\18-522\dwg\c505 CURB AND CURVE RETURN DETAILS - 5.dwg

|  <p>ADRIENNE W. L.H. HOAG LICENSED PROFESSIONAL ENGINEER No. 6378 HAWAII, U.S.A.</p> <p>THIS WORK WAS PREPARED BY ME OR UNDER MY SUPERVISION AND CONSTRUCTION OF THIS PROJECT WILL BE UNDER MY OBSERVATION AS DEFINED IN SECTION 16-115-2, HAWAII ADMINISTRATIVE RULES, DEPARTMENT OF COMMERCE AND CONSUMER AFFAIRS, STATE OF HAWAII, PROFESSIONAL ENGINEERS, ARCHITECTS, SURVEYORS AND LANDSCAPE ARCHITECTS.</p> <p>LICENSE EXPIRES: APRIL 30, 2024</p> <p>0 1 2 LINE IS 2 INCHES AT FULL SIZE (IF NOT 2-INCHES : SCALE ACCORDINGLY)</p> <p>DWG. NO. C-505</p> <p>SHEET 57 OF</p> | <table border="1"> <tr><th>REVISION</th><th>DATE</th><th>BRIEF</th><th>MADE BY</th><th>APPROVED</th></tr> <tr><td> </td><td> </td><td> </td><td> </td><td> </td></tr> </table> | REVISION | DATE | BRIEF | MADE BY | APPROVED | | | | | |
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| | REVISION | DATE | BRIEF | MADE BY | APPROVED | | | | | | |
| | | | | | | | | | | | |
| | <p>ATA AUSTIN, TSUTSUMI & ASSOCIATES, INC. ENGINEERS, SURVEYORS • HONOLULU, WAILUKU, HAWAII</p> <p>DEPARTMENT OF HAWAIIAN HOME LANDS</p> <p>VILLAGES OF LEIALI'I, PHASE 1B</p> <p>TAX MAP KEY: (2) 4-5-21: 020 LAHAINA, MAUI, HAWAII</p> <p>CURB AND CURVE RETURN DETAILS - 5</p> | <table border="1"> <tr><td>DESIGNED BY: KM</td><td>DRAWN BY: ATA</td><td>CHECKED BY: AW</td></tr> <tr><td>APPROVED BY:</td><td colspan="2">SUBMITTED BY:</td></tr> <tr><td>DATE:</td><td>FIRM NUMBER:</td><td>DATE:</td></tr> </table> | DESIGNED BY: KM | DRAWN BY: ATA | CHECKED BY: AW | APPROVED BY: | SUBMITTED BY: | | DATE: | FIRM NUMBER: | DATE: |
| DESIGNED BY: KM | DRAWN BY: ATA | CHECKED BY: AW | | | | | | | | | |
| APPROVED BY: | SUBMITTED BY: | | | | | | | | | | |
| DATE: | FIRM NUMBER: | DATE: | | | | | | | | | |
| <p>DATE: SEPTEMBER 2023</p> <table border="1"> <tr><th>FILE</th><th>POCKET</th><th>FOLDER</th><th>NO.</th></tr> <tr><td> </td><td> </td><td> </td><td> </td></tr> </table> | FILE | POCKET | FOLDER | NO. | | | | | | | |
| FILE | POCKET | FOLDER | NO. | | | | | | | | |
| | | | | | | | | | | | |
| | | | | | | | | | | | |



CURB RETURN X - CUL-DE-SAC ROAD "D"
SCALE: 1"=10'

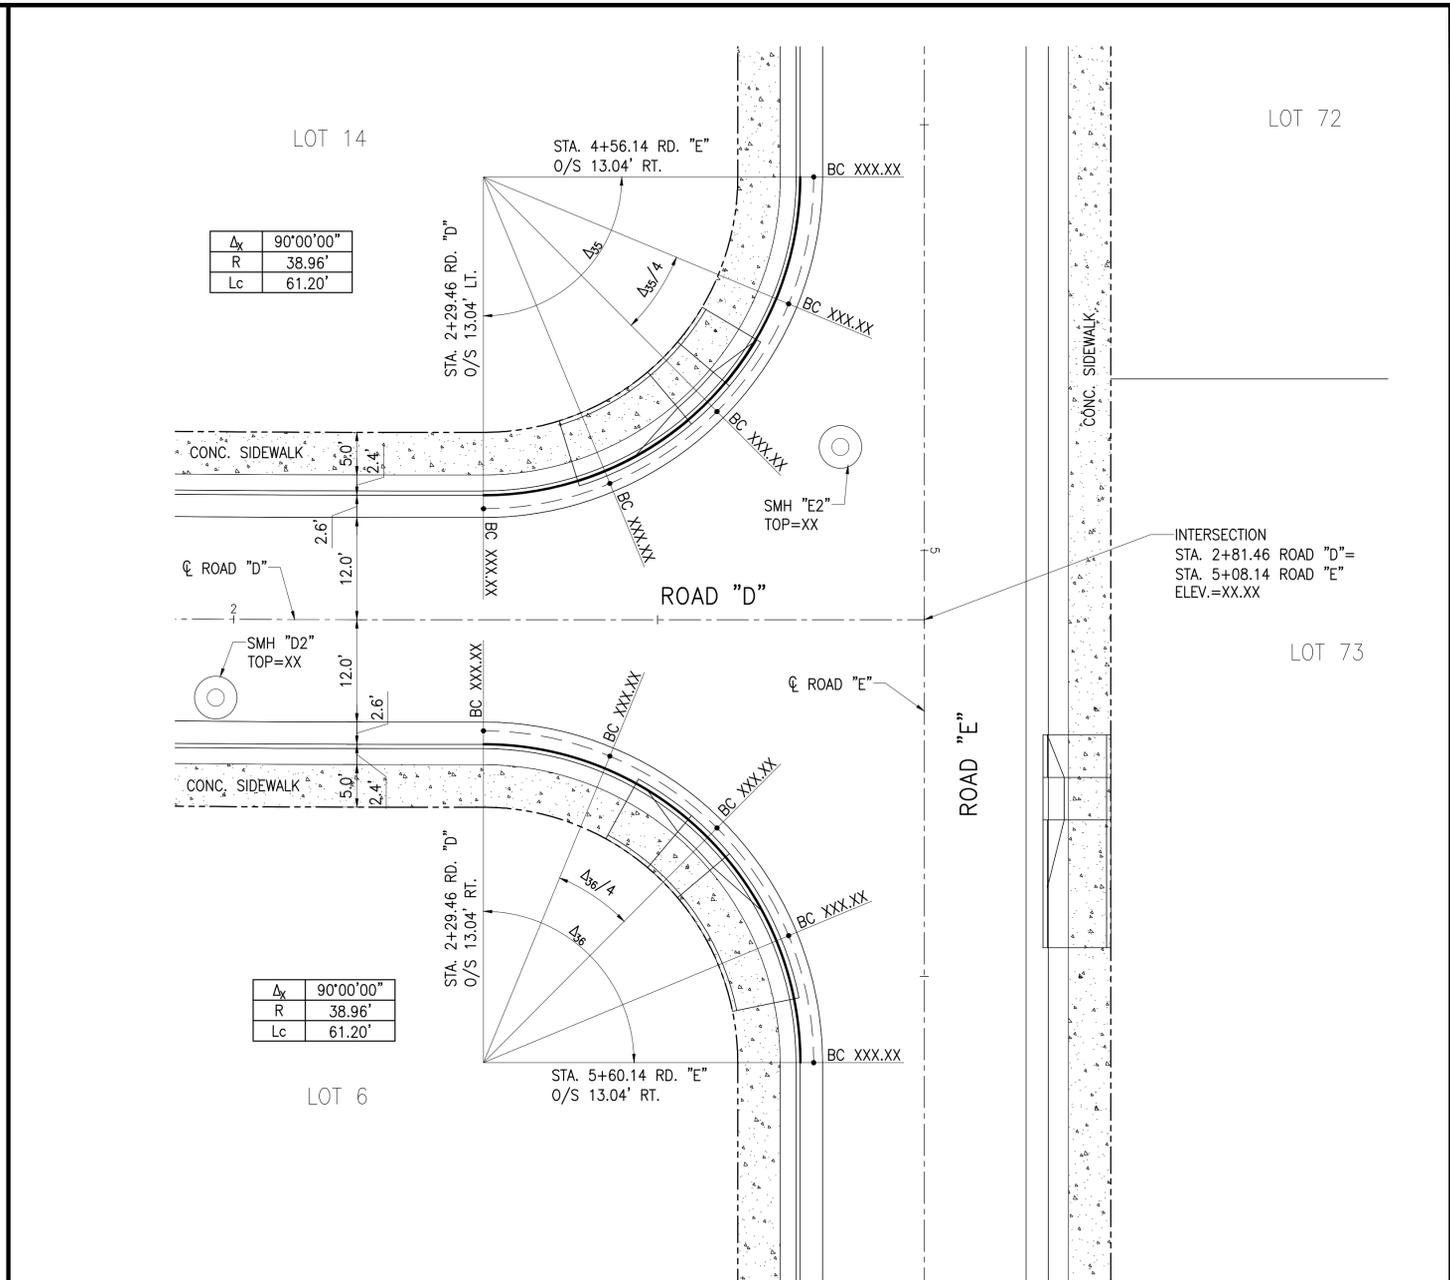

CURB RETURN X - ROAD "D" & ROAD "E"
SCALE: 1"=10'

A:\2023\18-522\DWG\C-507 CURB AND CURVE RETURN DETAILS - 7 - .dwg

ADRIENNE W. L.H. HOOG
LICENSED PROFESSIONAL ENGINEER
No. 6378
HAWAII, U.S.A.


THIS WORK WAS PREPARED BY ME OR UNDER MY SUPERVISION AND CONSTRUCTION OF THIS PROJECT WILL BE UNDER MY OBSERVATION AS DEFINED IN SECTION 16-115-2, HAWAII ADMINISTRATIVE RULES, DEPARTMENT OF COMMERCE AND CONSUMER AFFAIRS, STATE OF HAWAII. PROFESSIONAL ENGINEERS, ARCHITECTS, SURVEYORS AND LANDSCAPE ARCHITECTS.

LICENSE EXPIRES: APRIL 30, 2024


0 1 2
LINE IS 2 INCHES AT FULL SIZE
(IF NOT 2-INCHES : SCALE ACCORDINGLY)

DWG. NO. **C-507**
SHEET 59 OF

| REVISION | DATE | BRIEF | MADE BY | APPROVED | |
|---------------------------------------------------------------------------------------------------------------------------------------------------------------------------------------------------------------------------------------------------------------------------------------------------|------|--------------|---------|------------|----|
| <p>ATA AUSTIN, TSUTSUMI & ASSOCIATES, INC. ENGINEERS, SURVEYORS • HONOLULU, WAILUKU, HAWAII</p> <p>DEPARTMENT OF HAWAIIAN HOME LANDS</p> <p>VILLAGES OF LEIALI'I, PHASE 1B TAX MAP KEY: (2) 4-5-21: 020 LAHAINA, MAUI, HAWAII</p> <p>CURB AND CURVE RETURN DETAILS - 7</p> | | | | | |
| DESIGNED BY | KM | DRAWN BY | ATA | CHECKED BY | AW |
| APPROVED BY | | SUBMITTED BY | | | |
| DATE | | FIRM NUMBER | | DATE | |

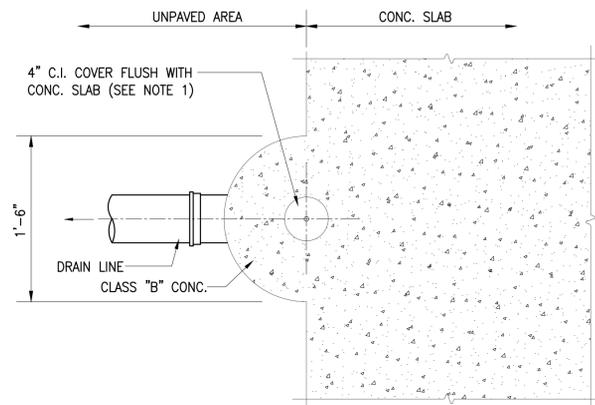


PLAN

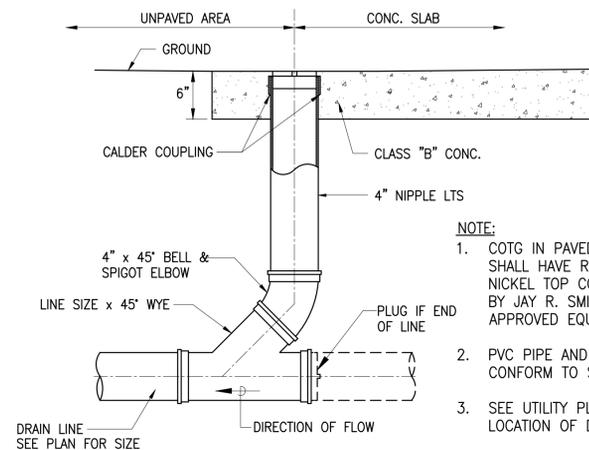


SECTION A-A

DRAINLINE CLEANOUT TO GRADE DETAIL
NOT TO SCALE


- NOTE:
1. COTG IN PAVED OR CONCRETE AREAS SHALL HAVE ROUND HEAVY DUTY NICKEL TOP COVER AS MANUFACTURED BY JAY R. SMITH COMPANY OR APPROVED EQUAL.
 2. PVC PIPE AND FITTINGS SHALL CONFORM TO SDR 35.
 3. SEE UTILITY PLAN FOR SIZE AND LOCATION OF DRAIN LINE

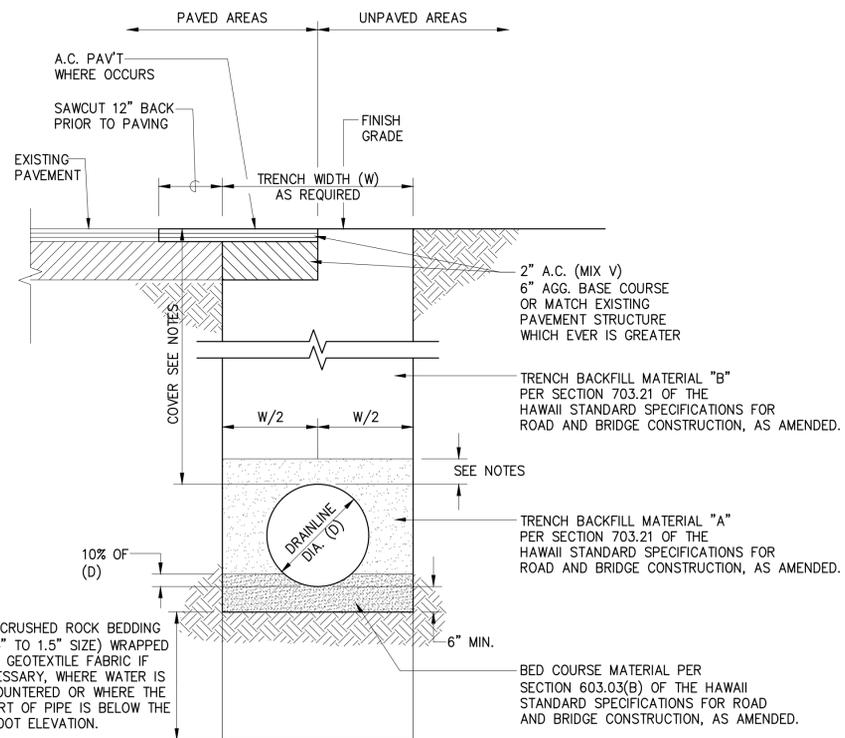


TYPICAL TRENCH RESTORATION DETAIL FOR DRAINLINE
NOT TO SCALE

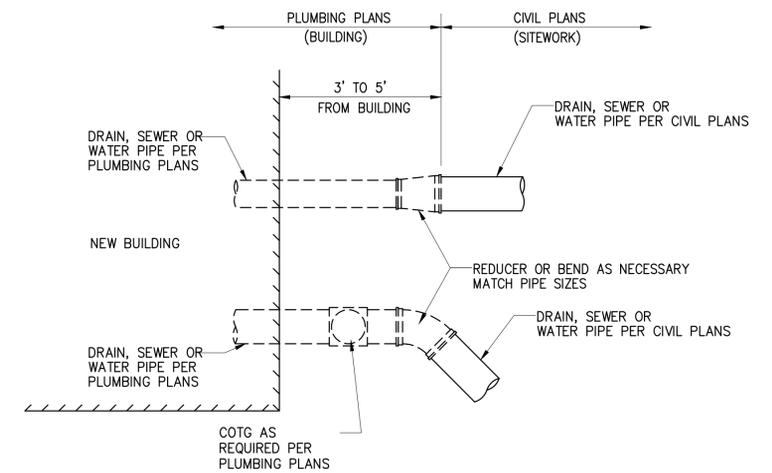


TYPICAL UTILITY POINT OF CONNECTION DETAIL
NOT TO SCALE

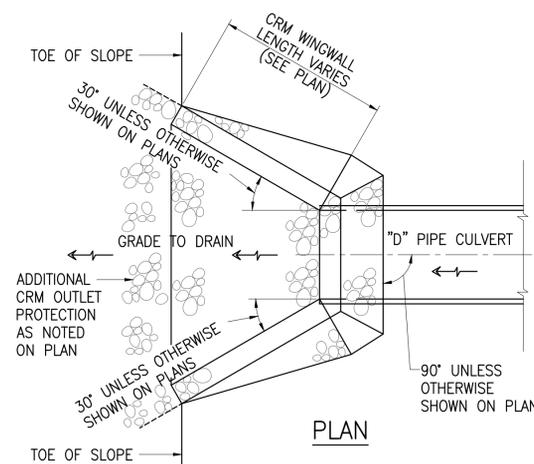

PLAN

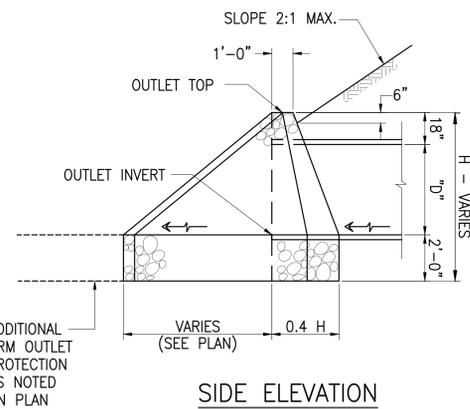


SIDE ELEVATION

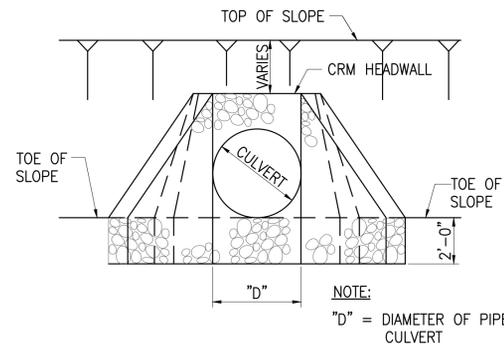

FRONT ELEVATION

CULVERT OUTLET HEADWALL DETAIL
NOT TO SCALE

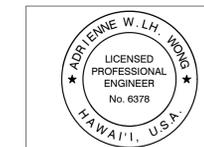


THIS WORK WAS PREPARED BY ME OR UNDER MY SUPERVISION AND CONSTRUCTION OF THIS PROJECT WILL BE UNDER MY OBSERVATION AS DEFINED IN SECTION 16-115-2, HAWAII ADMINISTRATIVE RULES, DEPARTMENT OF COMMERCE AND CONSUMER AFFAIRS, STATE OF HAWAII, PROFESSIONAL ENGINEERS, ARCHITECTS, SURVEYORS AND LANDSCAPE ARCHITECTS.

LICENSE EXPIRES: APRIL 30, 2024
0 1 2
LINE IS 2 INCHES AT FULL SIZE
(IF NOT 2-INCHES : Scale Accordingly)
DWG. NO. **C-508**
SHEET 60 OF

| REVISION | DATE | BRIEF | MADE BY | APPROVED | |
|------------------------------------------------------------------------------------------------------------------------------------------------------------------------------------------------------------------------------------------------------------|------|--------------|---------|------------|----|
| ATA AUSTIN, TSUTSUMI & ASSOCIATES, INC. ENGINEERS, SURVEYORS • HONOLULU, WAILUKU, HAWAII DEPARTMENT OF HAWAIIAN HOME LANDS VILLAGES OF LEIALI'I, PHASE 1B TAX MAP KEY: (2) 4-5-21: 020 LAHAINA, MAUI, HAWAII DRAINAGE DETAILS | | | | | |
| DESIGNED BY | KM | DRAWN BY | ATA | CHECKED BY | AW |
| APPROVED BY | | SUBMITTED BY | | | |
| DATE | | FIRM NUMBER | | DATE | |


DATE: SEPTEMBER 2023

| FILE | POCKET | FOLDER | NO. |
|------|--------|--------|-----|
| | | | |

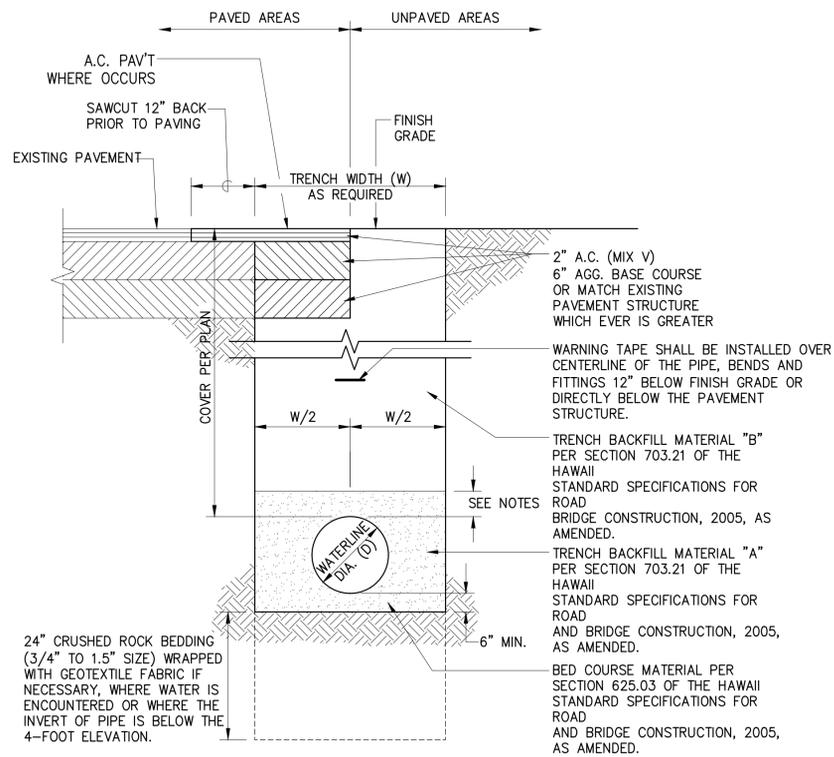


**TYPICAL TRENCH RESTORATION DETAIL
FOR WATER LINE PER DWS STD. P10**

NOT TO SCALE

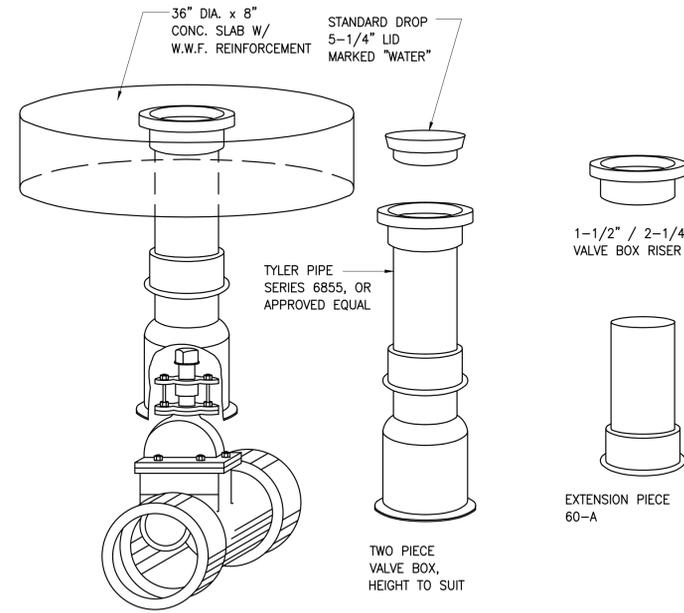


**SLIDING VALVE BOX ASSEMBLY
FOR GATE VALVES STD. DET. V12**

NOT TO SCALE

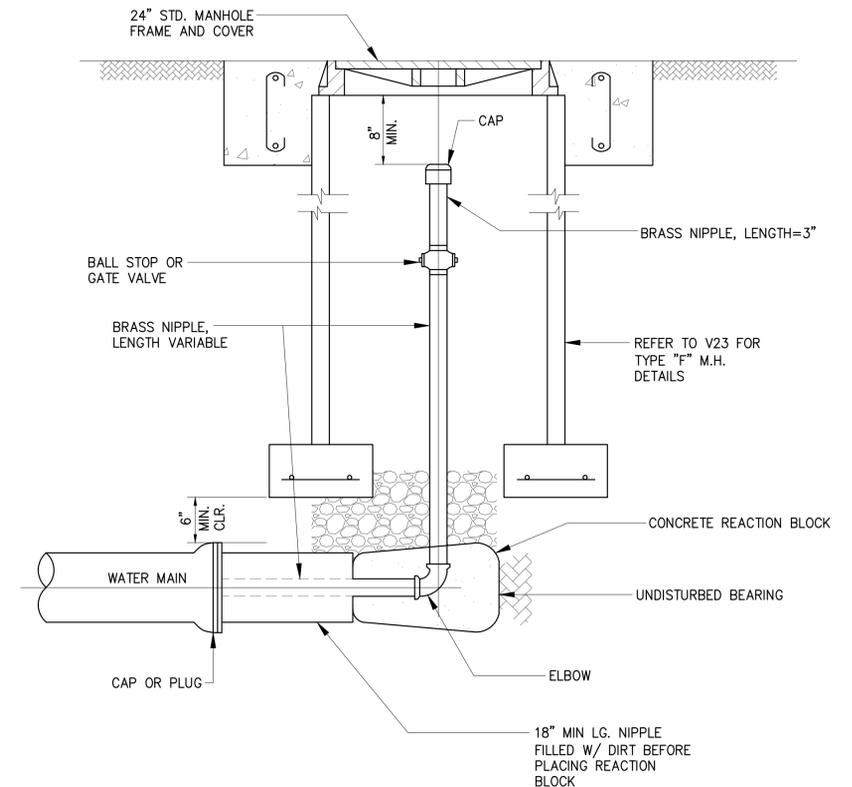


CLEANOUT

NOT TO SCALE

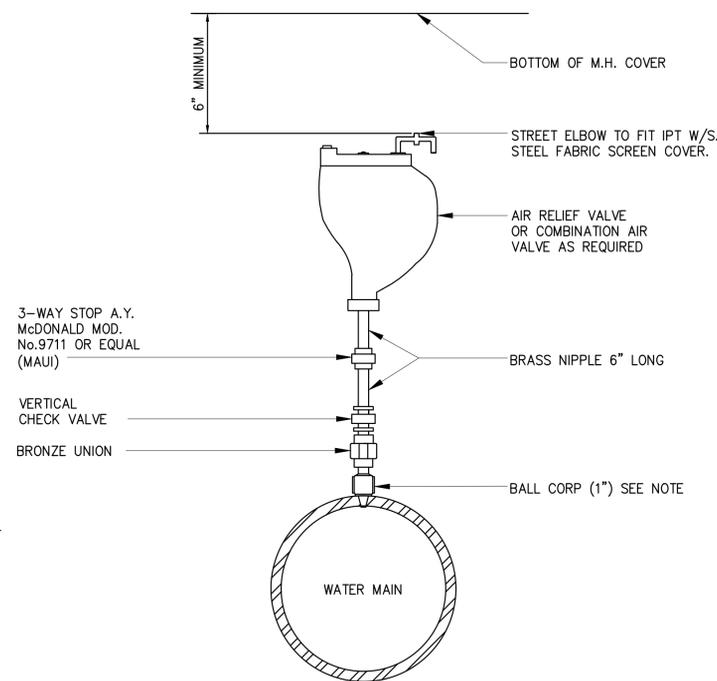

**STANDARD CONNECTION FOR
AIR RELIEF VALVE**

NOT TO SCALE

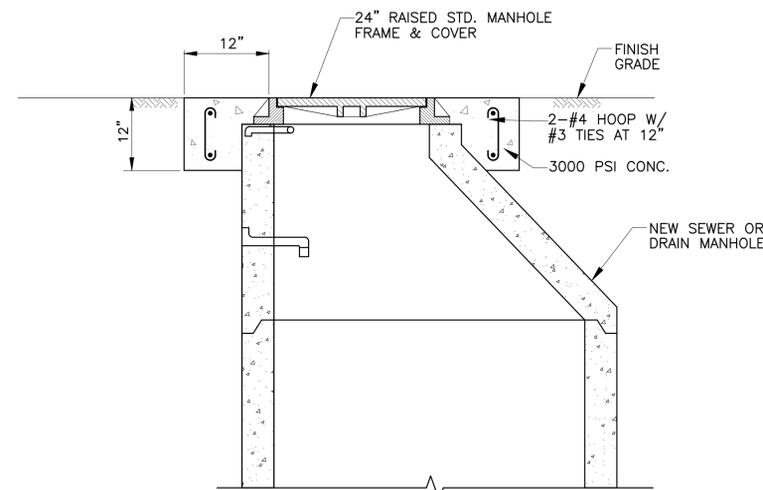

**CONC. COLLAR FOR SEWER, WATER,
AND DRAIN MANHOLES**

NOT TO SCALE

NOTE:

1. FOR 2" AIR RELIEF VALVE, SIZE OF BALL CORP., UNION, VERTICAL CHECK VALVE AND NIPPLE SHALL BE 2".
2. PROVIDE TYPE "F" MANHOLE V23 FOR BURIED INSTALLATION. (MAUI ONLY)
3. INSTALL PRECAST TYPE B OR TYPE C MANHOLE FOR VALVES (OHAU ONLY)
4. FOR COMBINATION AIR VALVE, IMMersed INSTALLATION NOT PERMITTED.



THIS WORK WAS PREPARED BY ME OR UNDER MY SUPERVISION AND CONSTRUCTION OF THIS PROJECT WILL BE UNDER MY OBSERVATION AS DEFINED IN SECTION 16-115-2, HAWAII ADMINISTRATIVE RULES, DEPARTMENT OF COMMERCE AND CONSUMER AFFAIRS, STATE OF HAWAII, PROFESSIONAL ENGINEERS, ARCHITECTS, SURVEYORS AND LANDSCAPE ARCHITECTS.

LICENSE EXPIRES: APRIL 30, 2024

0 1 2
LINE IS 2 INCHES AT FULL SIZE
(IF NOT 2-INCHES : Scale Accordingly)


DWG. NO. **C-509**

SHEET 61 OF

| REVISION | DATE | BRIEF | MADE BY | APPROVED |
|-----------------------------------------------------------------------------------------------------------------------------------------------------------------|------|--------------|---------|------------|
| ATA AUSTIN, TSUTSUMI & ASSOCIATES, INC. ENGINEERS, SURVEYORS • HONOLULU, WAILUKU, HAWAII | | | | |
| DEPARTMENT OF HAWAIIAN HOME LANDS VILLAGES OF LEIALI'I, PHASE 1B TAX MAP KEY: (2) 4-5-21: 020 LAHAINA, MAUI, HAWAII WATER DETAILS - 1 | | | | |
| DESIGNED BY | KM | DRAWN BY | ATA | CHECKED BY |
| APPROVED BY | | SUBMITTED BY | | |
| DATE | | FIRM NUMBER | | DATE |


DATE: SEPTEMBER 2023

| FILE | POCKET | FOLDER | NO. |
|------|--------|--------|-----|
| | | | |

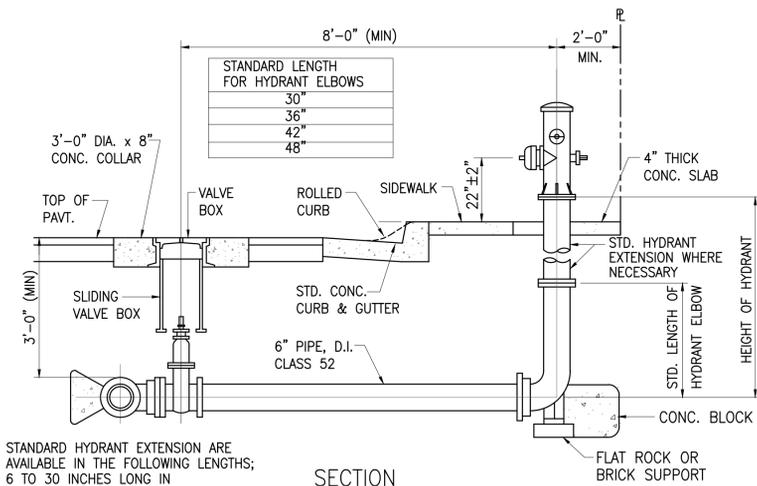


STANDARD HYDRANT EXTENSION ARE AVAILABLE IN THE FOLLOWING LENGTHS; 6 TO 30 INCHES LONG IN INCREMENTS OF 6 INCHES.

SECTION

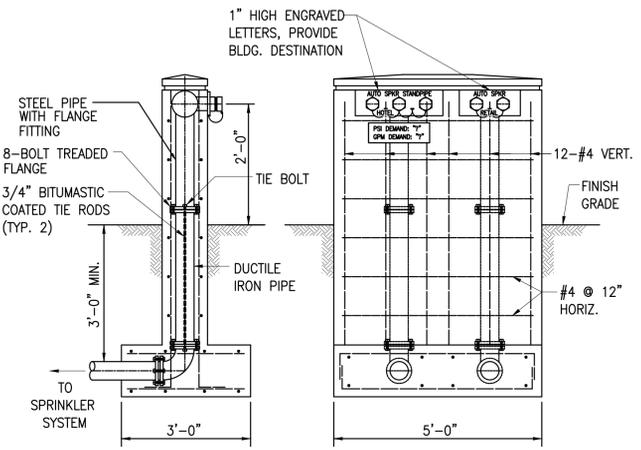

FIRE DEPARTMENT DOUBLE CONNECTION MONUMENT DETAIL
NOT TO SCALE

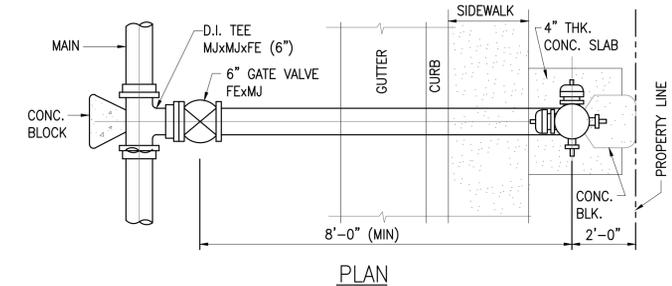


PLAN

- NOTES:
- GASKET FOR FLANGED JOINTS SHALL BE 1/8" DUCK-INSERT RUBBER PACKING GARLOCK NO. 19.
 - BOLTS SHALL BE BREAK-OFF TYPE 5/8" X 3" LONG MACHINE BOLTS WITH CUT THREADS, AMERICAN STANDARD COURSE HEXAGON HEAD, STAINLESS STEEL OR SILICON BRONZE. INSTALL BOLT WITH THREAD FACING UP.
 - NUTS SHALL BE AMERICAN STANDARD HEAVY COLD PUNCHED HEXAGON NUTS, STAINLESS STEEL OR SILICON BRONZE.
 - CONCRETE SHALL BE DWS 2500.
 - REFER TO PLATE FH11 FIRE HYDRANT INSTALLATION WITH CURB GUARD. (OAHU & KAUAI ONLY). FOR MAUI, REFER TO PLATE FH9 WHERE NO STREET CURBING.
 - FLANGED TEE IS OPTIONAL FOR OAHU, MANDATORY FOR KAUAI AND MAUI.
 - TAPPING SLEEVE WITH TAPPING VALVE ASSEMBLY MAY BE USED FOR CONNECTION TO EXISTING MAIN.
 - LUBRICATE HYDRANT NOZZLE THREADS WITH NON-TOXIC GREASE.
 - PROVIDE SLOTTED FLANGED RISER FOR HYDRANT AS NEEDED TO ALIGN 4-1/2" NOZZLE PERPENDICULAR TO CURB (FOR MAUI ONLY).
 - INSTALL HYDRANT MARKERS (SEE PLATES FH12 AND FH13).
 - WHERE THERE IS NO SIDEWALK, THE 4" CONCRETE PAD SHALL MEASURE 42" FRONT-TO-BACK AND 36" ALONG THE PROPERTY LINE, WITH TOP ELEVATION 2" ABOVE THE GRADED SHOULDER.
 - REPLACE PLASTIC VALVE BOX WITH CAST IRON FRAME & COVER IF SUBJECT TO TRAFFIC.

HYDRANT CONNECTION STRAIGHT RUN DETAIL DWS. DET. FH6
NOT TO SCALE


| | | | | | |
|--------------------------------------------------------------------------------------------------------------------------------------------------------------------------------------------------------------------------------------------------------------------------------------------------------------------------------------------------------------------------------------------------------------------------------------------------------------|--------------------------------------------------------------------------------------------------------------------------------------------------------------------------------------------------------------------------------------------------------------------------------------|------------------------------------------------|---------------------------------------------|------------------------------|----------|
| | REVISION | DATE | BRIEF | MADE BY | APPROVED |
| | <p>ATA AUSTIN, TSUTSUMI & ASSOCIATES, INC. ENGINEERS, SURVEYORS • HONOLULU, WAILUKU, HAWAII</p> <p>DEPARTMENT OF HAWAIIAN HOME LANDS</p> <p>VILLAGES OF LEIALI'I, PHASE 1B</p> <p>TAX MAP KEY: (2) 4-5-21: 020 LAHAINA, MAUI, HAWAII</p> <p>WATER DETAILS - 2</p> | | | | |
| <p>THIS WORK WAS PREPARED BY ME OR UNDER MY SUPERVISION AND CONSTRUCTION OF THIS PROJECT WILL BE UNDER MY OBSERVATION AS DEFINED IN SECTION 16-115-2, HAWAII ADMINISTRATIVE RULES, DEPARTMENT OF COMMERCE AND CONSUMER AFFAIRS, STATE OF HAWAII, PROFESSIONAL ENGINEERS, ARCHITECTS, SURVEYORS AND LANDSCAPE ARCHITECTS.</p> <p>LICENSE EXPIRES: APRIL 30, 2024</p> <p>0 1 2 LINE IS 2 INCHES AT FULL SIZE (If NOT 2-inches : Scale Accordingly)</p> | | | | | |
| <p>DESIGNED BY: KM</p> | | <p>DRAWN BY: ATA</p> | | <p>CHECKED BY: AW</p> | |
| <p>DWG. NO. C-510</p> | | | <p>APPROVED BY _____ SUBMITTED BY _____</p> | | |
| <p>SHEET 62 OF</p> | | <p>DATE _____ FIRM NUMBER _____ DATE _____</p> | | | |

A:\2023\18-522\DWG\C-510_MSDR_DET.DWG - 2.dwg

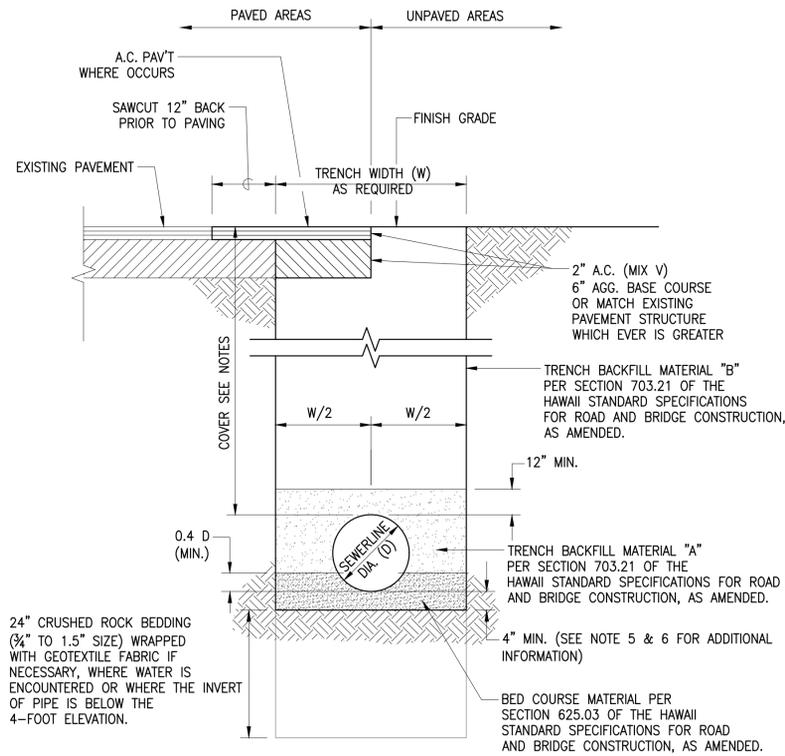


TYPICAL TRENCH RESTORATION DETAIL FOR SEWERLINE
NOT TO SCALE

NOTE:
TRAFFIC CLEANOUT TO GRADE DETAIL FOR AC PAVEMENT AREAS ONLY. CLEANOUTS LOCATED IN PCC PAVEMENT AREAS DO NOT HAVE A COLLAR AND PCC SHALL BE POURED UP TO CLEANOUT WITH TOP FLUSH WITH PAVEMENT.

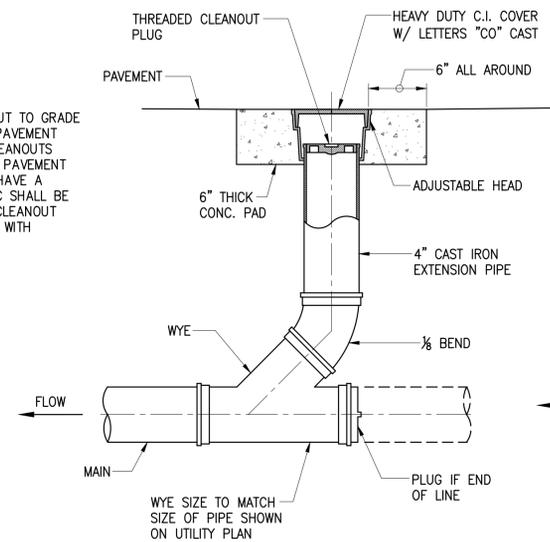


TRAFFIC (TYPE "A")

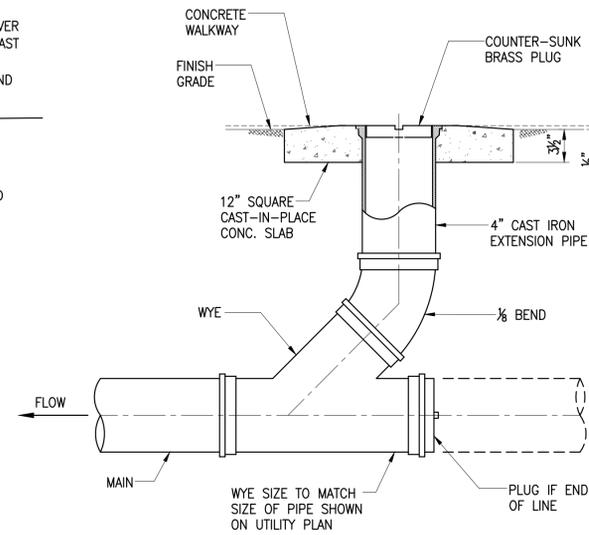


NON-TRAFFIC (TYPE "B")

CLEANOUT TO GRADE DETAIL
NOT TO SCALE

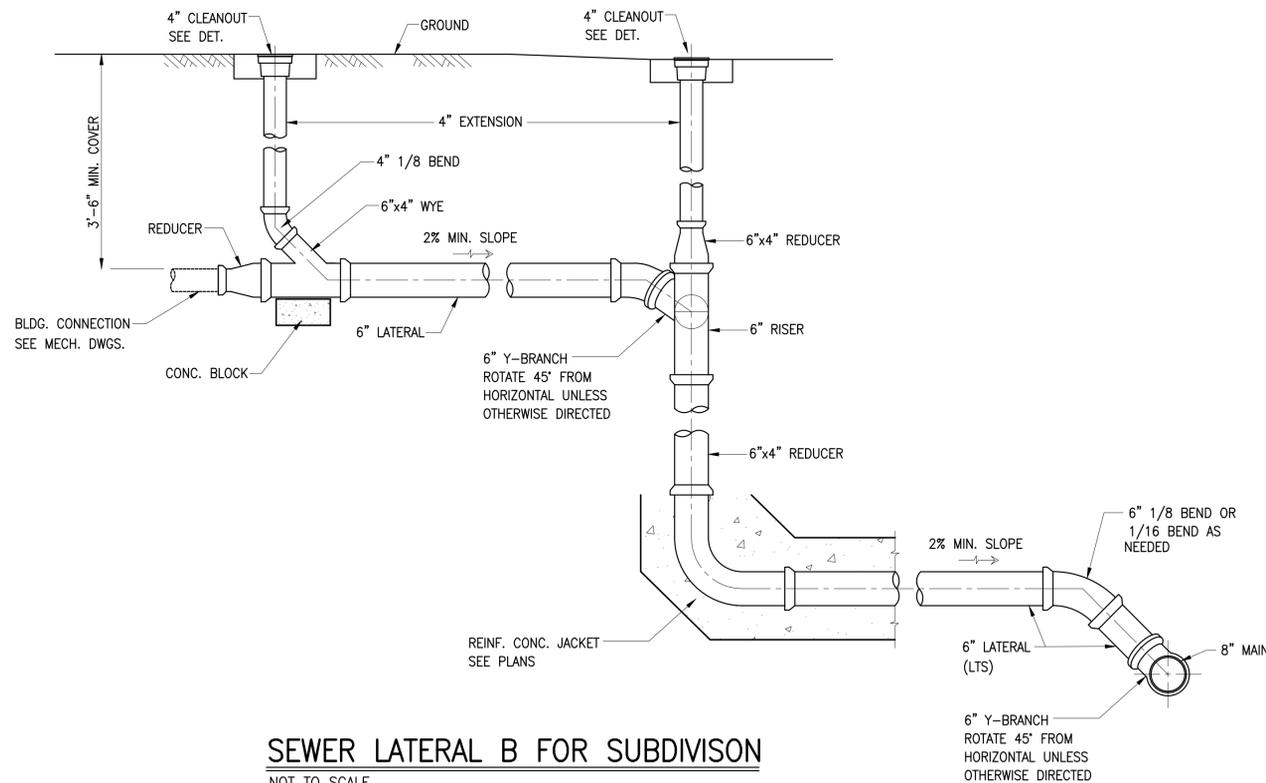

SEWER LATERAL B FOR SUBDIVISION
NOT TO SCALE

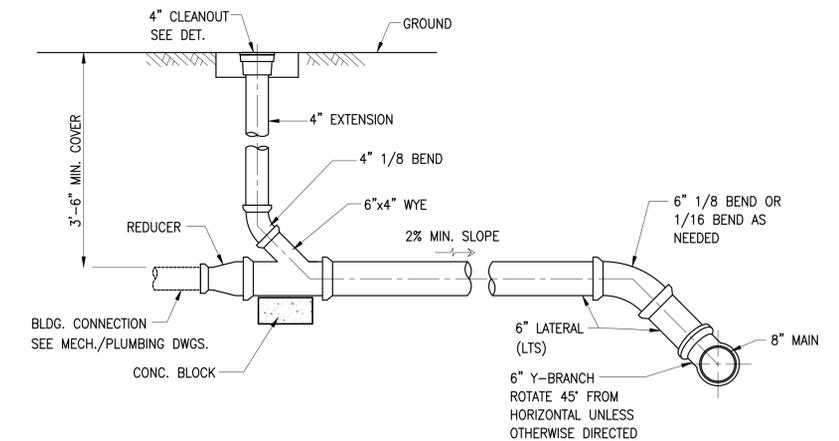

SEWER LATERAL A FOR SUBDIVISION
NOT TO SCALE



THIS WORK WAS PREPARED BY ME OR UNDER MY SUPERVISION AND CONSTRUCTION OF THIS PROJECT WILL BE UNDER MY OBSERVATION AS DEFINED IN SECTION 16-115-2, HAWAII ADMINISTRATIVE RULES, DEPARTMENT OF COMMERCE AND CONSUMER AFFAIRS, STATE OF HAWAII, PROFESSIONAL ENGINEERS, ARCHITECTS, SURVEYORS AND LANDSCAPE ARCHITECTS.

LICENSE EXPIRES: APRIL 30, 2024

0 1 2
LINE IS 2 INCHES AT FULL SIZE
(IF NOT 2-INCHES : Scale Accordingly)


DWG. NO. **C-511**

SHEET 63 OF

| REVISION | DATE | BRIEF | MADE BY | APPROVED | |
|----------------------------------------------------------------------------------------------------------------------------------------------------------------------------------------------------------------------------------------------------------------------------------|------|--------------|---------|------------|----|
| <p>ATA AUSTIN, TSUTSUMI & ASSOCIATES, INC. ENGINEERS, SURVEYORS • HONOLULU, WAILUKU, HAWAII</p> <p>DEPARTMENT OF HAWAIIAN HOME LANDS</p> <p>VILLAGES OF LEIALI'I, PHASE 1B</p> <p>TAX MAP KEY: (2) 4-5-21: 020 LAHAINA, MAUI, HAWAII</p> <p>SEWER DETAILS</p> | | | | | |
| DESIGNED BY | KM | DRAWN BY | ATA | CHECKED BY | AW |
| APPROVED BY | | SUBMITTED BY | | | |
| DATE | | FIRM NUMBER | | DATE | |

DATE: SEPTEMBER 2023


| FILE | POCKET | FOLDER | NO. |
|------|--------|--------|-----|
| | | | |

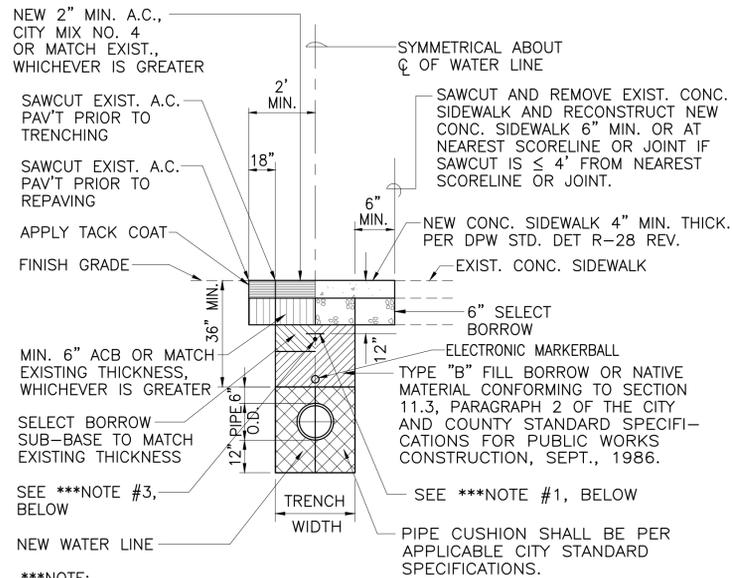

- ***NOTE:**
1. INSTALL 4 MIL. THICK BLUE COLORED WARNING TAPE 6" WIDE OVER CENTERLINE OF THE PIPE AND BELOW THE BASE COURSE ALONG THE ENTIRE LENGTH OF TRENCH. TAPE SHOULD BE MARKED WITH "CAUTION WATER LINE BURIED BELOW." THE TAPE SHALL BE A MINIMUM 12" BELOW THE FINISHED GRADE.
 2. THE CONTRACTOR SHALL COMPLY WITH ENGINEERING AND POLICY MEMORANDUM NO. CEB-1-09, JOINTING REQUIREMENTS FOR CONCRETE SIDEWALKS AND DRIVEWAYS, DATED: APRIL 1, 2009.



(CITY RIGHT OF WAY)

TRENCH RESTORATION DETAIL
NOT TO SCALE

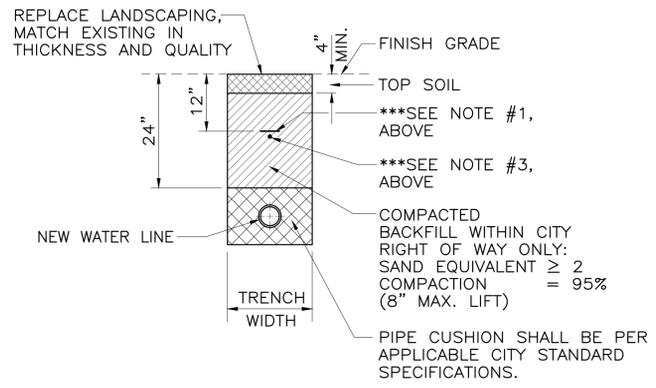


(GRASS CONDITION)

TYPICAL TRENCH RESTORATION DETAIL
NOT TO SCALE

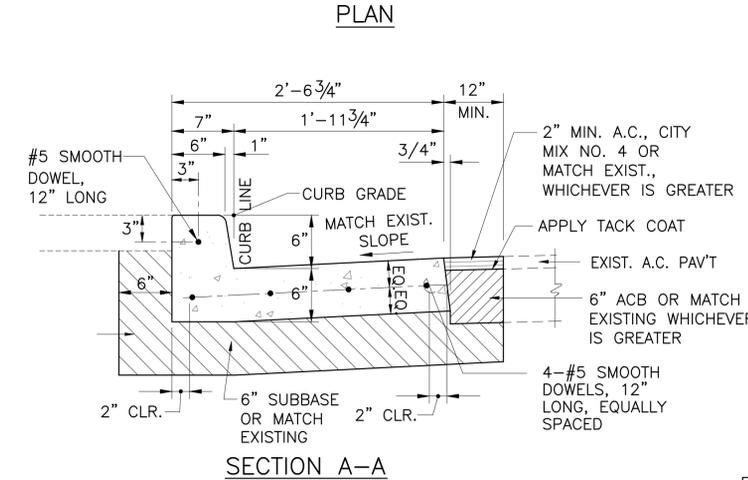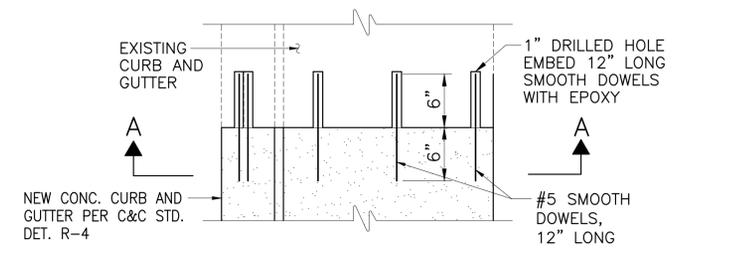


EXIST. CURB AND GUTTER TO NEW CURB AND GUTTER CONNECTION DETAIL
NOT TO SCALE


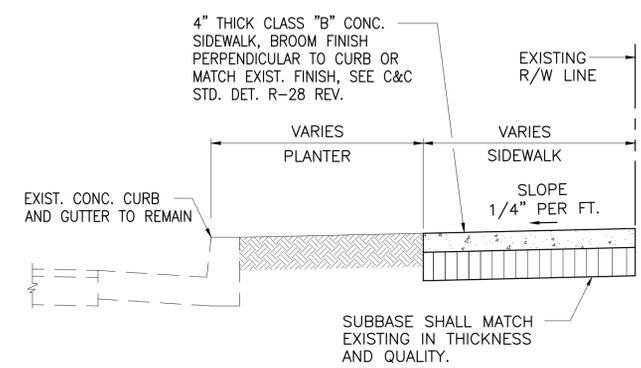


- NOTE:**
1. THE CONTRACTOR SHALL COMPLY WITH ENGINEERING AND POLICY MEMORANDUM NO. CEB-1-09, JOINTING REQUIREMENTS FOR CONCRETE SIDEWALKS AND DRIVEWAYS, DATED: APRIL 1, 2009.

SIDEWALK RESTORATION DETAIL
NOT TO SCALE

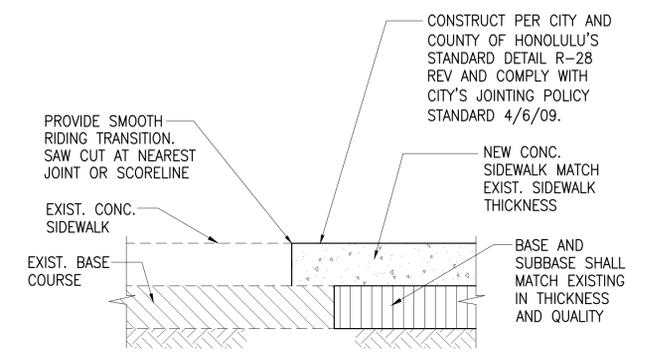


CONCRETE SIDEWALK CONNECTION DETAIL
NOT TO SCALE

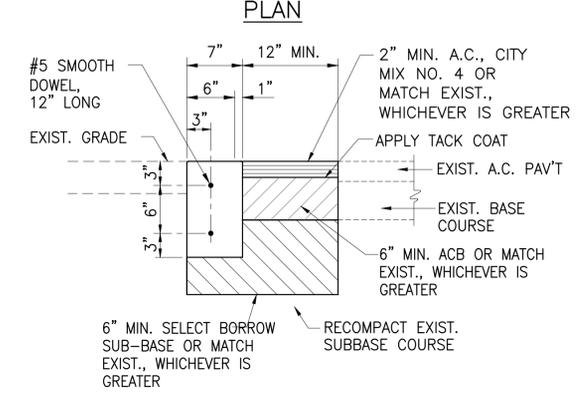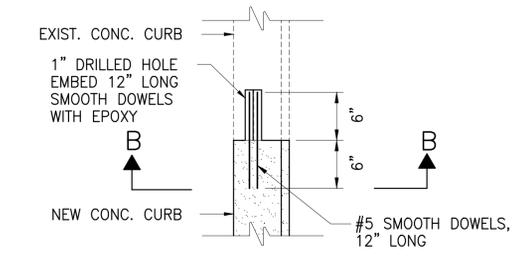

EXIST. CURB TO NEW CURB CONNECTION DETAIL
NOT TO SCALE


| | |
|---------------------------------------------------------------------------------------------------------------------------------------------------------------------------------|---------------------------------------------------------------------------------------------------------------------------------------------------------------------------|
| <p>LICENSE EXPIRES: APRIL 30, 2024</p> <p>0 1 2 LINE IS 2 INCHES AT FULL SIZE (if NOT 2-inches : Scale Accordingly)</p> <p>DWG. NO. C-513</p> <p>SHEET 65 OF</p> | <p>REVISION DATE BRIEF MADE BY APPROVED</p> |
| | <p>ATA AUSTIN, TSUTSUMI & ASSOCIATES, INC. ENGINEERS, SURVEYORS • HONOLULU, WAILUKU, HAWAII</p> |
| | <p>DEPARTMENT OF HAWAIIAN HOME LANDS</p> <p>VILLAGES OF LEIALI'I, PHASE 1B</p> <p>TAX MAP KEY: (2) 4-5-21: 020 LAHAINA, MAUI, HAWAII</p> <p>MISCELLANEOUS DETAILS</p> |
| | <p>DESIGNED BY KM DRAWN BY ATA CHECKED BY AW</p> <p>APPROVED BY _____ SUBMITTED BY _____</p> <p>DATE _____ FIRM NUMBER _____ DATE _____</p> |

NOTE: DIMENSIONS MEASURED ALONG BACK OF SIDEWALK OR AT PROPERTY LINE.

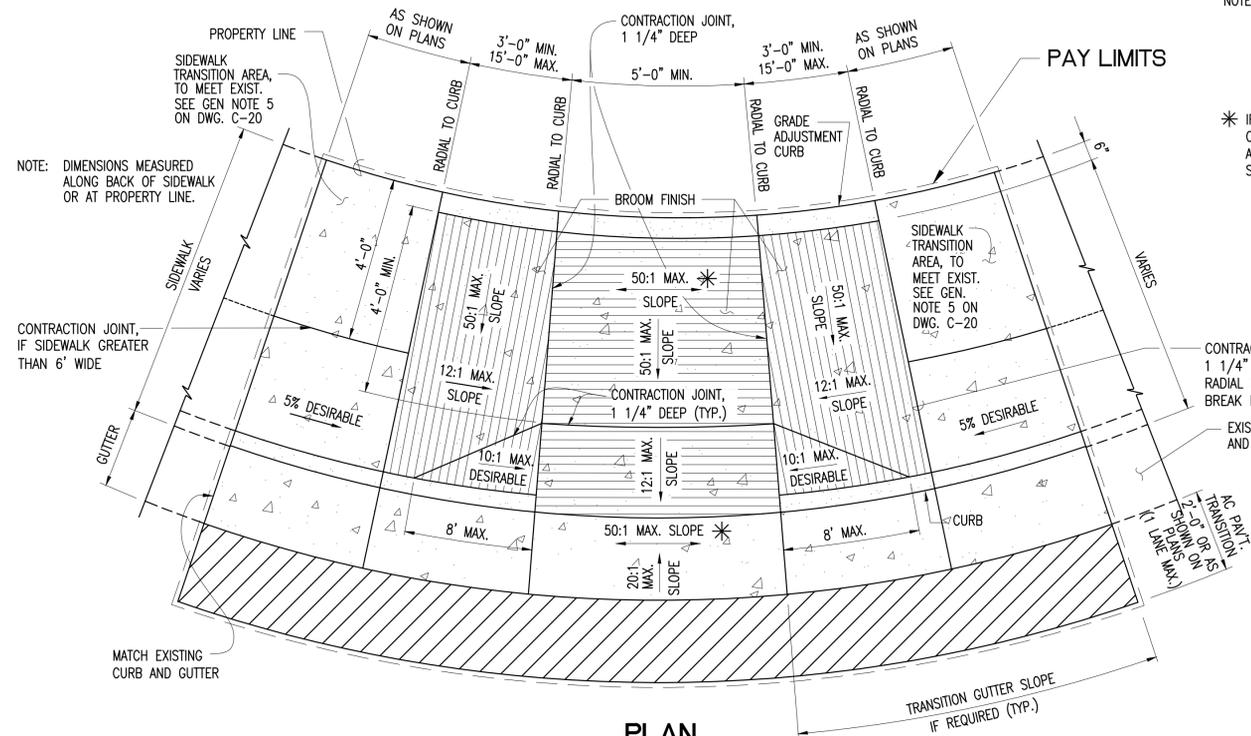


PLAN

SCALE: 1/2"=1'-0"

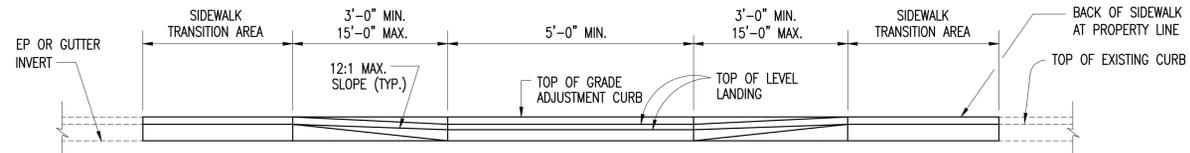

ELEVATION

SCALE: 1/2"=1'-0"

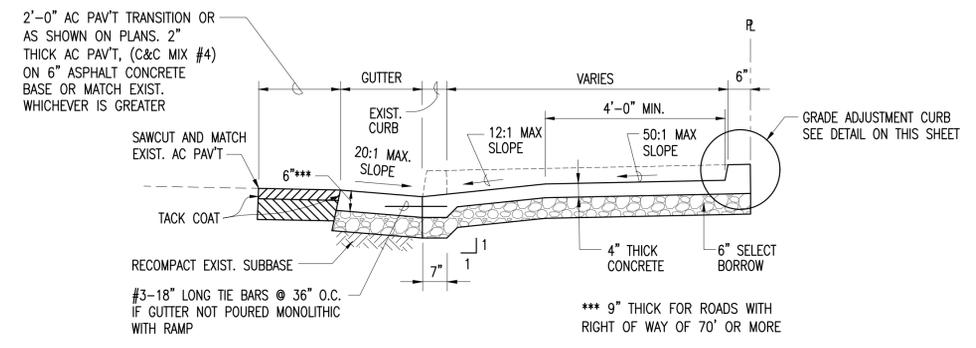


SECTION AT LANDING

SCALE: 1/2"=1'-0"


CURB RAMP - TYPE "B" (TRUNCATED)

* IF ROADWAY SLOPE > 2%, CONFORM TO ROADWAY SLOPE AND TECHNICAL INFEASIBILITY STATEMENT.

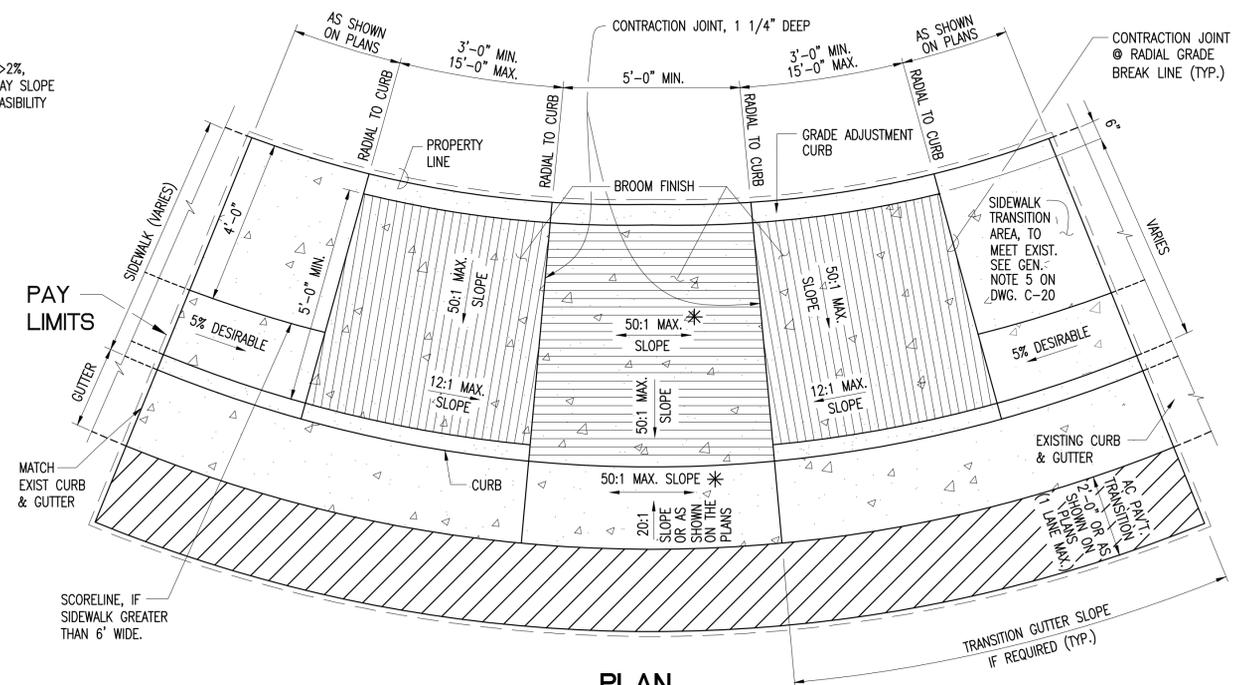


PLAN

SCALE: 1/2"=1'-0"

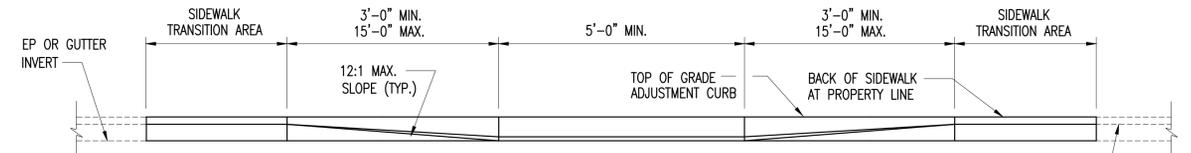

ELEVATION


SCALE: 1/2"=1'-0"

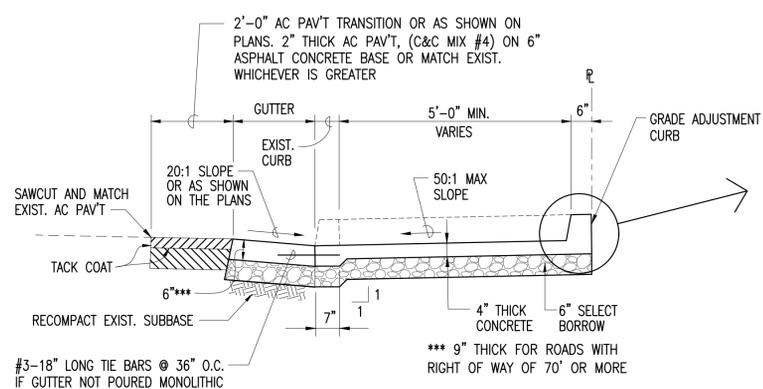

SECTION AT LANDING

SCALE: 1/2"=1'-0"

CURB RAMP - TYPE "B"

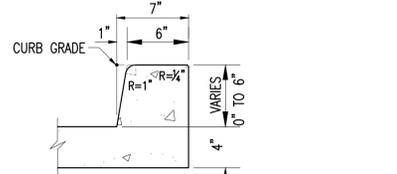

DETAIL - GRADE ADJUSTMENT CURB

SCALE: 1 1/2"=1'-0"



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LICENSE EXPIRES: APRIL 30, 2024

LINE IS 2 INCHES AT FULL SIZE (IF NOT 2-INCHES : Scale Accordingly)

DWG. NO. **C-514**

SHEET 22 OF

| REVISION | DATE | BRIEF | MADE BY | APPROVED | |
|-----------------------------------------------------------------------------------------------------------------------------------------------------------------------------------------------------------------------------------------------------------------------------------------|------|--------------|---------|------------|----|
| <p>ATA AUSTIN, TSUTSUMI & ASSOCIATES, INC. ENGINEERS, SURVEYORS • HONOLULU, WAILUKU, HAWAII</p> <p>DEPARTMENT OF HAWAIIAN HOME LANDS</p> <p>VILLAGES OF LEIALI'I, PHASE 1B</p> <p>TAX MAP KEY: (2) 4-5-21: 020 LAHAINA, MAUI, HAWAII</p> <p>CURB RAMP GRADES - 1</p> | | | | | |
| DESIGNED BY | KM | DRAWN BY | ATA | CHECKED BY | AW |
| APPROVED BY | | SUBMITTED BY | | | |
| DATE | | FIRM NUMBER | | DATE | |

DATE: SEPTEMBER 2023

| FILE | POCKET | FOLDER | NO. |
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| | | | |